

REVISION

GENERAL NOTES:

- 1. BASE INFORMATION WAS TAKEN FROM A SURVEY ENTITLED "VISUAL INSPECTION SURVEY", PREPARED BY LAND SURVEYOR ARISTOTLE BOURNAZOS, P.C. AND DATED SEPTEMBER 1, 2015. ADDITIONAL INFORMATION TAKEN FROM A DRAWING TITLED "BREATH OF SPRING LANDSCAPING", PREPARED BY MARY CONWAY DATED SEPTEMBER 9, 2020. 12. CONTRACTOR SHALL DISPOSE OF ALL DEBRIS AT AN APPROVED FACILITY.
- 2. STORMWATER MANAGEMENT SIZING IS BASED OFF OF ASSUMED PERCOLATION RATES. PERCOLATION AND DEEP 13. CONTAMINATED OR HAZARDOUS MATERIALS SHALL BE REMOVED AND DISPOSED OF IN ACCORDANCE WITH TEST PITS ARE REQUIRED TO BE CONDUCTED AND CERTIFIED BY A PROFESSIONAL ENGINEER.

CONSTRUCTION NOTES:

- 1. THE CONTRACTOR SHALL SECURE ALL APPLICABLE PERMITS.
- 2. THE CONTRACTOR SHALL CONTACT UFPO AT 1-800-962-7962 TO ORDER A UTILITIES MARK-OUT AND VERIFY ALL EXISTING UNDERGROUND UTILITIES AT LEAST 72 HOURS PRIOR TO THE START OF CONSTRUCTION. IT MAY BE NECESSARY TO CONTRACT A PRIVATE UTILITY MARK-OUT COMPANY FOR MARK-OUT OF UTILITIES ON PRIVATE
- 3. THE CONTRACTOR SHALL MAINTAIN THE EXISTING SITE ROADWAYS FREE OF DEBRIS AND SEDIMENT.
- 4. THE CONTRACTOR SHALL INSTALL AND MAINTAIN REQUIRED SEDIMENT AND EROSION CONTROL MEASURES IN ACCORDANCE WITH NYSDEC STANDARDS AND PROVIDE AN INSPECTION OF SUCH MEASURES ON A WEEKLY BASIS
- AND FOLLOWING ANY RAIN STORM GENERATING 0.5 INCHES OF RAINFALL OR GREATER. 5. PRIOR TO CONSTRUCTION, THE DEPTHS, SIZES, MATERIAL TYPES AND CONDITION OF EXISTING UTILITIES SHALL BE VERIFIED AND DISCREPANCIES REPORTED TO THE OWNER, IN WRITING.
- 6. THE CONTRACTOR SHALL BE RESPONSIBLE FOR ANY ON-SITE OR OFF-SITE DAMAGES TO PROPERTY OR VEGETATION CAUSED BY HIS OPERATIONS. SUCH DAMAGES SHALL BE REPAIRED OR REPLACED, AT THE CONTRACTORS EXPENSE, TO THE SATISFACTION OF THE OWNER OR AGENCY HAVING JURISDICTION.
- 7. CONTRACTOR SHALL MAINTAIN POSITIVE DRAINAGE TOWARDS EXISTING DRAINAGE INLETS AND/OR DRAINAGE CHANNELS IN ACCORDANCE WITH THE PLANS.
- 8. CONTRACTOR SHALL INSTALL PAVEMENT MARKING AS SHOWN ON PLANS UTILIZING SHERMAN WILLIAMS WATER BORNE PAVEMENT MARKING PAINT.
- 9. PARKING STRIPING SHALL BE 4" WIDE SINGLE WHITE LINE.
- 10. THE CONTRACTOR SHALL NOTIFY THE OWNER, IN WRITING, OF ANY CONDITIONS THAT DIFFER FROM THE PLANS.

- 11. THE CONTRACTOR SHALL BE RESPONSIBLE FOR ANY ON-SITE OR OFF-SITE DAMAGES TO PROPERTY OR VEGETATION CAUSED BY HIS OPERATIONS. SUCH DAMAGES SHALL BE REPAIRED OR REPLACED, AT THE CONTRACTORS EXPENSE, TO THE SATISFACTION OF THE OWNER OR AGENCY HAVING JURISDICTION.
- ENVIRONMENTAL PLANS AND/OR IN ACCORDANCE WITH REQUIREMENTS OF AGENCIES HAVING JURISDICTION. IT SHALL BE THE RESPONSIBILITY OF THE CONTRACTOR TO ADVISE THE OWNER, IN WRITING, OF ANY NON IDENTIFIED ENVIRONMENTAL CONDITIONS THAT ARE ENCOUNTERED.
- 14. STORMWATER PIPING SHALL BE HDPE N-12 DOUBLE WALL PIPE.
- 15. INLETS, FRAMES, AND GRATES SHALL BE RATED FOR N-20 VEHICLE LOADING.
- 16. ANY IMPORTED SOIL SHALL COMPLY WITH ALL FEDERAL, STATE, AND LOCAL REQUIREMENTS FOR QUALITY AND RESIDENTIAL PURPOSES.
- 17. THE APPLICANT'S DESIGN PROFESSIONAL SHALL INSPECT AND PROVIDE CONSTRUCTION COMPLIANCE CERTIFICATION OF ALL RETAINING WALLS PRIOR TO THE ISSUANCE OF A CERTIFICATE OF OCCUPANCY/COMPLETION FOR THE PROJECT.

BULK ZONING REQUIREMENTS VILLAGE OF MAMARONECK						
ITEM	UNITS	REQUIRED	EXISTING	PROVIDED		
ZONING DISTRICT		R-7.5	R-7.5	R-7.5		
MINIMUM LOT AREA	SQFT	7500	20112.65	20112.65		
MINIMUM LOT WIDTH AND FRONTAGE	FT	75	188.6/201.6	188.6/201.6		
MINIMUM LOT DEPTH	FT	100	100	100		
YARD - FRONT (1)	FT	25	8	8		
YARD - LESSER SIDE (2)	FT	8	30	0		
YARD - 2 SIDES COMBINED	FT	20	30	30		
YARD-REAR (1)	FT	30	7.9	7.9		
MAXIMUM BUILDING STORIES (1)	STORIES	2 1/2	4	4		
MAXIMUM BUILDING HEIGHT	FT	35	-	-		
MAXIMUM BUILDING COVERAGE (1)	%	35	38	38		
MAXIMUM FLOOR AREA RATIO (1)		0.27	1.52	1.52		

HATCH LEGEND	
EXISTING STRUCTURE	
PATIO/PERMEABLE PAVEMENT	
PLANTING AREA	

1. EXISTING NON-CONFORMITY 2. AREA VARIANCES HAVE BEEN GRANTED ON MARCH 24, 2023 WHICH ALLOWS THE APPLICANT TO: 2.1. INCREASE THE EXISTING NONCONFORMING BUILDING COVERAGE OF 38% BY AN ADDITIONAL 3.8% TO 41.8%

WHERE 35% IS PERMITTED 2.2. DECREASE THE SIDE YARD SETBACK TO 0 FEET WHERE 8 FEET IS REQUIRED.

WANTED BOILDING GOVERNOE (INGESTING WALLS)					
ITEM	UNITS	REQUIRED	EXISTING	PROVIDED	
MAXIMUM BUILDING COVERAGE	%	35	41.1	41.8	
	SF (COVERAGE AREA/TOTAL AREA)	7039.43/20112.65	8267.03/20112.65	8411.90/20112.65	

	MAXIMUM BUILDING COVERAGE (INCLUDING WALLS)				
ITEM	UNITS	REQUIRED	EXIST		
MAXIMUM BUILDING COVERAGE	%	35	41.		
	SF (COVERAGE AREA/TOTAL AREA)	7039.43/20112.65	8267.03/2		

_S52° 45' 17"W 201.55' CORB DROP CURB STONE STONE CNBB 201.6N6.7 CONC. CONC. WALK MALK САИОРУ **GOT** LEMCE ON TOP M\ LENCE ON STONE CURB W/ **PETAINING** NIAAQ~ YANOSAM S14.0N **DUIDJIUB TNEMTRA9A** BRICK & STONE **FOUR STORY 9 TO1** STEPS 8 JJAW_S CONC. BNIFDING BNILDING **TN3MTAAAA TN3MTAA9A** → LOT WALKWAY **PARKING** PART OF LOT GNAND ENTRY GATE STONE CURB \\\ CONC' 30.0 CONC. GRAVEL STONE MASONRY RETAINING WALL $\exists\exists \forall \mathsf{W}$ FOT 3 STONE MASONRY RETAININGS PATIO/PERMEABLE -PAVEMENT (790 SQFT) ─S52° 45' 17"W 125.70' DWELLING RETAINING WALL -- 4' ALUMINUM FENCE ON WALL A TOLAO TRAS GRAVEL GARAGE **JMAR** AREA

PER VILLAGE ENGINEER COMMENTS 9. PER VILLAGE CONSULTANT COMMENTS PER VILLAGE CONSULTANT COMMENTS

REVISION

DETAIL REVISION

ZONING TABLE REVISED

ZONING TABLE REVISED

ADJOINER MAP INCLUDED

LANDSCAPE REVISION

BUILDING COVERAGE UPDATED

ADDITIONAL DIMENSIONS INCLUDED

08.02.2021

05.16.2022

08.02.2022

08.16.2022

08.19.2022

10.12.2022

NO.

APPLICANT:


ARCHER PROPERTY **MANAGEMENT** 105 CALVERT STREET HARRISON NY 10528

One West Avenue, Suite 219, Larchmont, NY 10538 Tel.: (914) 269-8358 · www.catizoneengineering.com

BBQ/PATIO AREA IMPROVEMENTS 412 MUNRO AVENUE VILLAGE OF MAMARONECK COUNTY OF WESTCHESTER

TAX ID: 9-15-282

OVERALL LAYOUT PLAN

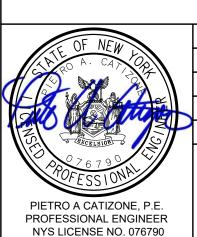

DATE: MAY 07, 2021 DRAWN BY: D.M.G. CHECKED BY: M.A.D. PROJECT NO.: 21001

SD-201

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- 2. STORMWATER MANAGEMENT SIZING IS BASED OFF OF ASSUMED PERCOLATION RATES. PERCOLATION AND DEEP TEST PITS ARE REQUIRED TO BE CONDUCTED AND CERTIFIED BY A PROFESSIONAL ENGINEER.

EROSION AND SEDIMENT CONTROL NOTES

FROM EROSION BY A SURROUNDING SILT FENCE.

- 1. SEDIMENT AND EROSION CONTROL INSTALLATION AND MAINTENANCE MEASURES SHALL MEET THE REQUIREMENTS OF THE "NEW YORK STANDARDS AND SPECIFICATIONS FOR EROSION AND SEDIMENT CONTROL".
- 2. ANY POTENTIALLY EROSIVE MATERIAL TEMPORARILY STOCKPILED ON THE SITE DURING THE CONSTRUCTION PROCESS SHALL BE LOCATED IN AN AREA AWAY FROM STORM DRAINAGE AND SHALL BE PROPERLY PROTECTED
- 3. DISTURBED AREAS WHERE WORK IS DELAYED OR COMPLETED SHALL BE STABILIZED WITH TEMPORARY OR PERMANENT VEGETATIVE COVER WITHIN 14 DAYS.
- 4. DUST CONTROL SHALL BE ACCOMPLISHED BY STANDARD METHODS OF LIGHTLY WATERING ALL EXPOSED SOIL AND CONSTRUCTION PHASING: RAPIDLY STABILIZING THE REGRADED AREAS WITH TOPSOIL, LOAM AND/OR SEEDING. 5. THE VILLAGE OF MAMARONECK SHALL BE NOTIFIED NOT LESS THAN 48 HOURS PRIOR TO THE START OF ANY SITE
- WORK, AND BY SUCH NOTIFICATION, SHALL BE PROVIDED WITH THE NAME AND TELEPHONE NUMBER OF THE GENERAL CONTRACTOR RESPONSIBLE FOR SUCH WORK
- 6. THE VILLAGE OF MAMARONECK MAY INSPECT EROSION AND SEDIMENT CONTROL PRACTICES TO DETERMINE THEIR EFFECTIVENESS AND MAY REQUIRE ADDITIONAL MEASURES, AS DEEMED NECESSARY.
- 7. ALL EROSION CONTROL MEASURES EMPLOYED DURING THE CONSTRUCTION PROCESS SHALL BE INSPECTED AND MAINTAINED BY THE CONTRACTOR FOR CONFORMANCE WITH NYSDEC STANDARDS. SEDIMENT SHALL BE REMOVED
- 8. DUE TO THE LIMITED DISTURBANCE AREA AND THE FACT THAT THE SITE WILL REMAIN ACTIVE DURING CONSTRUCTION IT IS ASSUMED THAT EXCAVATED SOILS WILL BE IMMEDIATELY LOADED AND REMOVED FROM THE SITE. IT IS ALSO ASSUMED THAT STOCKPILED MATERIALS WILL CONSIST OF CLEAN STONE OR BASE MATERIALS WITH LOW POTENTIAL FOR EROSION. ACCORDINGLY, A CONSTRUCTION ENTRANCE HAS NOT BEEN PROPOSED. IF IT DETERMINED THAT THE THE CONSTRUCTION IS INCONSISTENT WITH THE ABOVE ASSUMPTIONS THEN THE CONTRACTOR SHALL PROVIDE A STABILIZED CONSTRUCTION ENTRANCE, IN ACCORDANCE WITH NYSDEC STANDARDS, AT A LOCATION DETERMINED BY THE PROJECT ENGINEER OR BY VILLAGE OF MAMARONECK
- 9. IF GROUNDWATER IS ENCOUNTERED DURING CONSTRUCTION ACTIVITIES, THE CONTRACTOR SHALL EMPLOY DEWATERING AND SEDIMENT REMOVAL TECHNIQUES IN ACCORDANCE WITH "NEW YORK STANDARDS AND SPECIFICATIONS FOR EROSION AND SEDIMENT CONTROL".
- 10. TEMPORARY EROSION AND SEDIMENT CONTROL MEASURES SHALL BE REMOVED ONCE THE DISTURBED AREAS HAVE BEEN STABILIZED.
- 11. VERIFY ADA PARKING SIGNS AND RELOCATE OR ADD AS REQUIRED.

WHEN THE ACCUMULATION REACHES 50% OF THE EFFECTIVE DEPTH.

ANSI A300 TREE CARE INDUSTRY STANDARDS: ADVANCE PLANNING:

- ROOT PRUNING SHALL TAKE PLACE PRIOR TO ANY OTHER DISTURBANCE ON THE SITE.
- CONTACT AN ISA CERTIFIED ARBORIST AND ARRANGE A SITE VISIT TO DISCUSS LOGISTICS AND TO CONFIRM EXACT
- DECIDE WHERE ROOT PRUNING TRENCH WILL BE LOCATED AND MARK IT ON THE GROUND BETWEEN THE DISTURBANCE AND TREE, TYPICALLY 6" CLOSER TO THE TREE THAN EDGE OF DISTURBANCE.
- DIGGING PROCESS:
- PRUNING TRENCH SHOULD BE CLEARED USING ONLY HAND TOOLS OR AN AIR KNIFE. THIS ACTION WILL EXPOSE THE ROOTS WHILE LEAVING THEM INTACT.
- DO NOT USE AN EXCAVATOR TO CLEAR, SINCE THIS WILL SHRED THE ROOTS AND CAN DAMAGE THE TREE TRUNK. ROOT PRUNING SHOULD BE AS SHALLOW AS POSSIBLE TO ENSURE THAT CUTS ARE MADE ONLY ON ROOTS
- AFFECTED BY THE DISTURBANCE.

4. PRUNING PROCESS:

- THE CERTIFIED ARBORIST MUST PERFORM OR SUPERVISE ALL ROOT CUTS AND REMAIN ON SITE DURING ALL
- ONCE ROOTS ARE EXPOSED, USE A SHARPENED TOOL TO CLEANLY CUT ONLY THE NECESSARY ROOTS. PROPER
- TOOLS INCLUDE A HANDSAW, ROOT PRUNER, OR ANY OTHER SHARP TOOL THAT LEAVES A CLEAN CUT.
- DO NOT USE A CHAINSAW OR EXCAVATOR TO SEVER ROOTS.
- ALL ROOTS SHALL BE LEFT WITH A CLEAN, PERPENDICULAR CUT WITH SMOOTH ENDS AND NO RAGGED EDGES.
- TREE ROOT CUTS MUST BE KEPT MOIST. IF ROOTS ENDS WILL BE LEFT EXPOSED FOR MORE THAN 8 HOURS, COVER
- THE CUT ROOT ENDS AND THE DUG HOLE WITH MOIST BURLAP. • FILL HOLE WITH QUALITY TOP SOIL AND MULCH AREA WITH TRIPLE SHREDDED HARDWOOD TO DEPTH OF 3".


1. INSTALL OF TEMPORARY ESC MEASURES, PERIMETER FENCING.


WATER WELL UNTIL ENTIRE AREA AROUND TREE IS THOROUGHLY SOAKED.

- 2. REMOVE TREES AND STUMPS.
- INSTALL RETAINING WALL.
- 4. REMOVE TOPSOIL AND GRADE PATIO. 5. INSTALL PERMEABLE PAVERS.
- 6. INSTALL LANDSCAPING.

EXISTING CONDITIONS

7. REMOVAL OF TEMPORARY ESC MEASURES.

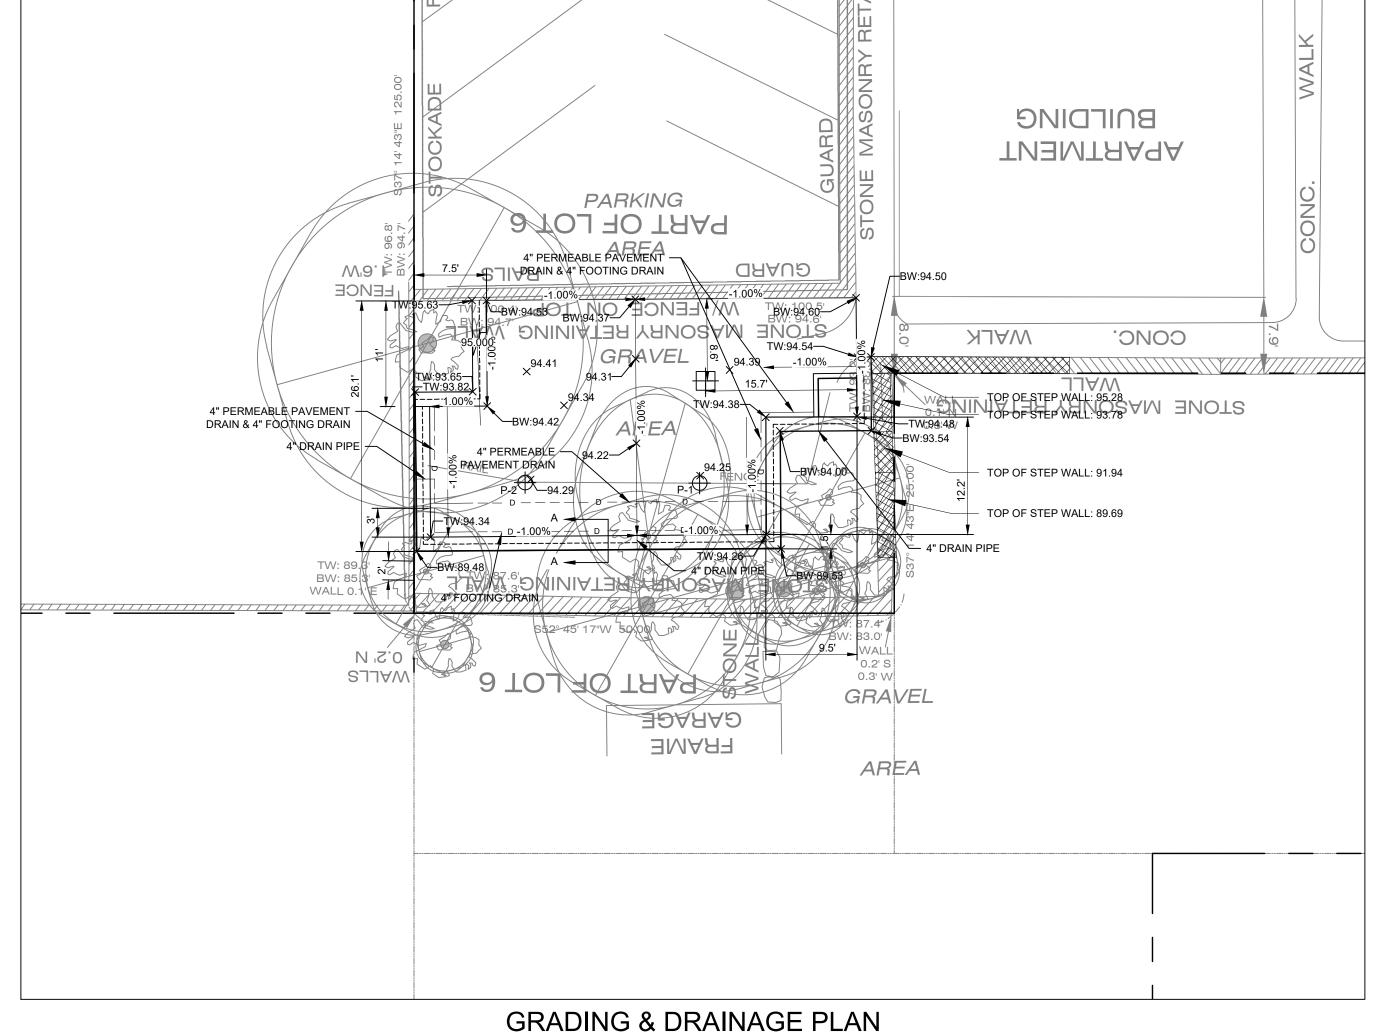

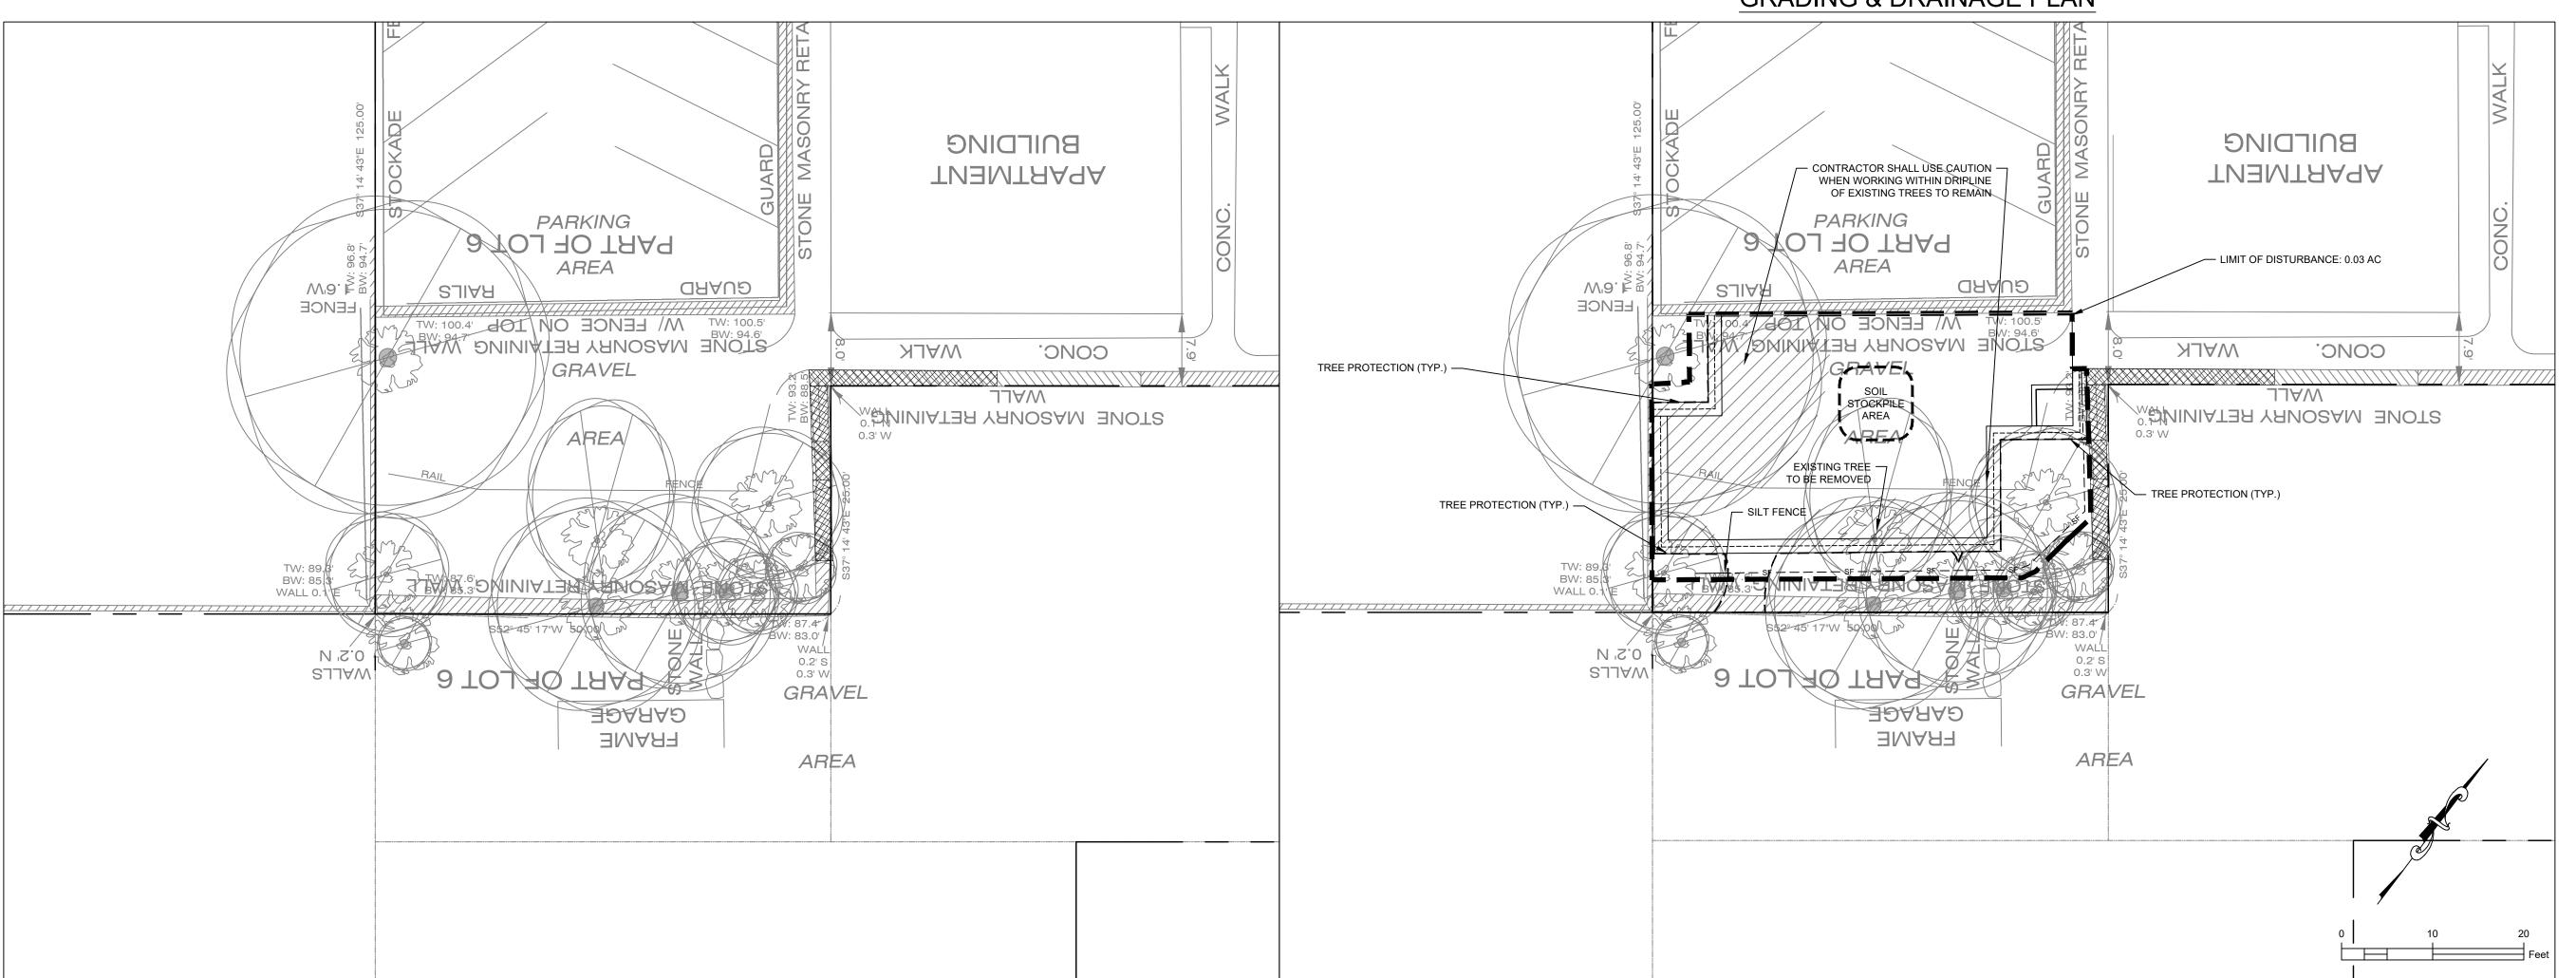

APPLICANT:

ARCHER PROPERTY **MANAGEMENT** 105 CALVERT STREET

HARRISON NY 10528

REVISION

DETAIL REVISION ZONING TABLE REVISED

ZONING TABLE REVISED

ADJOINER MAP INCLUDED

LANDSCAPE REVISION

BUILDING COVERAGE UPDATED

ADDITIONAL DIMENSIONS INCLUDED

PER VILLAGE ENGINEER COMMENTS

PER VILLAGE CONSULTANT COMMENTS

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BBQ/PATIO AREA IMPROVEMENTS **412 MUNRO AVENUE** VILLAGE OF MAMARONECK **COUNTY OF WESTCHESTER** TAX ID: 9-15-282

EXISTING CONDITIONS GRADING & DRAINAGE EROSION & SEDIMENT CONTROL PLAN



DATE: MAY 07, 2021 DRAWN BY: D.M.G. PROJECT NO.: 21001

PROFESSIONAL ENGINEER NYS LICENSE NO. 076790

TREE PROTECTION NOTES:

- 1. CONTRACTOR SHALL USE CAUTION WHEN WORKING WITHIN THE DRIP LINE OF ALL EXISTING TREES TO REMAIN.
- 2. IN THE EVENT THAT THE ROOTS WITHIN THE PROTECTED ROOT ZONE MUST BE PRUNED, ANSI A300 TREE CARE INDUSTRY STANDARDS MUST BE FOLLOWED.

ANSI A300 TREE CARE INDUSTRY STANDARDS:

ADVANCE PLANNING:

- ROOT PRUNING SHALL TAKE PLACE PRIOR TO ANY OTHER DISTURBANCE ON THE SITE
- 2. PREPARATION
- CONTACT AN ISA CERTIFIED ARBORIST AND ARRANGE A SITE VISIT TO DISCUSS LOGISTICS AND TO CONFIRM EXACT LOCATION OF ROOT PRUNING.
- DECIDE WHERE ROOT PRUNING TRENCH WILL BE LOCATED AND MARK IT ON THE GROUND BETWEEN THE
- DISTURBANCE AND TREE, TYPICALLY 6" CLOSER TO THE TREE THAN EDGE OF DISTURBANCE. DIGGING PROCESS:
- PRUNING TRENCH SHOULD BE CLEARED USING ONLY HAND TOOLS OR AN AIR KNIFE. THIS ACTION WILL EXPOSE THE
- ROOTS WHILE LEAVING THEM INTACT. • DO NOT USE AN EXCAVATOR TO CLEAR, SINCE THIS WILL SHRED THE ROOTS AND CAN DAMAGE THE TREE TRUNK.
- ROOT PRUNING SHOULD BE AS SHALLOW AS POSSIBLE TO ENSURE THAT CUTS ARE MADE ONLY ON ROOTS
- AFFECTED BY THE DISTURBANCE.

PRUNING PROCESS:

- THE CERTIFIED ARBORIST MUST PERFORM OR SUPERVISE ALL ROOT CUTS AND REMAIN ON SITE DURING ALL PRUNING.
- ONCE ROOTS ARE EXPOSED, USE A SHARPENED TOOL TO CLEANLY CUT ONLY THE NECESSARY ROOTS. PROPER TOOLS INCLUDE A HANDSAW, ROOT PRUNER, OR ANY OTHER SHARP TOOL THAT LEAVES A CLEAN CUT.
- DO NOT USE A CHAINSAW OR EXCAVATOR TO SEVER ROOTS. ALL ROOTS SHALL BE LEFT WITH A CLEAN, PERPENDICULAR CUT WITH SMOOTH ENDS AND NO RAGGED EDGES.
- POST PRUNING:
- TREE ROOT CUTS MUST BE KEPT MOIST. IF ROOTS ENDS WILL BE LEFT EXPOSED FOR MORE THAN 8 HOURS, COVER THE CUT ROOT ENDS AND THE DUG HOLE WITH MOIST BURLAP.
- FILL HOLE WITH QUALITY TOP SOIL AND MULCH AREA WITH TRIPLE SHREDDED HARDWOOD TO DEPTH OF 3". WATER WELL UNTIL ENTIRE AREA AROUND TREE IS THOROUGHLY SOAKED.

ANSI A300 STANDARDS PRUNING PRACTICES:

TREE INSPECTION

- 1.1. AN ARBORIST OR ARBORIST TRAINEE SHALL VISUALLY INSPECT EACH TREE BEFORE BEGINNING WORK
- 1.2. IF A CONDITION IS OBSERVED REQUIRING ATTENTION BEYOND THE ORIGINAL SCOPE OF THE WORK, THE CONDITION SHOULD BE REPORTED TO AN IMMEDIATE SUPERVISOR, THE OWNER, OR THE PERSON RESPONSIBLE FOR AUTHORIZING THE WORK

2. TOOLS AND EQUIPMENT

- 2.1. EQUIPMENT AND WORK PRACTICES THAT DAMAGE LIVING TISSUE AND BARK BEYOND THE SCOPE OF THE WORK SHOULD BE AVOIDED.
- 2.2. CLIMBING SPURS SHALL NOT BE USED WHEN CLIMBING AND PRUNING TREES. EXCEPTIONS: - WHEN LIMBS ARE MORE THAN THROWLINE DISTANCE APART AND THERE IS NO OTHER MEANS OF CLIMBING THE TREE;
 - WHEN THE BARK IS THICK ENOUGH TO PREVENT DAMAGE TO THE CAMBIUM;

PRUNING CUTS

3.1. PRUNING TOOLS USED IN MAKING PRUNING CUTS SHALL BE SHARP.

-IN REMOTE OR RURAL UTILITY RIGHTS-OF-WAY.

- 3.2. A PRUNING CUT THAT REMOVES A BRANCH AT ITS POINT OF ORIGIN SHALL BE MADE CLOSE TO THE TRUNK OR PARENT LIMB, WITHOUT CUTTING INTO THE BRANCH BARK RIDGE OR COLLAR, OR LEAVING A STUB.
- 3.3. A PRUNING CUT THAT REDUCES THE LENGTH OF A BRANCH OR PARENT STEM SHOULD BISECT THE ANGLE BETWEEN ITS BRANCH BARK RIDGE AND AN IMAGINARY LINE PERPENDICULAR TO THE BRANCH OR STEM.
- 3.4. THE FINAL CUT SHALL RESULT IN A FLAT SURFACE WITH ADJACENT BARK FIRMLY ATTACHED.
- 3.5. WHEN REMOVING A DEAD BRANCH, THE FINAL CUT SHALL BE MADE JUST OUTSIDE THE COLLAR OF LIVING
- 3.6. TREE BRANCHES SHALL BE REMOVED IN SUCH A MANNER SO AS NOT TO CAUSE DAMAGE TO OTHER PARTS OF THE TREE OR TO OTHER PLANTS OR PROPERTY. BRANCHES TOO LARGE TO SUPPORT WITH ONE HAND SHALL BE PRECUT TO AVOID SPLITTING OF THE WOOD OR TEARING OF THE BARK. WHERE NECESSARY, ROPES OR OTHE EQUIPMENT SHALL BE USED TO LOWER LARGE BRANCHES OR PORTIONS OF BRANCHES TO THE GROUND.
- 3.7. A FINAL CUT THAT REMOVED A BRANCH WITH A NARROW ANGLE OF ATTACHMENT SHOULD BE MADE FROM THE OUTSIDE OF THE BRANCH TO PREVENT DAMAGE TO THE PARENT LIMB.
- 3.8. SEVERED LIMBS SHALL BE REMOVED FROM THE CROWN UPON COMPLETION OF THE PRUNING, AT TIMES WHEN THE TREE WOULD BE LEFT UNATTENDED, OR AT THE END OF THE WORKDAY.

4. WOUND TREATMENT

- 4.1. WOULD TREATMENTS SHOULD NOT BE USED TO COVER WOUNDS OR PRUNING CUTS, EXCEPT WHEN RECOMMENDED FOR DISEASE, INSECT, MISTLETOE, OR SPROUT CONTROL, OR FOR COSMETIC REASONS.
- 4.2. WOUND TREATMENTS THAT ARE DAMAGING TO TREE TISSUES SHALL NOT BE USED.
- 4.3. WHEN TRACING WOUNDS, ONLY LOOSE, DAMAGED TISSUE SHOULD BE REMOVED.

PRUNING OBJECTIVES

- 5.1. PRUNING OBJECTIVES SHALL BE ESTABLISHED PRIOR TO BEGINNING ANY PRUNING OPERATION. TO OBTAIN THE DEFINED OBJECTIVE, THE GROWTH CYCLES AND STRUCTURE OF INDIVIDUAL SPECIES AND THE TYPE OF PRUNING TO BE PERFORMED SHOULD BE CONSIDERED.
- 5.2. NOT MORE THAN 25 PERCENT OF THE FOLIAGE SHOULD BE REMOVED WITHIN AN ANNUAL GROWING SEASON. THE PERCENTAGE AND DISTRIBUTION OF FOLIAGE TO BE REMOVED SHALL BE ADJUSTED ACCORDING TO THE PLANT'S SPECIES, AGE, HEALTH, AND SITE.
- 5.3. NOT MORE THAN 25 PERCENT OF THE FOLIAGE OF A BRANCH OR LIMB SHOULD BE REMOVED WHEN IT IS CUT BACK TO A LATERAL. THAT LATERAL SHOULD BE LARGE ENOUGH TO ASSUME APICAL DOMINANCE.
- 5.4. HEADING SHOULD BE CONSIDERED AN ACCEPTABLE PRACTICE FOR SHRUB OR SPECIALTY PRUNING WHEN NEEDED TO REACH A DEFINED OBJECTIVE.

5.5. TOPPING AND LION'S TAILING SHALL BE CONSIDERED UNACCEPTABLE PRUNING PRACTICES FOR TREES.

6. PRUNING TYPES SPECIFICATIONS FOR PRUNING SHALL CONSIST OF, BUT NOT LIMITED TO, ONE OR MORE OF THE FOLLOWING

- 6.1. CLEAN: CLEANING SHALL CONSIST OF SELECTIVE PRUNING TO REMOVE ONE OR MORE OF THE FOLLOWING
- PARTS: DEAD, DISEASED, AND/OR BROKEN BRANCHES.
- 6.1.1. LOCATION OF PARTS TO BE REMOVED SHALL BE SPECIFIED.
- 6.1.2. SIZE RANGE OF PARTS TO BE REMOVED SHALL BE SPECIFIED.
- 6.2. THIN: THINNING SHALL CONSIST OF SELECTIVE PRUNING TO REDUCE THE DENSITY OF LIVE BRANCHES.
- NOT MORE THAN 25 PERCENT OF THE CROWN SHOULD BE REMOVED WITHIN AN ANNUAL GROWING SEASON. LOCATION OF PARTS TO BE REMOVED SHALL BE SPECIFIED.

THINNING SHOULD RESULT IN AN EVEN DISTRIBUTION OF BRANCHES ON INDIVIDUAL LIMBS AND

- 6.2.4. PERCENTAGE OF FOLIAGE AND SIZE RANGE OF PARTS TO BE REMOVED SHALL BE SPECIFIED.
- 6.3. RAISE: RAISING SHALL CONSIST OF SELECTIVE PRUNING TO PROVIDE VERTICAL CLEARANCE. VERTICAL CLEARANCE SHOULD BE SPECIFIED.
- 6.3.2. LOCATION AND SIZE RANGE OF PARTS TO BE REMOVED SHOULD BE SPECIFIED.
- 6.4. REDUCE: REDUCTION SHALL CONSIST OF SELECTIVE PRUNING TO DECREASE HEIGHT AND/OR SPREAD.
- CONSIDERATION SHALL BE GIVEN TO THE ABILITY OF A SPECIES TO TOLERATE THIS TYPE OF PRUNING. 6.4.2. LOCATIONS OF PARTS TO BE REMOVED AND CLEARANCE SHOULD BE SPECIFIED.
- 6.4.3. SIZE RANGE OF PARTS SHOULD BE SPECIFIED.

7. SPECIALTY PRUNING

CONSIDERATION SHALL BE GIVEN TO THE ABILITY OF A SPECIES TO TOLERATE SPECIALTY PRUNING, USING ONE OR MORE PRUNING TYPES.

7.1. YOUNG TREES

7.1.1. THE REASONS FOR YOUNG TREE PRUNING MAY INCLUDE, BUT ARE NOT LIMITED TO, REDUCING RISK, MAINTAINING OR IMPROVING TREE HEALTH AND STRUCTURE, IMPROVING AESTHETICS, OR SATISFYING A SPECIFIC NEED.

- 7.1.2. YOUNG TREES THAT WILL NOT TOLERATE REPETITIVE PRUNING AND HAVE THE POTENTIAL TO OUTGROW THEIR SPACE SHOULD BE CONSIDERED FOR RELOCATION OR REMOVAL.
- 7.1.3. AT PLANTING
- PRUNING SHOULD BE LIMITED TO CLEANING.
- BRANCHES SHOULD BE RETAINED ON THE LOWER TRUNK.
- 7.1.3.2.

7.1.4. ONCE ESTABLISHED

- CLEANING SHOULD BE PERFORMED.
- RUBBING AND POORLY ATTACHED BRANCHES SHOULD BE REMOVED. 7.1.4.2. A CENTRAL LEADER OR LEADER(S) AS APPROPRIATE SHOULD BE DEVELOPED.
- 7.1.4.4. A STRONG, PROPERLY SPACED SCAFFOLD BRANCH STRUCTURE SHOULD BE SELECTED AND
- 7.1.4.5. INTERFERING BRANCHES SHOULD BE REDUCED OR REMOVED.

ANNUALLY DURING THE DORMANT SEASON.


7.2. ESPALIER


- BRANCHES THAT EXTEND OUTSIDE THE DESIRED PLANE OF GROWTH SHALL BE PRUNED OR TIED BACK. 7.2.2. TIES SHOULD BE REPLACED AS NEEDED TO PREVENT GIRDLING THE BRANCHES AT THE ATTACHMENT SITE.
- 7.3. POLLARDING CONSIDERATION SHALL BE GIVEN TO THE ABILITY OF THE INDIVIDUAL TREE TO RESPOND TO POLLARDING.
- MANAGEMENT PLANS SHALL BE MADE PRIOR TO THE START OF THE POLLARDING PROCESS FOR ROUTINE REMOVAL OF WATERSPROUTS.
- 7.3.3. INTERNODAL CUTS SHALL BE MADE AT SPECIFIC LOCATIONS TO START THE POLLARDING PROCESS. AFTER THE INITIAL CUTS ARE MADE, NO ADDITIONAL INTERNODAL CUT SHALL BE MADE.

WATERSPROUTS GROWING FROM THE CUT ENDS OF BRANCHES (KNUCKLES) SHOULD BE REMOVED

7.4. RESTORATION

- LOCATION IN TREE, SIZE RANGE OF PARTS, AND PERCENTAGE OF WATERSPROUTS TO BE REMOVED SHOULD BE SPECIFIED.

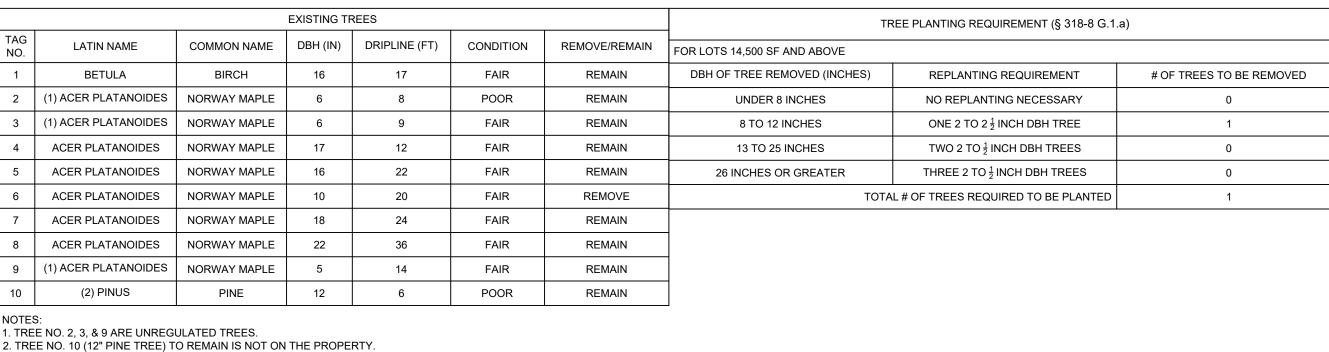

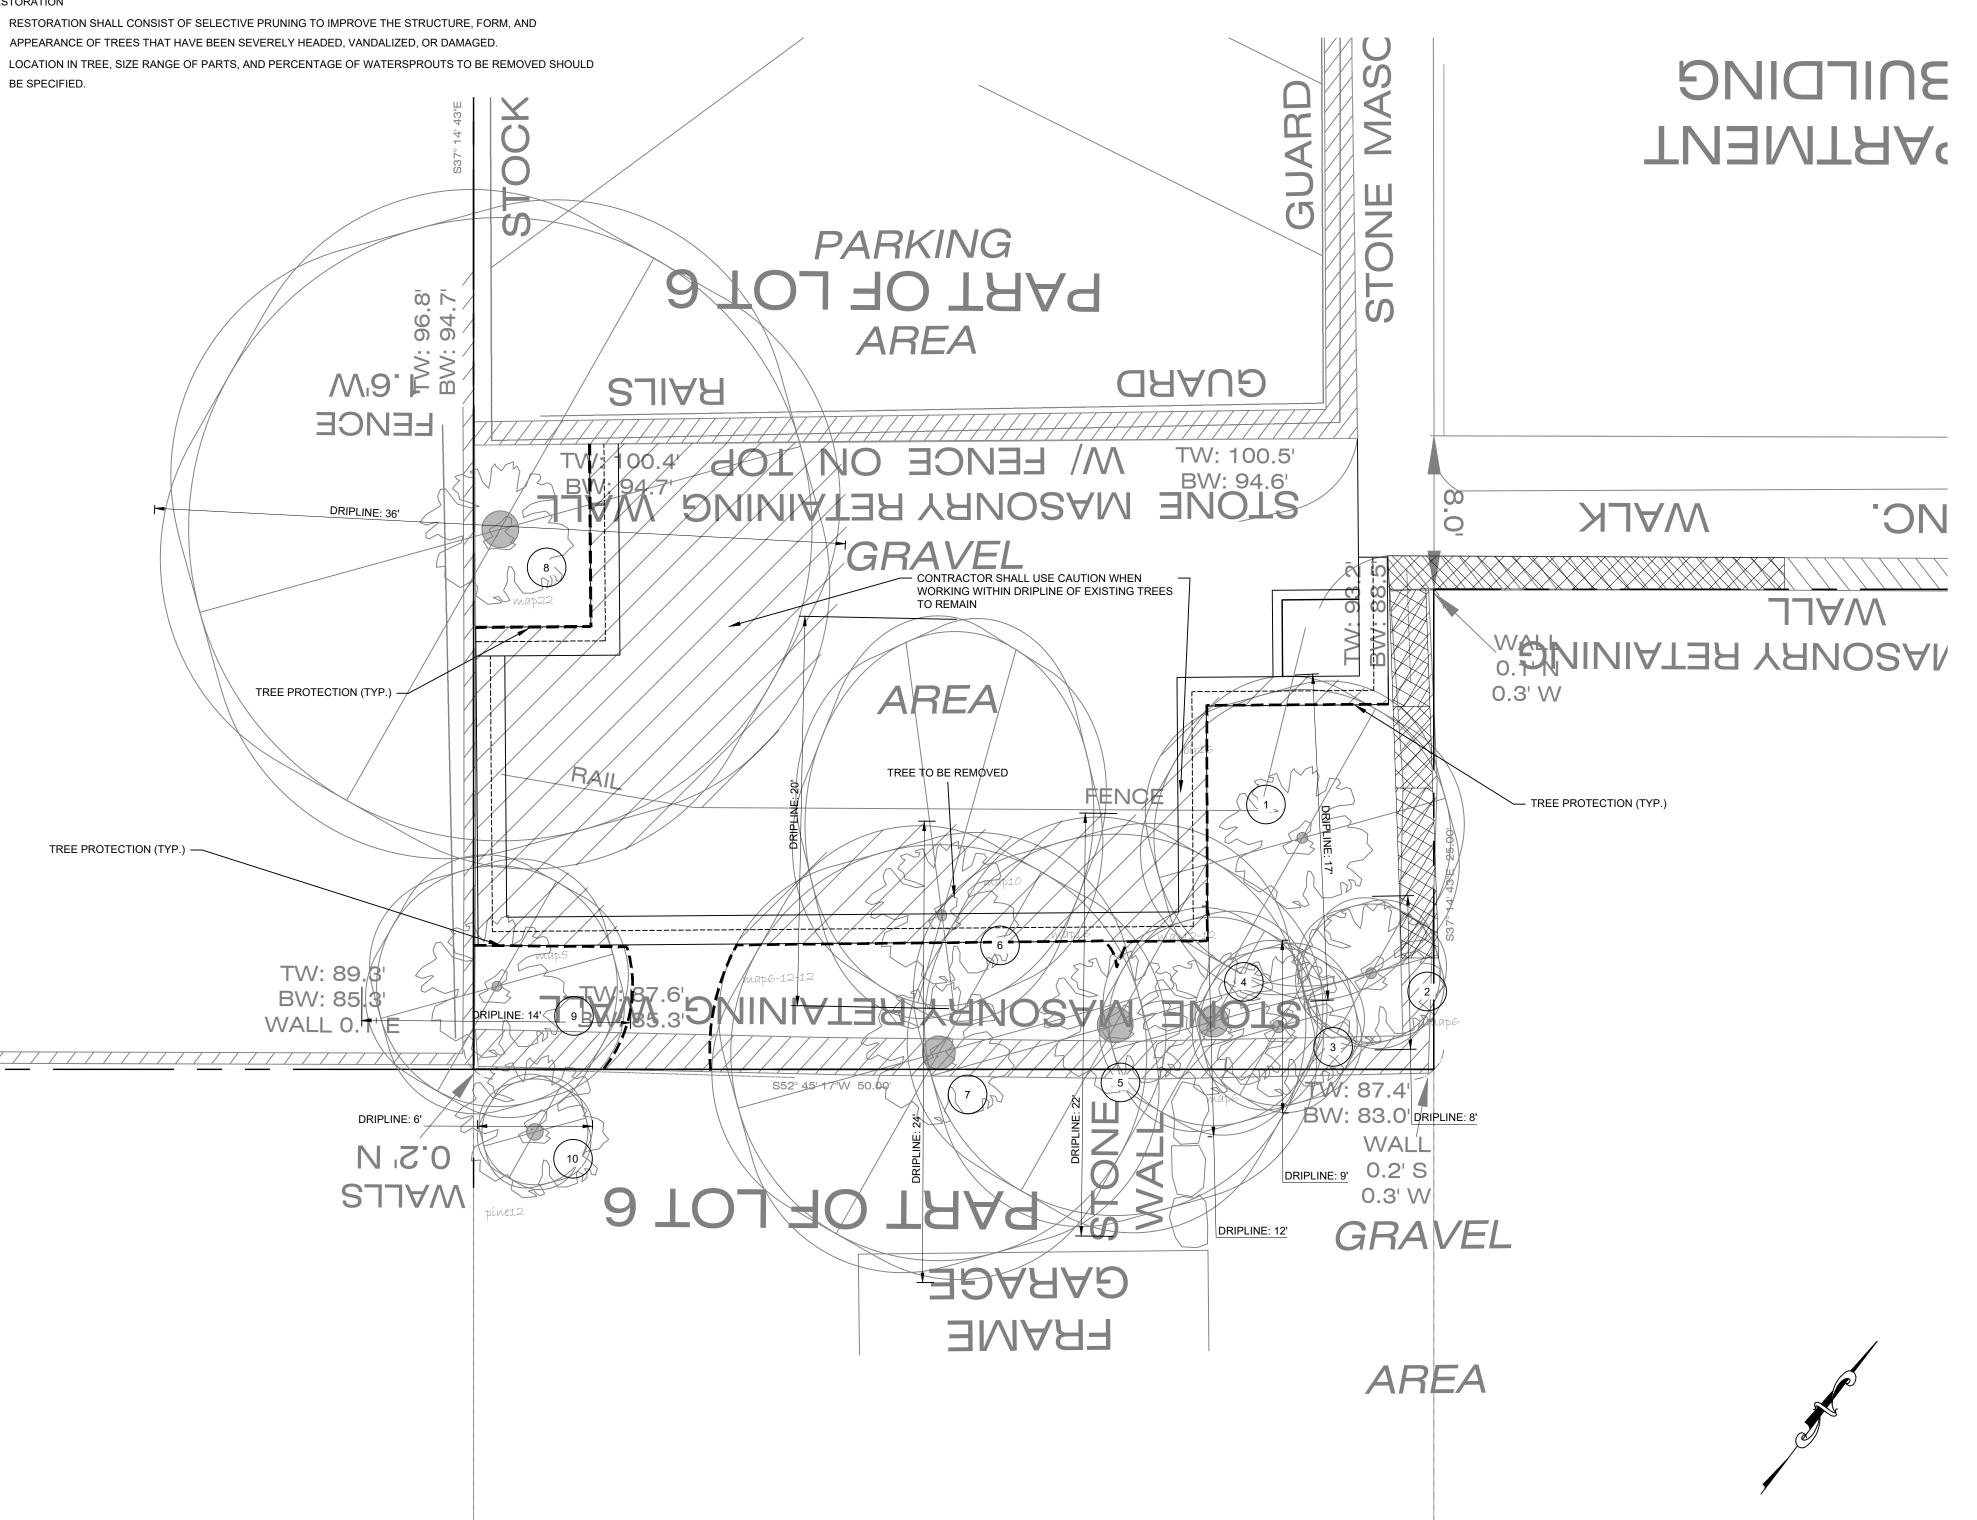

TREE PROTECTION PLAN

NO.

REVISION

DETAIL REVISION ZONING TABLE REVISED

ZONING TABLE REVISED

ADJOINER MAP INCLUDED

I ANDSCAPE REVISION

BUILDING COVERAGE UPDATED

ADDITIONAL DIMENSIONS INCLUDED

PER VILLAGE ENGINEER COMMENTS

PER VILLAGE CONSULTANT COMMENTS

PER VILLAGE CONSULTANT COMMENTS

08.02.2021

05.16.2022

08.16.2022

08 19 2022

10.12.2022

APPLICANT:


ARCHER PROPERTY **MANAGEMENT** 105 CALVERT STREET HARRISON NY 10528

BBQ/PATIO AREA IMPROVEMENTS

One West Avenue, Suite 219, Larchmont, NY 10538 Tel.: (914) 269-8358 · www.catizoneengineering.com


> **412 MUNRO AVENUE** VILLAGE OF MAMARONECK COUNTY OF WESTCHESTER TAX ID: 9-15-282


TREE PROTECTION PLAN

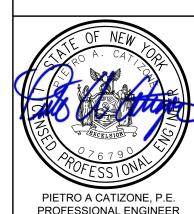

SCALE: 1"=5' DATE: MAY 07, 2021 DRAWN BY: D.M.G CHECKED BY: M.A.D. PROJECT NO.: 21001

NYS LICENSE NO. 076790 UNAUTHORIZED ALTERATIONS OR ADDITIONS TO THIS DRAWING IS A VIOLATION OF SECTION 7209 (2) OF THE NEW YORK STATE EDUCATION LAW

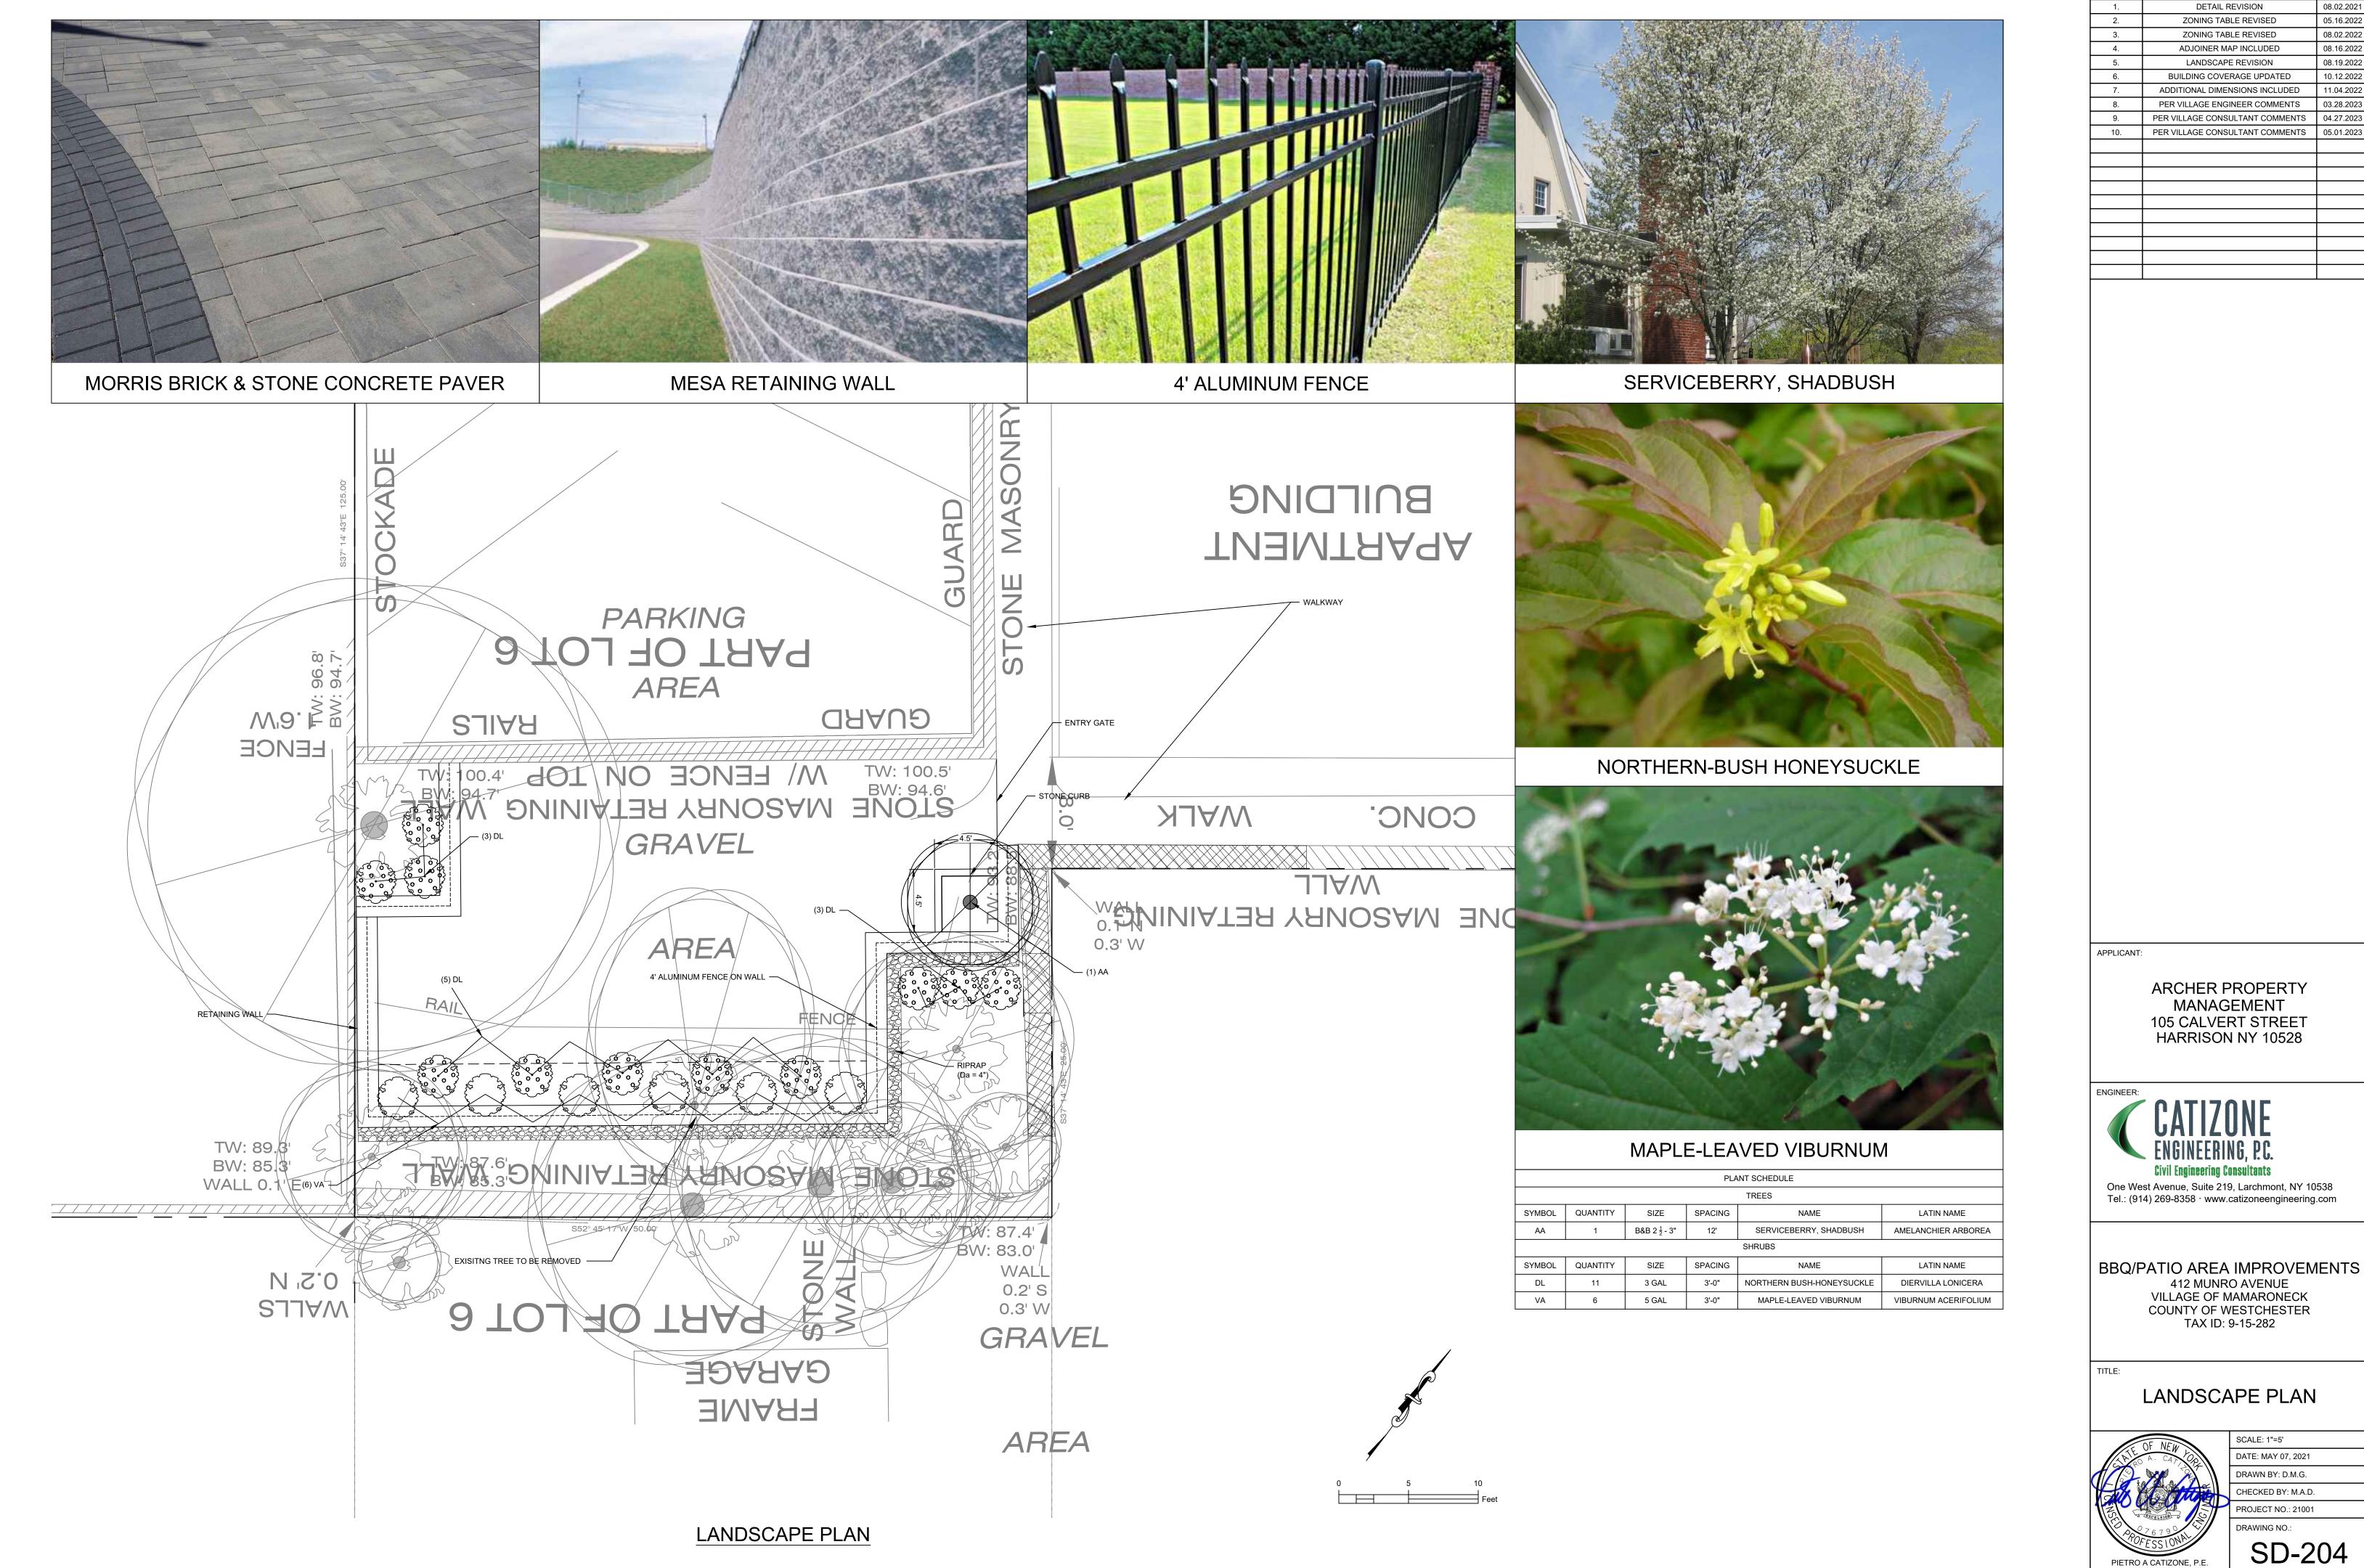

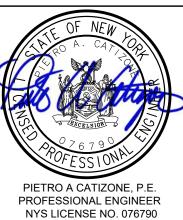

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