#### GLOSSARY

abv. a.d. adj act aff alum	ABOVE AREA DRAIN ADJACENT ACOUSTIC CEILING TILE ABOVE FINISH FLOOR ALUMINUM	MAX. MED MECH MIN. MTL MV	MAXIMUM MEDICINE CABINET MECHANICAL MINIMUM METAL MICROWAVE
BLKG BLDG BD	BLOCKING BUILDING BOARD	(N) N.I.C. NTS	NEW NOT IN CONTRACT NOT TO SCALE
CONC CONC CONT CPT CT	CENTERLINE CLEAR CONCRETE CONTINUOUS CARPET CERAMIC TILE	O.C. O/ OD O.H. PLAM	ON CENTER OVER OVERFLOW DRAIN OPPOSITE HAND PLASTIC LAMINATE
DIA DIM.	DIAMETER DIMENSION	ply. PTD	PLYWOOD PAINTED
DIMS. DN DWG	DIMENSIONS DOWN DRAWING	rad Ref Req. Rb	RADICAL REFRIGERATOR REQUIRED RUBBER BASE
(E), EX. EA. EJ ELEC	EXISTING EACH EXPANSION JOINT ELECTRIC	RM RO RDWD	ROOM ROUGH OPENING REDWOOD
el., elev. Emb. Eq Ext	ELEVATION EMBEDDED EQUAL EXTERIOR	SC SHTG SHT SIM SQ	SOLID CORE SHEETING SHEET SIMILAR SQUARE
Fa FD FF FLR F.O.S. F.O.M.	FIRE ALARM FLOOR DRAIN FINISH FLOOR FLOOR FACE OF STUD FACE OF MASONRY	S.S.D. STL ST.STL STOR STRL STV	SEE STRUCTURAL DWGS STEEL STAINLESS STEEL STORAGE STRUCTURAL SHEET VINYL
GA GALV GL GND GSM GYP: BD. GWB	GAUGE GALVANIZED GLASS GROUND GALVANIZED SHEET METAL GYPSUM BOARD GYPSUM WALLBOARD	T&G T.C. TEL T.O.S. T.O.W. TYP.	TONGUE AND GROOVE TOP OF CURB TELEPHONE TOP OF STEEL TOP OF WALL TYPICAL
HB HC HM H.P.	HOSE BIB HANDICAPPED HOLLOW METAL HOUSE PANEL	U.O.N. VCT VERT. VI.F.	UNLESS OTHERWISE NOTED VINYL COMPOSITION TILE VERTICAL VERIFY IN FIELD
HT INS. INSUL. INT	HEIGHT INSULATION INSULATION INTERIOR	WD W/D W/ WC	WOOD WASHER AND DRYER WITH WATER CLOSET
JAN	JANITOR CLOSET	WH WP	WATER HEATER WATERPROOF
KIT	KITCHEN		

#### WALL TYPES

LAV

	NEW
1 HOUR RATED WALL	
2 HOUR RATED WALL	77777777
3 HOUR RATED WALL	
4 HOUR RATED WALL	

LAVATORY

LIGHT

#### NOTE: REFER TO A-3 FOR WALL AND FLOOR ASSEMBLY DETAILS

XX A3.1.0	
XX A8.1.0	
XX A3.2.0	
XX	
XX XX	
×××	
Lun	ſ


ELEVATION KEY
DETAIL KEY
SECTION KEY
WALL TYPE KEY
DOOR NUMBER KEY

WINDOW TYPE KEY **REVISION CLOUD & KEY** 

#### **GENERAL NOTES**

- THESE GENERAL NOTES ARE TO BE USED IN CONJUNCTION WITH NOTES ON DRAWINGS. ANY, MORE 1.
- ALL WORK SHALL BE IN ACCORDANCE WITH THE NYS 2017 RESIDEN 2020 CODE (2015 ICC AS A 2018) ED
- BY NYS 2017 SUPPLEI 2020 ) AND LOCAL JURISDICTION & FIRE DEPARTMENT REGULATIONS. THE CONTRACTOR AND ALL SUBCONTRACTORS SHALL CARRY PRIOR, DURING AND AFTER
- CONSTRUCTION ALL NECESSARY LICENSES AND INSURANCES PER THE N.Y.S. LOCAL AND ALL GOVERNING REGULATIONS.
- 4 SPECIFICATIONS) PRIOR TO ISSUE TO THE CONTRACTOR. OWNER SHALL CONFIRM THAT ALL INFORMATION IS CORRECT. SHOULD THE OWNER FIND DISCREPANCIES OR INACCURACIES, THESE SHALL BE REPORTED TO THE ARCHITECT.
- THE ARCHITECT IS NOT RESPONSIBLE FOR CONSTRUCTION AND/OR PROJECT SITE. THE PROJECT SITE SHALL BE PROPERLY PROTECTED TO ENSURE PUBLIC SAFETY AND SAFEGUARD THE PUBLIC AT ALL TIMES
- PERMITS SHALL BE POSTED CONSPICUOUSLY FOR THE DURATION OF CONSTRUCTION UNTIL RECEIPT OF CERTIFICATE OF OCCUPANCY.
- DOCUMENTS (PLANS & SPECIFICATIONS) PRIOR TO ANY ERECTION/CONSTRUCTION.
- REPORT ANY DISCREPANCIES, ERRORS OR OMISSIONS TO THE ARCHITECT IMMEDIATELY.
- DIMENSIONS AS PROVIDED ON THE DRAWINGS SHALL BE UTILIZED, U.N.O. THE CONTRACTOR SHALL 10. REPORT ANY DISCREPANCIES IMMEDIATELY TO THE ARCHITECT.
- DRAWINGS ARE NOT TO BE SCALED. 11 12. ALL CHANGES MADE BY THE CONTRACTOR SHALL FIRST BE APPROVED BY THE ARCHITECT AND OWNER PRIOR OF STARTING WITH THE WORK INVOLVED. ANY UNAUTHORIZED CHANGES MADE BY THE CONTRACTOR AND ULTIMATELY NOT BEING APPROVED BY THE OWNER AND ARCHITECT SHALL
- BE THE RESPONSIBILITY OF THE CONTRACTOR AND TO BE CORRECTED AT HIS OWN EXPENSE. 13. THE ARCHITECT HAS NOT BEEN RETAINED FOR ANY MECHANICAL DESIGN SYSTEMS, DUCTS, CHASE OPENINGS, SIZE OF FURNACE AND FRESH AIR REQUIREMENTS ETC. THESE ARE NOT SHOWN AND
- SHALL BE DETERMINED BY A MECHANICAL ENGINEER PRIOR OF COMMENCING THE WORK. 14. THE ARCHITECT HAS NOT BEEN RETAINED FOR SUPERVISION, AND CONSTRUCTION INSPECTIONS AND/OR THE REVIEW OF SHOP DRAWINGS. THE ARCHITECT HAS ONLY BEEN RETAINED FOR DESIGN PURPOSES. THEREFORE, THE ARCHITECT ASSUMES NO LIABILITY FOR WORKMANSHIP, CODE AND/OR
- PLAN COMPLIANCE. 15. THE ARCHITECTS RESPONSIBILITY IS STRICTLY LIMITED TO THESE PLANS AND RELATED SPECIFICATIONS ONLY.
- THE ARCHITECT SHALL NOT BE RESPONSIBLE FOR ANY CONSTRUCTION MEANS, METHODS, 16 DEVIATIONS, TECHNIQUES, SEQUENCES, OR PROCEDURES, OR FOR ANY SAFETY PRECAUTIONS AND PROGRAMS IN CONNECTION WITH THE WORK. FOR THE OMISSIONS OF THE CONTRACTOR. SUBCONTRACTORS OR ANY OTHER PERSONS PERFORMING ANY OF THE WORK, OR FOR THE FAILURE OF ANY OF THEM TO CARRY OUT THE WORK IN ACCORDANCE WITH THESE DOCUMENTS. 17. THE USE OF THE WORDS "PROVIDE" OR "PROVIDED" IN CONNECTION WITH ANY ITEM SPECIFIED IS
- INTENDED TO MEAN THAT SUCH ITEM BE FURNISHED AND INSTALLED AND CONNECTED WHERE REQUIRED. 18. MATERIALS & PRODUCTS INDICATED ON DRAWINGS SHALL BE INSTALLED PER MANUFACTURER'S
- REQUIREMENTS. 19. MINOR DETAILS NOT USUALLY SHOWN OR SPECIFIED, BUT NECESSARY FOR PROPER AND
- ACCEPTABLE CONSTRUCTION INSTALLATION OR OPERATION OF ANY PART OF THE WORK SHALL BE INCLUDED IN THE WORK THE SAME AS IF SPECIFIED OR INDICATED.
- 20. THE ARCHITECT ASSUMES NO RESPONSIBILITY FOR ANY EXISTING STRUCTURES AND/OR ANY UNFORESEEN PROBLEMS PRIOR TO NEW CONSTRUCTION. 21. THE ARCHITECT ASSUMES NO RESPONSIBILITY FOR ANY DEMOLITION, SITE WORK, NEW
- CONSTRUCTION, OPERATION AND METHODS.
- 22. THE CONTRACTOR SHALL BE RESPONSIBLE FOR PROTECTION OF ALL EXISTING AND NEW CONDITIONS AND MATERIALS WITHIN AND ADJACENT TO THE CONSTRUCTION AREA. ANY DAMAGE CAUSED BY THE EXECUTION OF THE WORK INDICATED SHALL BE REPAIRED OR REPLACED BY THE CONSTRUCTION ENTITY PERFORMING SUCH PORTION OF WORK. ALL AREAS THAT ARE AFFECTED BY ALL ADDITIONS SHALL BE REPAIRED AND/OR PATCHED TO A LIKE NEW CONDITION, UNLESS NOTED OTHERWISE.
- 23. THE CONTRACTOR SHALL OBTAIN ALL NECESSARY PERMITS AND APPROVALS BY THE LOCAL AND STATE AS REQUIRED AND TO DELIVER TO THE OWNER A C.O. UPON COMPLETION OF THE PROJECT.
- 24. CONTRACTOR SHALL BE RESPONSIBLE FOR FILING SEPARATE APPLICATIONS FOR HVAC, ELECTRICAL & PLUMBING PERMITS, AS MUNICIPALITY REQUIRES.
- 25. CONTRACTOR SHALL BE RESPONSIBLE FOR FILING SEPARATE APPLICATIONS FOR HVAC, ELECTRICAL & PLUMBING PERMITS, AS MUNICIPALITY REQUIRES.
- THE CONTRACTOR SHALL PROVIDE A CONTAINER FOR THE REMOVAL OF DEBRIS DURING 26. CONSTRUCTION.
- CLEAN AND HAZARD FREE AT ALL TIMES AND TO ABIDE ALL OSHA AND ALL OTHER SAFETY REGULATIONS.
- 28. CONTRACTOR SHALL MAINTAIN A SEALED ENCLOSURE BETWEEN WORK AREA AND OTHERS AREAS OF THE RESIDENCE. IN ADDITION, THE CONTRACTOR SHALL BE RESPONSIBLE TO: PROTECT ALL INTERIOR SPACES FROM THE AREA OF RENOVATION BROOM-SWEEP ALL AREAS AT END OF EACH WORK DAY
- 29. THE CONTRACTOR SHALL LEAVE PREMISES BROOM CLEAN DAILY. 30. THE CONTRACTOR SHALL GUARANTEE ALL WORK SPECIFIED AND/OR DESCRIBED BY THESE DRAWINGS AND IS TO FOLLOW ALL NATIONAL ACCEPTED TRADE PRACTICES.
- 31. FINISH MATERIALS & PAINT COLOR SELECTIONS SHALL BE BY HOMEOWNER, U.N.O. HEREIN. 32. THE ARCHITECT ASSUMES NO RESPONSIBILITY FOR THE ACCURACY OR CORRECTNESS OF ANY

#### <u>AREA MAP</u>

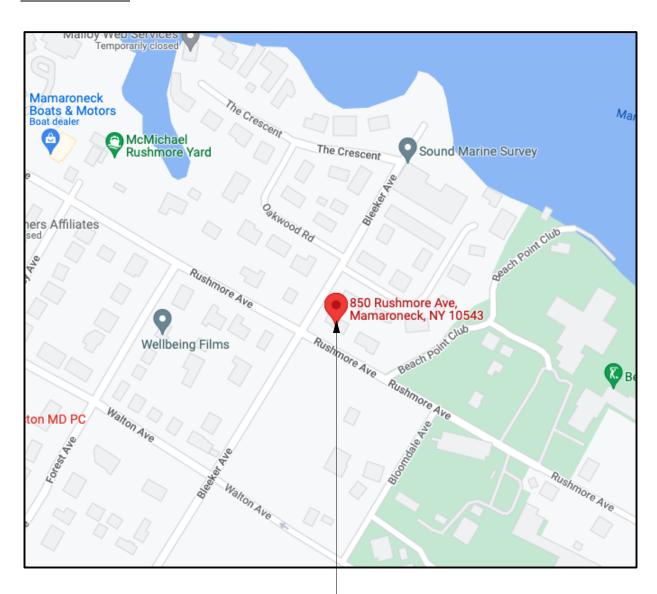

SUBJECT PROPERTY-

RESTRICTIVE NOTES MENTIONED ELSEWHERE ARE TO TAKE PRECEDENCE OVER THESE NOTES.

THE OWNER SHOULD READ AND REVIEW HIS/HER ENTIRE SET OF CONTRACT DOCUMENTS (PLANS &

THE CONTRACTOR SHALL VERIFY ALL DIMENSIONS AND FAMILIARIZE HIMSELF WITH THE CONTRACT ALL DIMENSIONS SHALL BE FIELD VERIFIED BY THE CONTRACTOR AND THE CONTRACTOR SHALL

27. THE CONTRACTOR AND ALL SUBCONTRACTORS WORKING WITH THIS PROJECT SHALL KEEP THE SITE

MATERIAL OR DRAWINGS PREPARED BY OTHERS AND PROVIDED TO THE ARCHITECT.

# HASSLER RESIDENCE

## **RENOVATION & ADDITION**

850 RUSHMORE AVENUE, MAMARONECK, NY 10543


ZONING SCHEDULE						
ZONING INFORMATION: 8	50 RUSHMORE AVENUE, MAM,	ARONECK, NY 10543			4-0.I	COVER SHEET
DISTRICT: R-15					۹-1.0	SURVEY / EXISTING SITE PLAN
CONSTRUCTION TYPE:VB						
USE: SINGLE FAMILY RESIDENC	CE SECTION: 9 BLOCK: 97	7A LOT:9			SD-202	GRADING & UTILITY PLAN
OWNER: ROBERT & JANE HAS	SLER				SD-203 SD-204	EROSION & SEDIMENT CONTROL PLAN LANDSCAPE PLAN
SURVEYED BY:	SURVE	EY DATE: M	IUNICIPALITY:		SD-207	TREE PROTECTION PLAN
SAL SPINELLI, PE	JULY 5	, 1975 V	ILLAGE OF MAMARONECK		5D-401	DETAILS
BLULK STANDARDS	REQUIRED	EXISTING	PROPOSED		SD-402	DETAILS
BULK STANDARDS	ONE-FAMILY RES.	ONE-FAMILY RES.	ONE-FAMILY RES.		4-2.0	EXISTING FLOOR PLANS
MIN. LOT AREA	15,000 SF	I I,520 SF	NO CHANGE		4-2.1 4-2.2	PROPOSED FIRST FLOOR PLAN PROPOSED SECOND FLOOR PLAN
MIN. LOT WIDTH	100 FT	120 FT	NO CHANGE	A	4-2.3	PROPOSED ROOF PLAN
MIN. LOT DEPTH	100 FT	94'-6"	NO CHANGE		4-3.I 4-3.2	EXISTING ELEVATIONS PROPOSED ELEVATIONS
		74-0	INO CHANGE		A-3.3	PROPOSED ELEVATION
FRONTYARD (RUSHMORE)	25 FT	30 FT	NO CHANGE	, A A A A A A A A A A A A A A A A A A A	4-3.4	PROPOSED SECTION
FRONTYARD (BLEEKER)	25 FT	30 FT	NO CHANGE		5-1	FLOUNDATION PLAN
MIN. SIDEYARD (LESSER)	I5 FT	4'-8"	NO CHANGE		5-2 5-3	FIRST FLOOR FRAMING PLAN SECOND FLOOR FRAMING PLAN
MIN. SIDEYARD (COMBINED)	35 FT	46'-2"	35'-0"		5-4 5-5	ATTIC FRAMING PLAN ROOF FRAMING PLAN
MAX. BUILDING HEIGHT	35 FT / 2 1/2 STORIES	20'-8" FT / 1.5 STORIES	27'-10" FT / 2 STORIES		J-J	
MAX. BUILDING COVERAGE	35% (4,032 SF)	2,170 SF (18.8%)	2,411 SF (20.9%)			
FLOOR AREA RATIO (FAR)	.360 (3,960 SF)	2,515 SF (.223)	3,489 SF (.303)			

CLIMATIC & GEOGRAPHIC DESIGN CRITERIA PER TABLE R-301.2(1) OF THE 2018 INTERNATIONAL RESIDENTIAL CODE														
GROUND		WIND     SEISMIC     SUBJECT TO DAMAGE FROM     WINTER     ICE SHIELDS     FLOOD												
SNOW	SPEED	DESIGN	WEATHERING		FROST LINE DEPTH		DE			SIGN	UNDER- LAYMENT REQUIRED		HAZARDS	
45	115	С	SEVERE	42"	42" MODERATE SLIGHT TO TO HEAVY MODERAT				7 Y		30		F.I.R.M. 360922 09/27/2007	
			HE <b>2018</b> INTEF											
CLIMATE ZONE	RATION		GHT FENEST- R-VALUE FRAMED WALL R-VALUE (c) WALL		SLAB (c R-VALU & DEPT	É	CRAWL SPACE (c) WALL R-VALUE							
4A	0.32	0.55	0.40	49	20 or 13+5 (h)	8/*	13	19		1	0/13	10, 2 ft		10/13
AT THE THE INS d. R-5 DEF e. THE h. THE i. THE j. R40 SHA	<ul> <li>AT THE INTERIOR OF THE BASEMENT WALL. "15/19" SHALL BE PERMITTED TO BE MET WITH R-13 CAVITY INSULATION ON THE INTERIOR OF THE BASEMENT WALL PLUS R-5 CONTINUOUS INSULATION ON THE INTERIOR OR EXTERIOR OF THE OF THE HOME. "10/13" MEANS R-10 CONTINUOUS INSULATION ON THE INTERIOR OR EXTERIOR OF THE HOME OR R-13 CAVITY INSULATION AT THE INTERIOR OF THE BASEMENT WALL.</li> <li>d. R-5 SHALL BE ADDED TO THE REQUIRED SLAB EDGE R-VALUES FOR HEATED SLABS. INSULATION DEPTH SHALL BE THE DEPTH OF THE FOOTING OR 2 FEET, WHICHEVER IS LESS IN ZONE THROUGH 3 FOR HEATED SLABS</li> <li>e. THERE ARE NO SHGC REQUIREMENTS IN THE MARINE ZONE.</li> <li>h. THE FIRST VALUE IS CAVITY INSULATION, THE SECOND VALUE IS CONTINUOUS INSULATION, SO "13+5" MEANS R-13 CAVITY INSULATION PLUS R-5 CONTINUOUS INSULATION.</li> </ul>													
EXTERIOR DESIGN CONDITIONS - NEW YORK STATE														
COUN	ITY	WINTER DESIGN DRY-BUL TEMP.	DESIG	N DE LB WET	CIDENT SIGN F-BULB EMP.	DEG	ATING GREE AYS	ZON	E					
WESTCH	ESTER	7	84	7	73	57	750	4						

BC	
Brian Crowley Archite	ecture

65 Birch Road Briarcliff Manor, NY 10510

P. 917.301.3616 www.bc-architecture.com

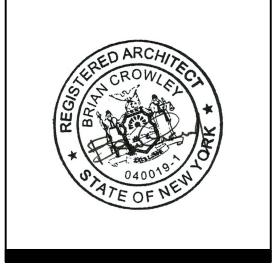

HASSLER RE 850 Rushmore Ave.
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#	date	issue
	09.30.22	ARB
	04.05.23	SITE PLAN APP

#### Cover Sheet


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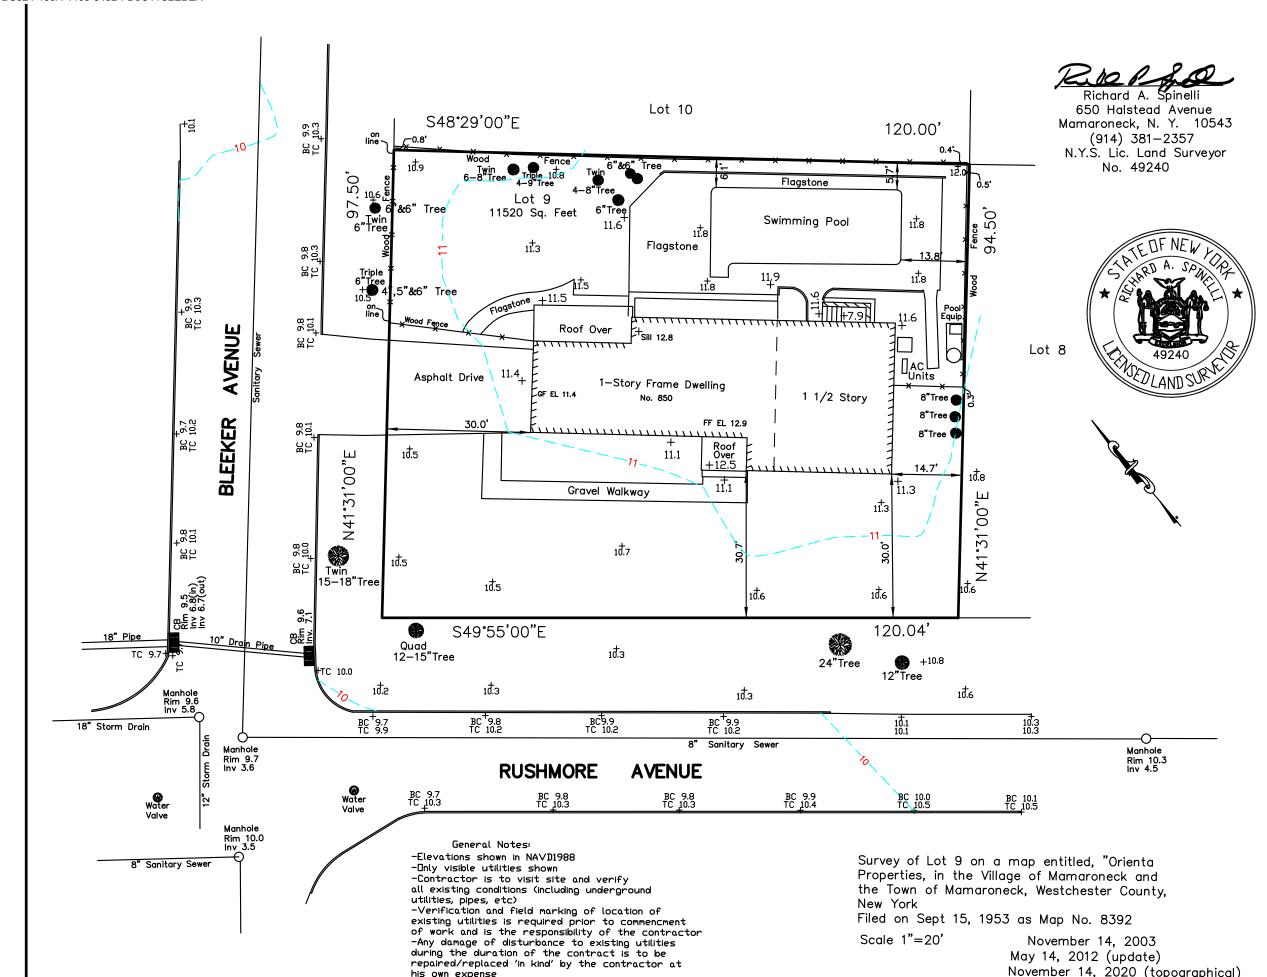
project:	22.08
drawn by:	KJC
checked by:	
date:	06.30.22
scale:	AS NOTED


SURVEY Scale: I" = 20'-0"


EXISTING SITE PLAN Scale: 1/16" = 1'-0"


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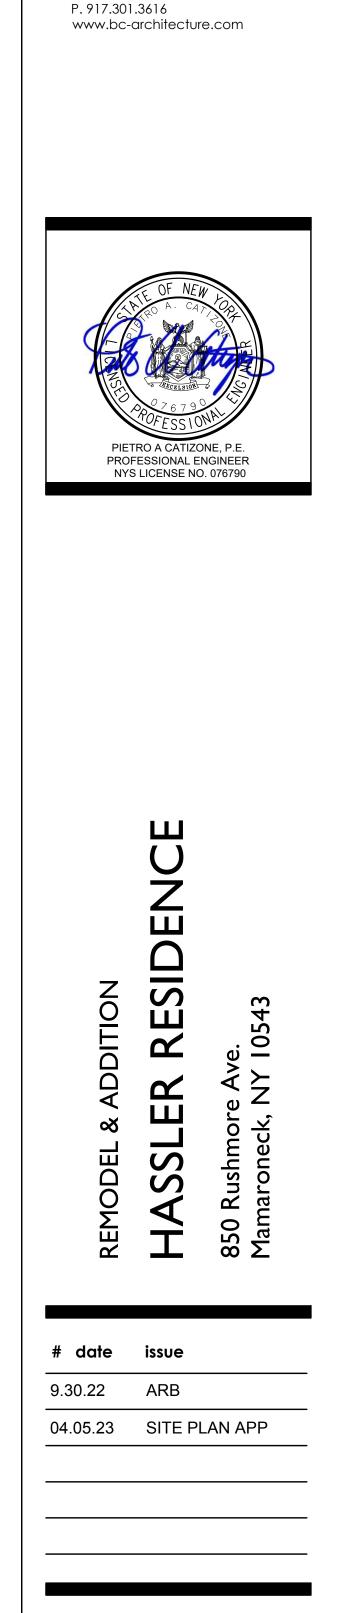




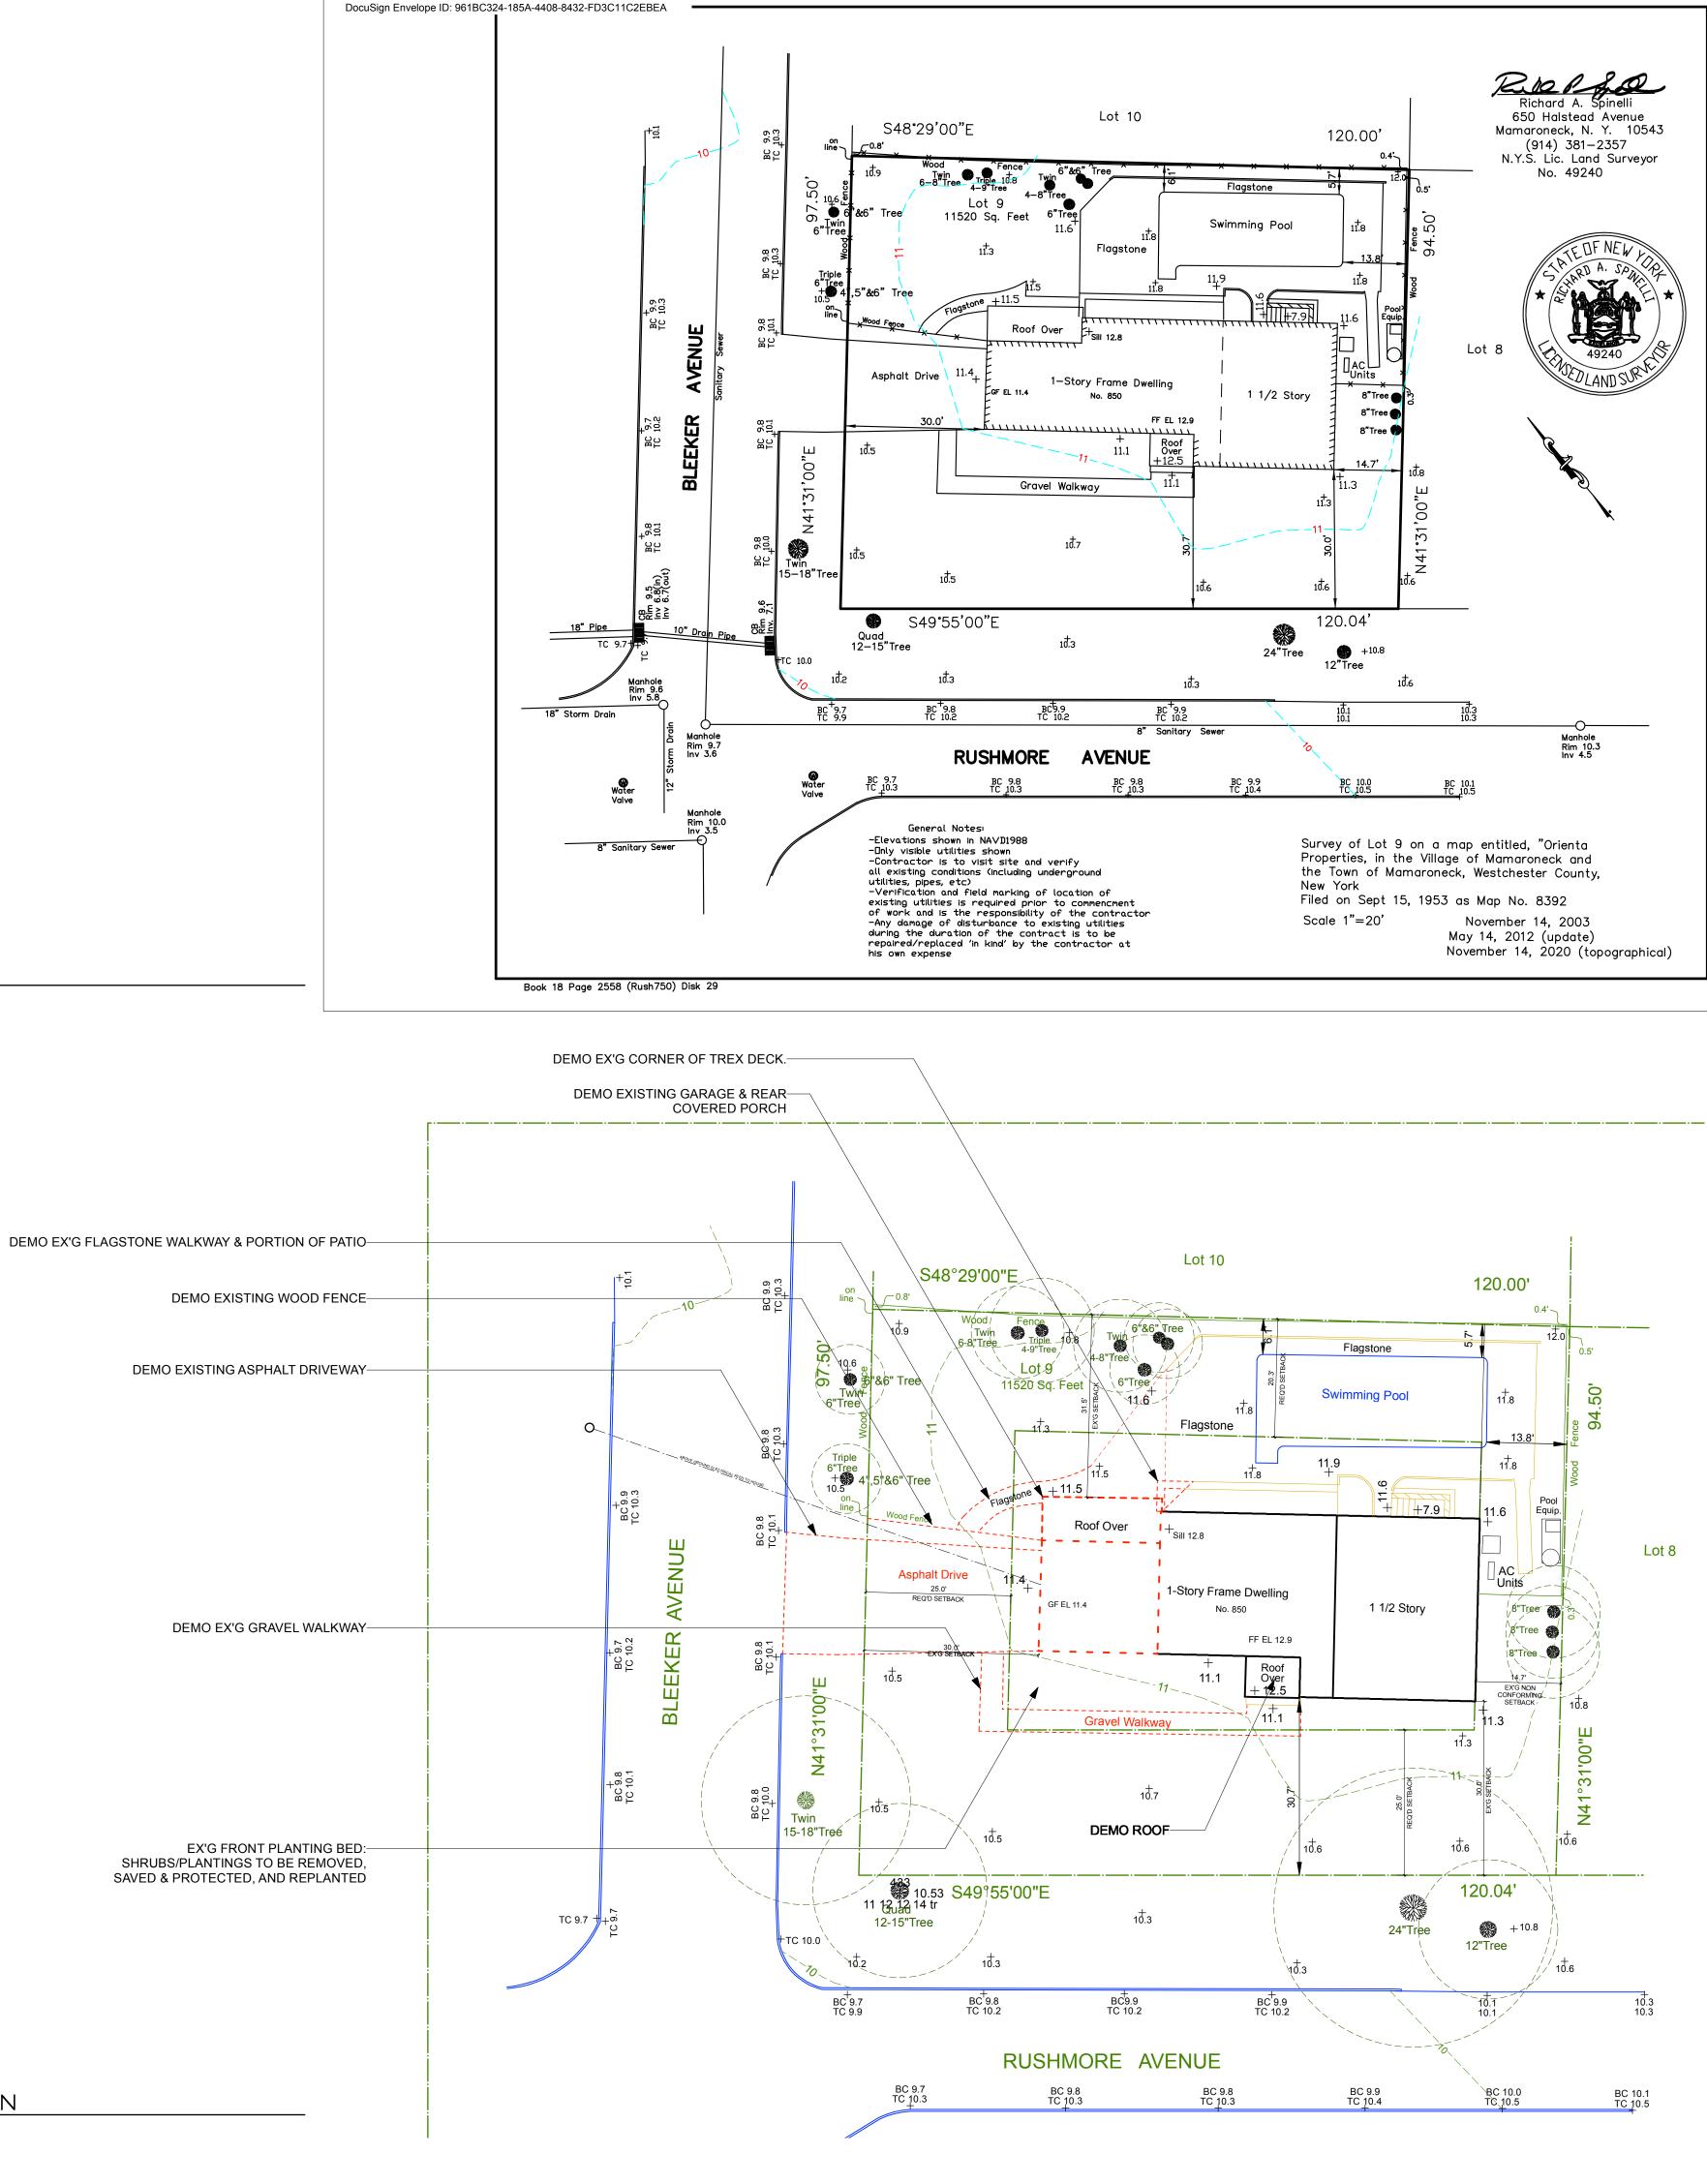

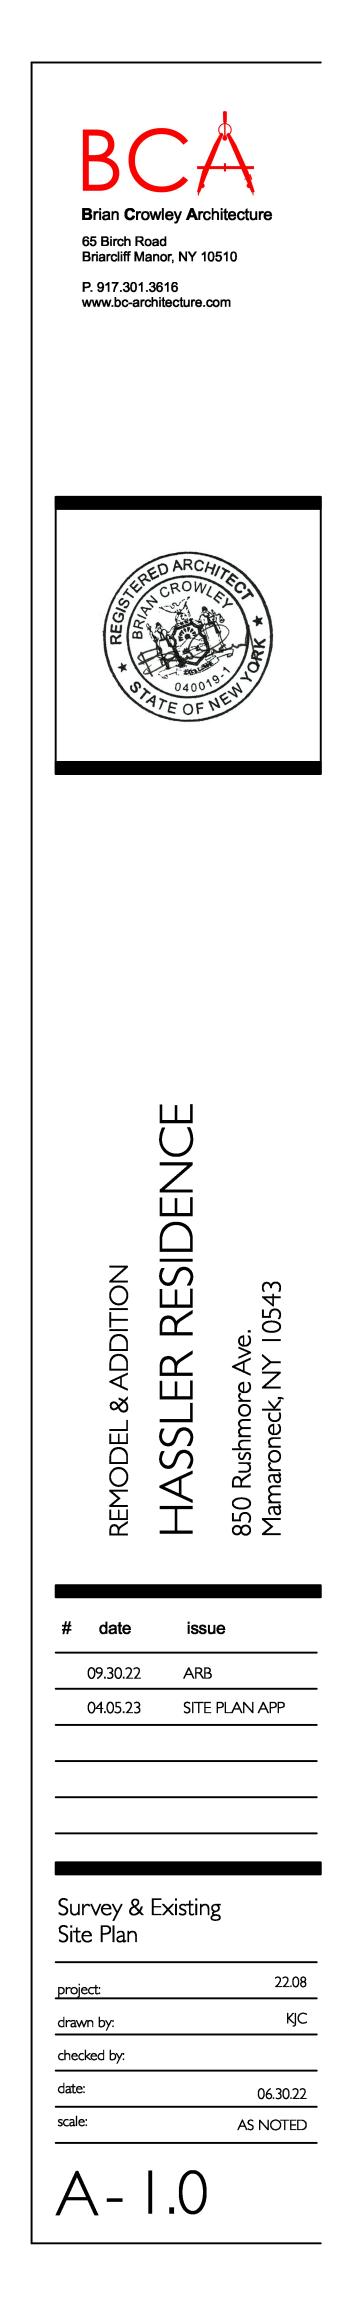

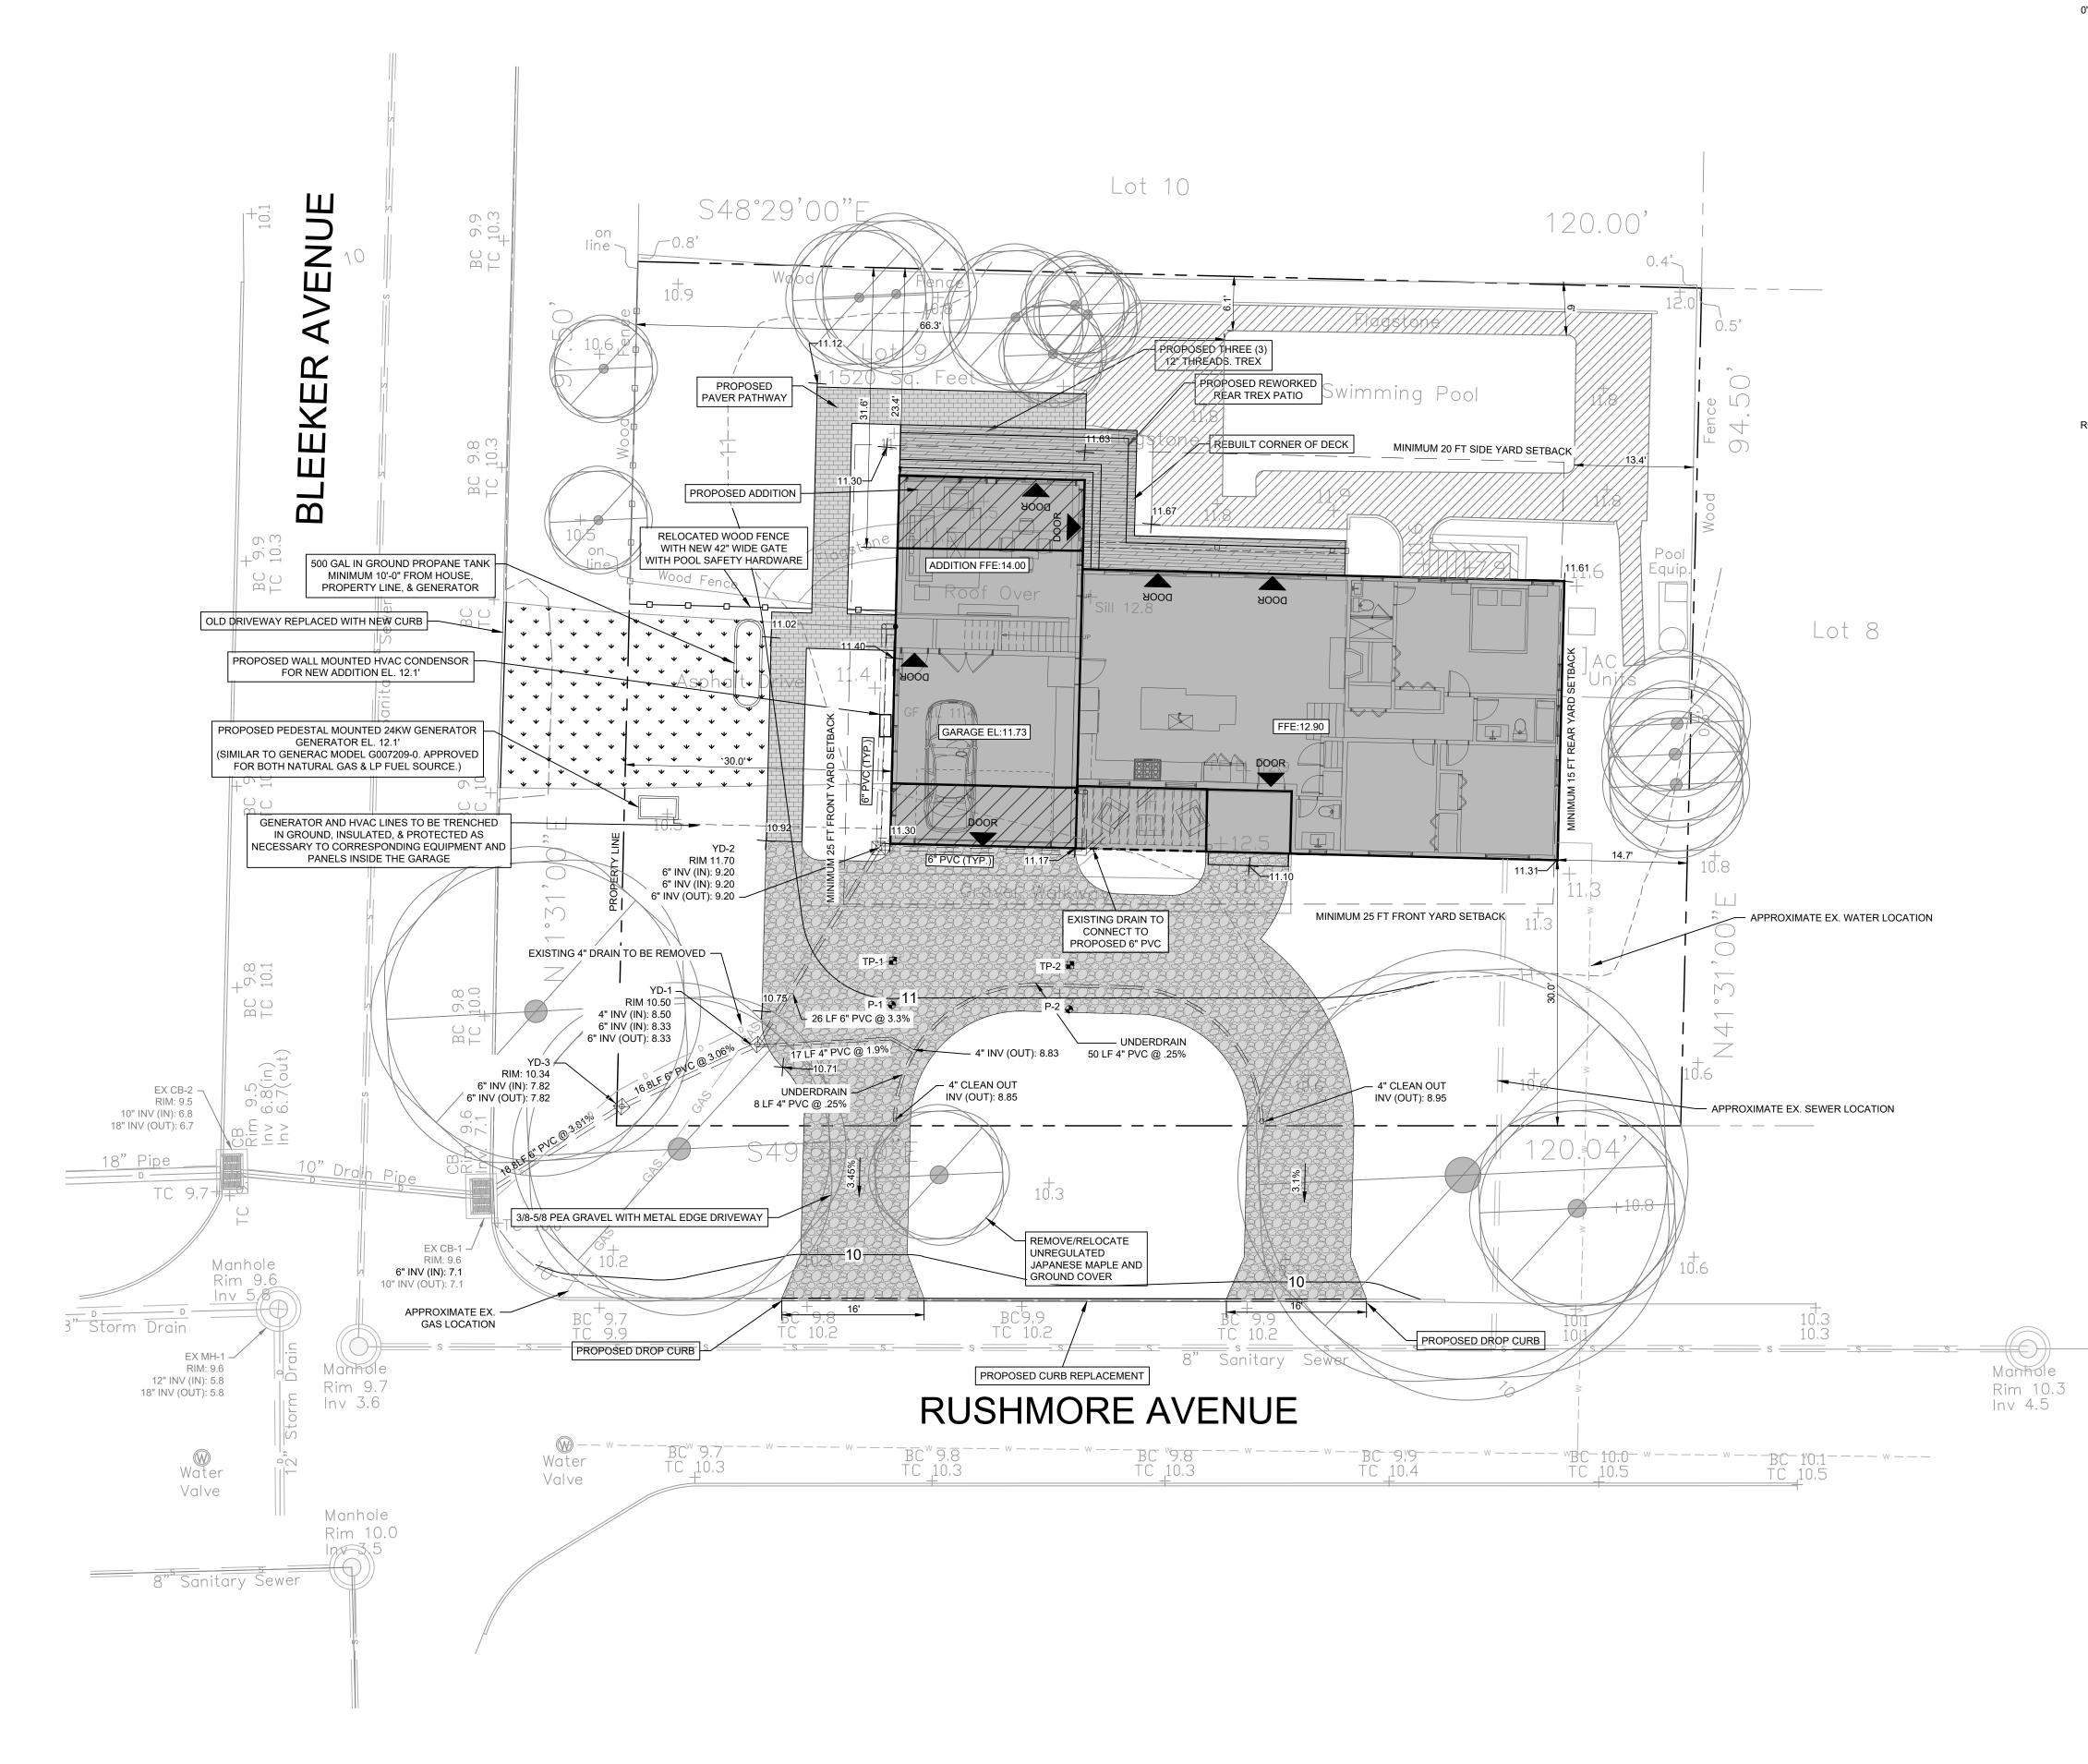

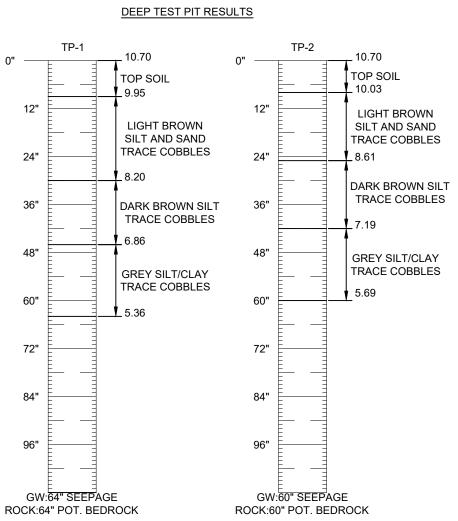

Brian Crowley Architecture


65 Birch Road


Briarcliff Manor, NY 10510

### Grading & Utility Plan

project:	20023
drawn by:	MAD
checked by:	PAC
date:	02.14.23
scale:	I" = I0'



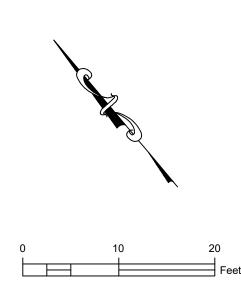

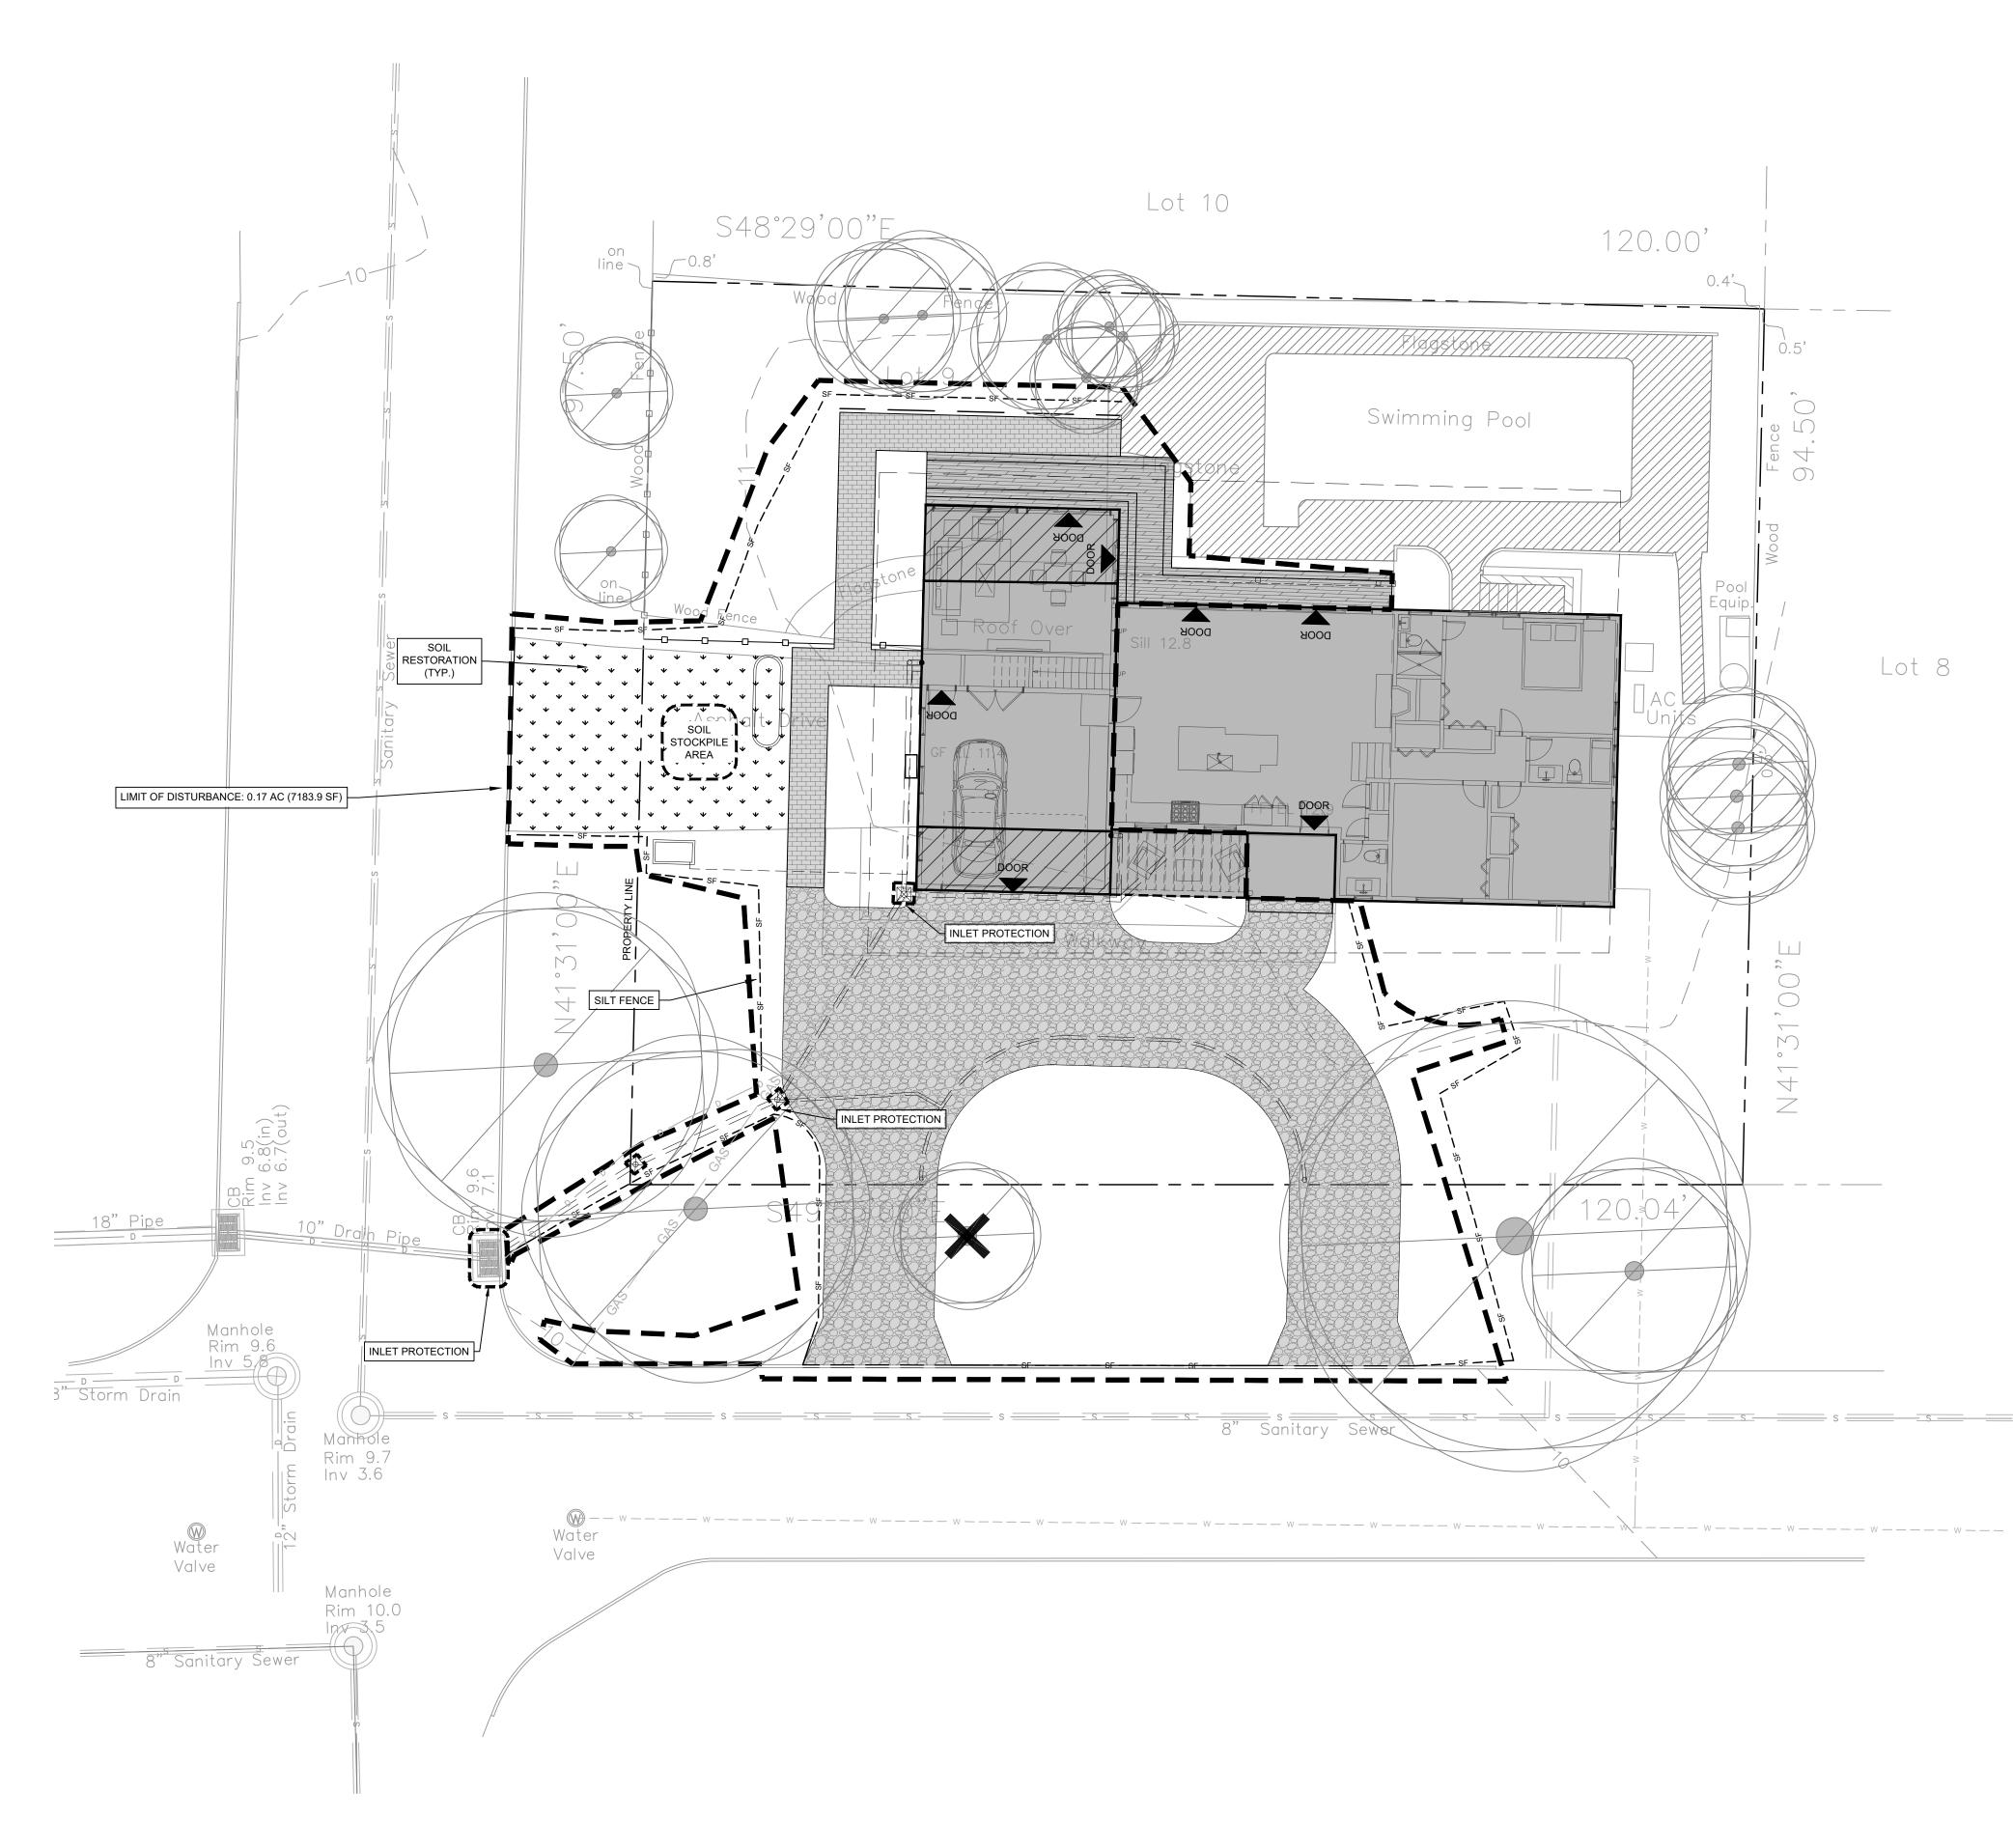

#### BASE NOTES:

- PREPARED BY RICHARD A. SPINELLI.
- 1.1. SURVEYED: NOVEMBER 14, 2003
- 1.2. SURVEY UPDATED: MAY 14, 2012

#### 1.3. TOPOGRAPHICAL ADDED: NOVEMBER 14, 2020 EROSION AND SEDIMENT CONTROL NOTES:

- PROPERTIES.

- HAVE BEEN STABILIZED. CONSTRUCTION SEQUENCING SCHEDULE:
- 3. PROCEED WITH DEMOLITION OF EXISTING GARAGE & CLEARING AND GRUBBING.
- 5. BACKFILL FOUNDATION
- 6. INSTALL STORM SYSTEM
- 8. INSTALL DRIVEWAY BASE AT APRON.
- 9. INSTALL TOPSOIL AND PERMANENT STABILIZATION.
- 10. PLACE STONE DRIVEWAY TREATMENT.
- STABILIZED.
- COLLECTED AND CONVEYED AS DESIGNED.

Manhole

Rim 10.3 lnv 4.5

1. BASE INFORMATION WAS TAKEN FROM A SURVEY TITLED "SURVEY OF LOT 9 ON A MAP ENTITLED, "ORIENTA PROPERTIES, IN THE VILLAGE OF MAMARONECK & THE TOWN OF MAMARONECK, WESTCHESTER COUNTY, NEW YORK. FILED ON SEPTEMBER 15, 1953 AS MAP NO. 8392" FOR PROPERTY LOCATED AT 850 RUSHMORE AVENUE,

1. ALL INSTALLED EROSION AND SEDIMENT CONTROL DEVICES SHALL CONFORM TO NYSDEC NEW YORK STANDARDS AND SPECIFICATIONS FOR EROSION AND SEDIMENT CONTROL DATED 2016 OR AS AMENDED.

2. SEDIMENT AND EROSION CONTROL INSTALLATION AND MAINTENANCE MEASURES SHALL MEET THE REQUIREMENTS OF THE NEW YORK STANDARDS AND SPECIFICATIONS FOR EROSION AND SEDIMENT CONTROL.

3. THE OWNER/APPLICANT SHALL ENSURE THAT TEMPORARY AND PERMANENT SOIL EROSION AND SEDIMENT CONTROL FEATURES ARE DESIGNED, INSTALLED AND MAINTAINED FOR THE DURATION OF THE PROJECT IN ORDER TO PREVENT SOIL DISTURBANCES FROM HAVING A NEGATIVE OR ADVERSE EFFECT ON ADJACENT

4. ANY POTENTIALLY EROSIVE MATERIAL TEMPORARILY STOCKPILED ON THE SITE DURING THE CONSTRUCTION PROCESS SHALL BE LOCATED IN AN AREA AWAY FROM STORM DRAINAGE AND SHALL BE PROPERLY PROTECTED FROM EROSION BY A SURROUNDING SILT FENCE.

5. DISTURBED AREAS WHERE WORK IS DELAYED OR COMPLETED SHALL BE STABILIZED WITH TEMPORARY OR PERMANENT VEGETATIVE COVER WITHIN 14 DAYS.

6. DUST CONTROL SHALL BE ACCOMPLISHED BY STANDARD METHODS OF LIGHTLY WATERING ALL EXPOSED SOIL AND RAPIDLY STABILIZING THE RE-GRADED AREAS WITH TOPSOIL, LOAM AND/OR SEEDING.

7. THE VILLAGE OF MAMARONECK SHALL BE NOTIFIED NO LESS THAN 48 HOURS PRIOR TO THE START OF ANY SITE WORK AND, BY SUCH NOTIFICATION, SHALL BE PROVIDED WITH THE NAME AND TELEPHONE NUMBER OF THE GENERAL CONTRACTOR RESPONSIBLE FOR SUCH WORK.

8. THE VILLAGE OF MAMARONECK MAY INSPECT EROSION AND SEDIMENT CONTROL PRACTICES TO DETERMINE THEIR EFFECTIVENESS AND MAY REQUIRE ADDITIONAL MEASURES, AS DEEMED NECESSARY.

9. ALL EROSION CONTROL MEASURES EMPLOYED DURING THE CONSTRUCTION PROCESS SHALL BE INSPECTED AND MAINTAINED BY THE CONTRACTOR FOR CONFORMANCE WITH NYSDEC STANDARDS. SEDIMENT SHALL BE REMOVED WHEN THE ACCUMULATION REACHES 50% OF THE EFFECTIVE DEPTH.

10. TEMPORARY EROSION AND SEDIMENT CONTROL MEASURES SHALL BE REMOVED ONCE THE DISTURBED AREAS

1. INSTALL PERIMETER MEASURES AND CONSTRUCTION FENCING PRIOR TO MOBILIZATION.

2. IDENTIFY CRITICAL AREAS INCLUDING STAGING AREAS, VEHICULAR PARKING AREAS AND STOCKPILE AREAS

4. PROCEED WITH CONSTRUCTION OF FOUNDATION.

7. CONTINUE WITH EARTHWORK AND GRADING OPERATIONS.

11. REMOVE ACCUMULATED SEDIMENT FROM THE STORM SYSTEM AND WATER QUALITY DEVICES. 12. REMOVE ALL TEMPORARY SEDIMENT AND EROSION CONTROL MEASURES ONCE THE SITE HAS BEEN

13. EVALUATE POST-DEVELOPMENT RUNOFF CONDITIONS TO VERIFY THAT THE SITE RUNOFF IS EFFECTIVELY





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ADDITION

REMODEL


# date	issue
9.30.22	ARB
04.05.23	SITE PLAN APP

#### **Erosion and Sediment** Control Plan

project:	20023
drawn by:	MAD
checked by:	PAC
date:	02.14.23
scale:	I" = 10'

## **SD-203**

UNAUTHORIZED ALTERATIONS OR ADDITIONS TO THIS DRAWING IS A VIOLATION OF SECTION 7209 (2) OF THE NEW YORK STATE EDUCATION LAW

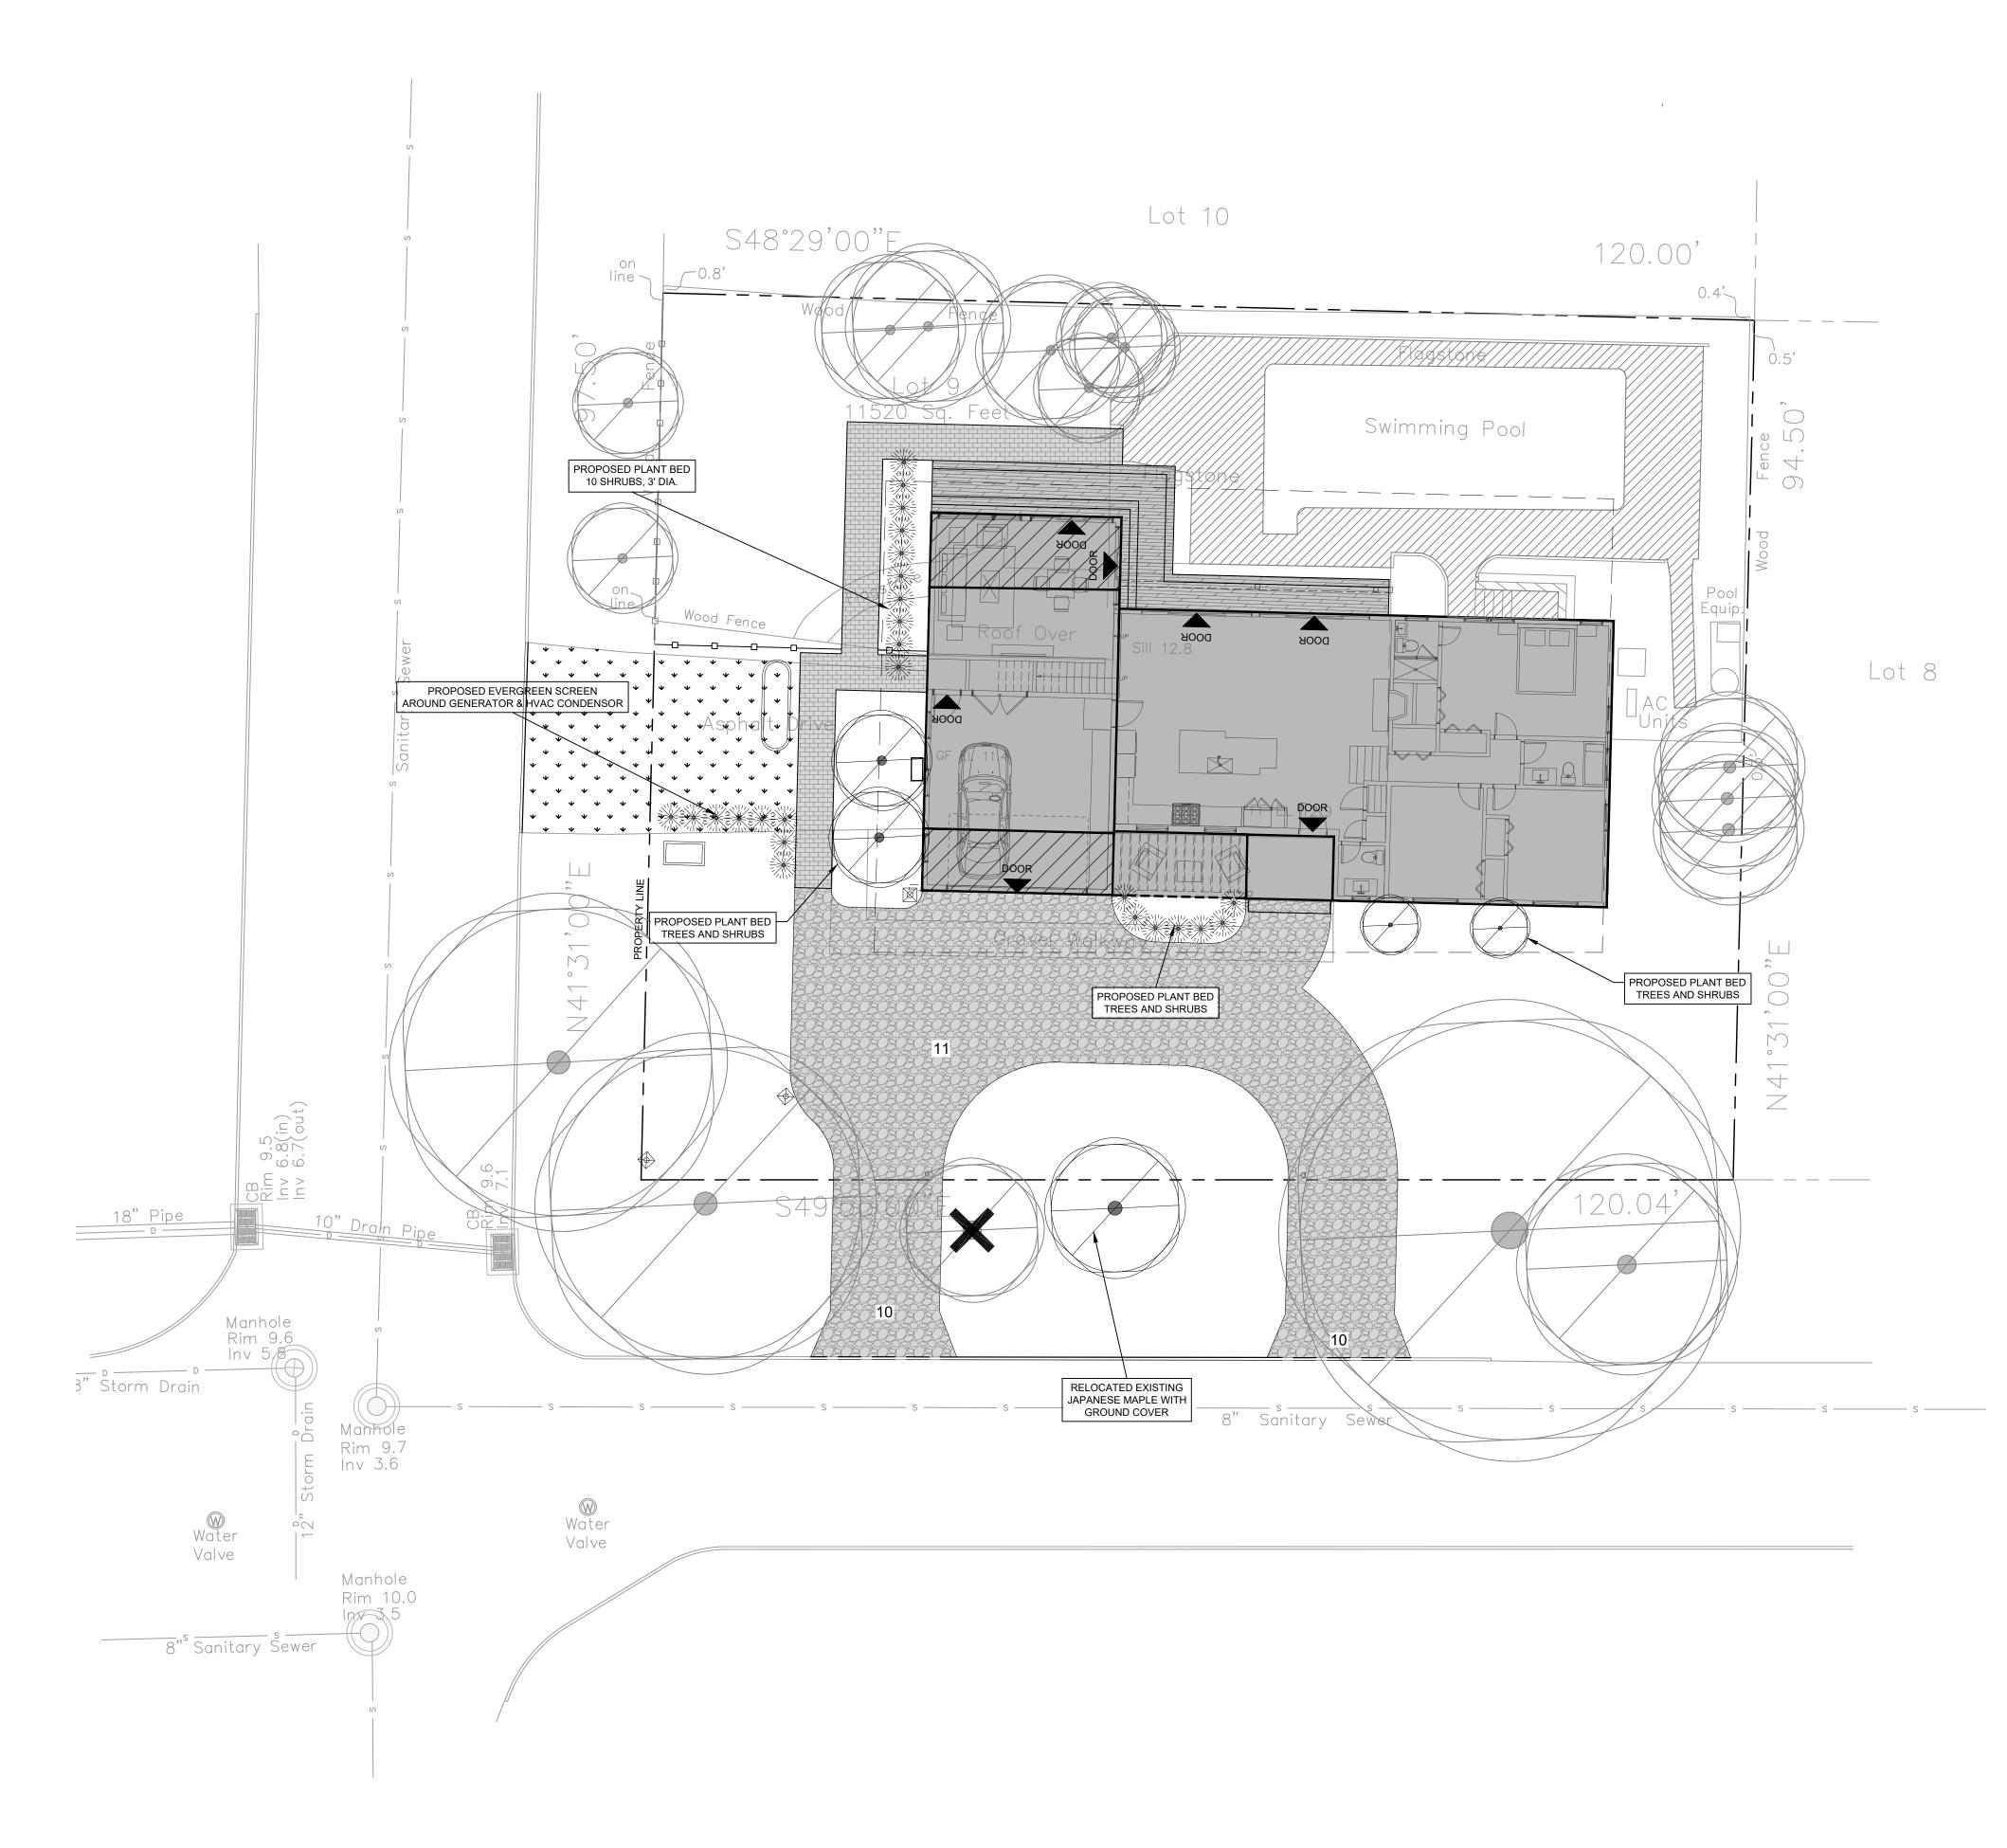


#### BASE NOTES:

1. BASE INFORMATION WAS TAKEN FROM A SURVEY TITLED "SURVEY OF LOT 9 ON A MAP ENTITLED, "ORIENTA PROPERTIES, IN THE VILLAGE OF MAMARONECK & THE TOWN OF MAMARONECK, WESTCHESTER COUNTY, NEW YORK. FILED ON SEPTEMBER 15, 1953 AS MAP NO. 8392" FOR PROPERTY LOCATED AT 850 RUSHMORE AVENUE, PREPARED BY RICHARD A. SPINELLI. 1.1. SURVEYED: NOVEMBER 14, 2003

1.2. SURVEY UPDATED: MAY 14, 2012


1.3. TOPOGRAPHICAL ADDED: NOVEMBER 14, 2020



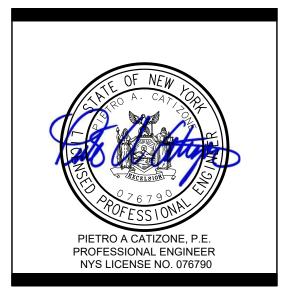





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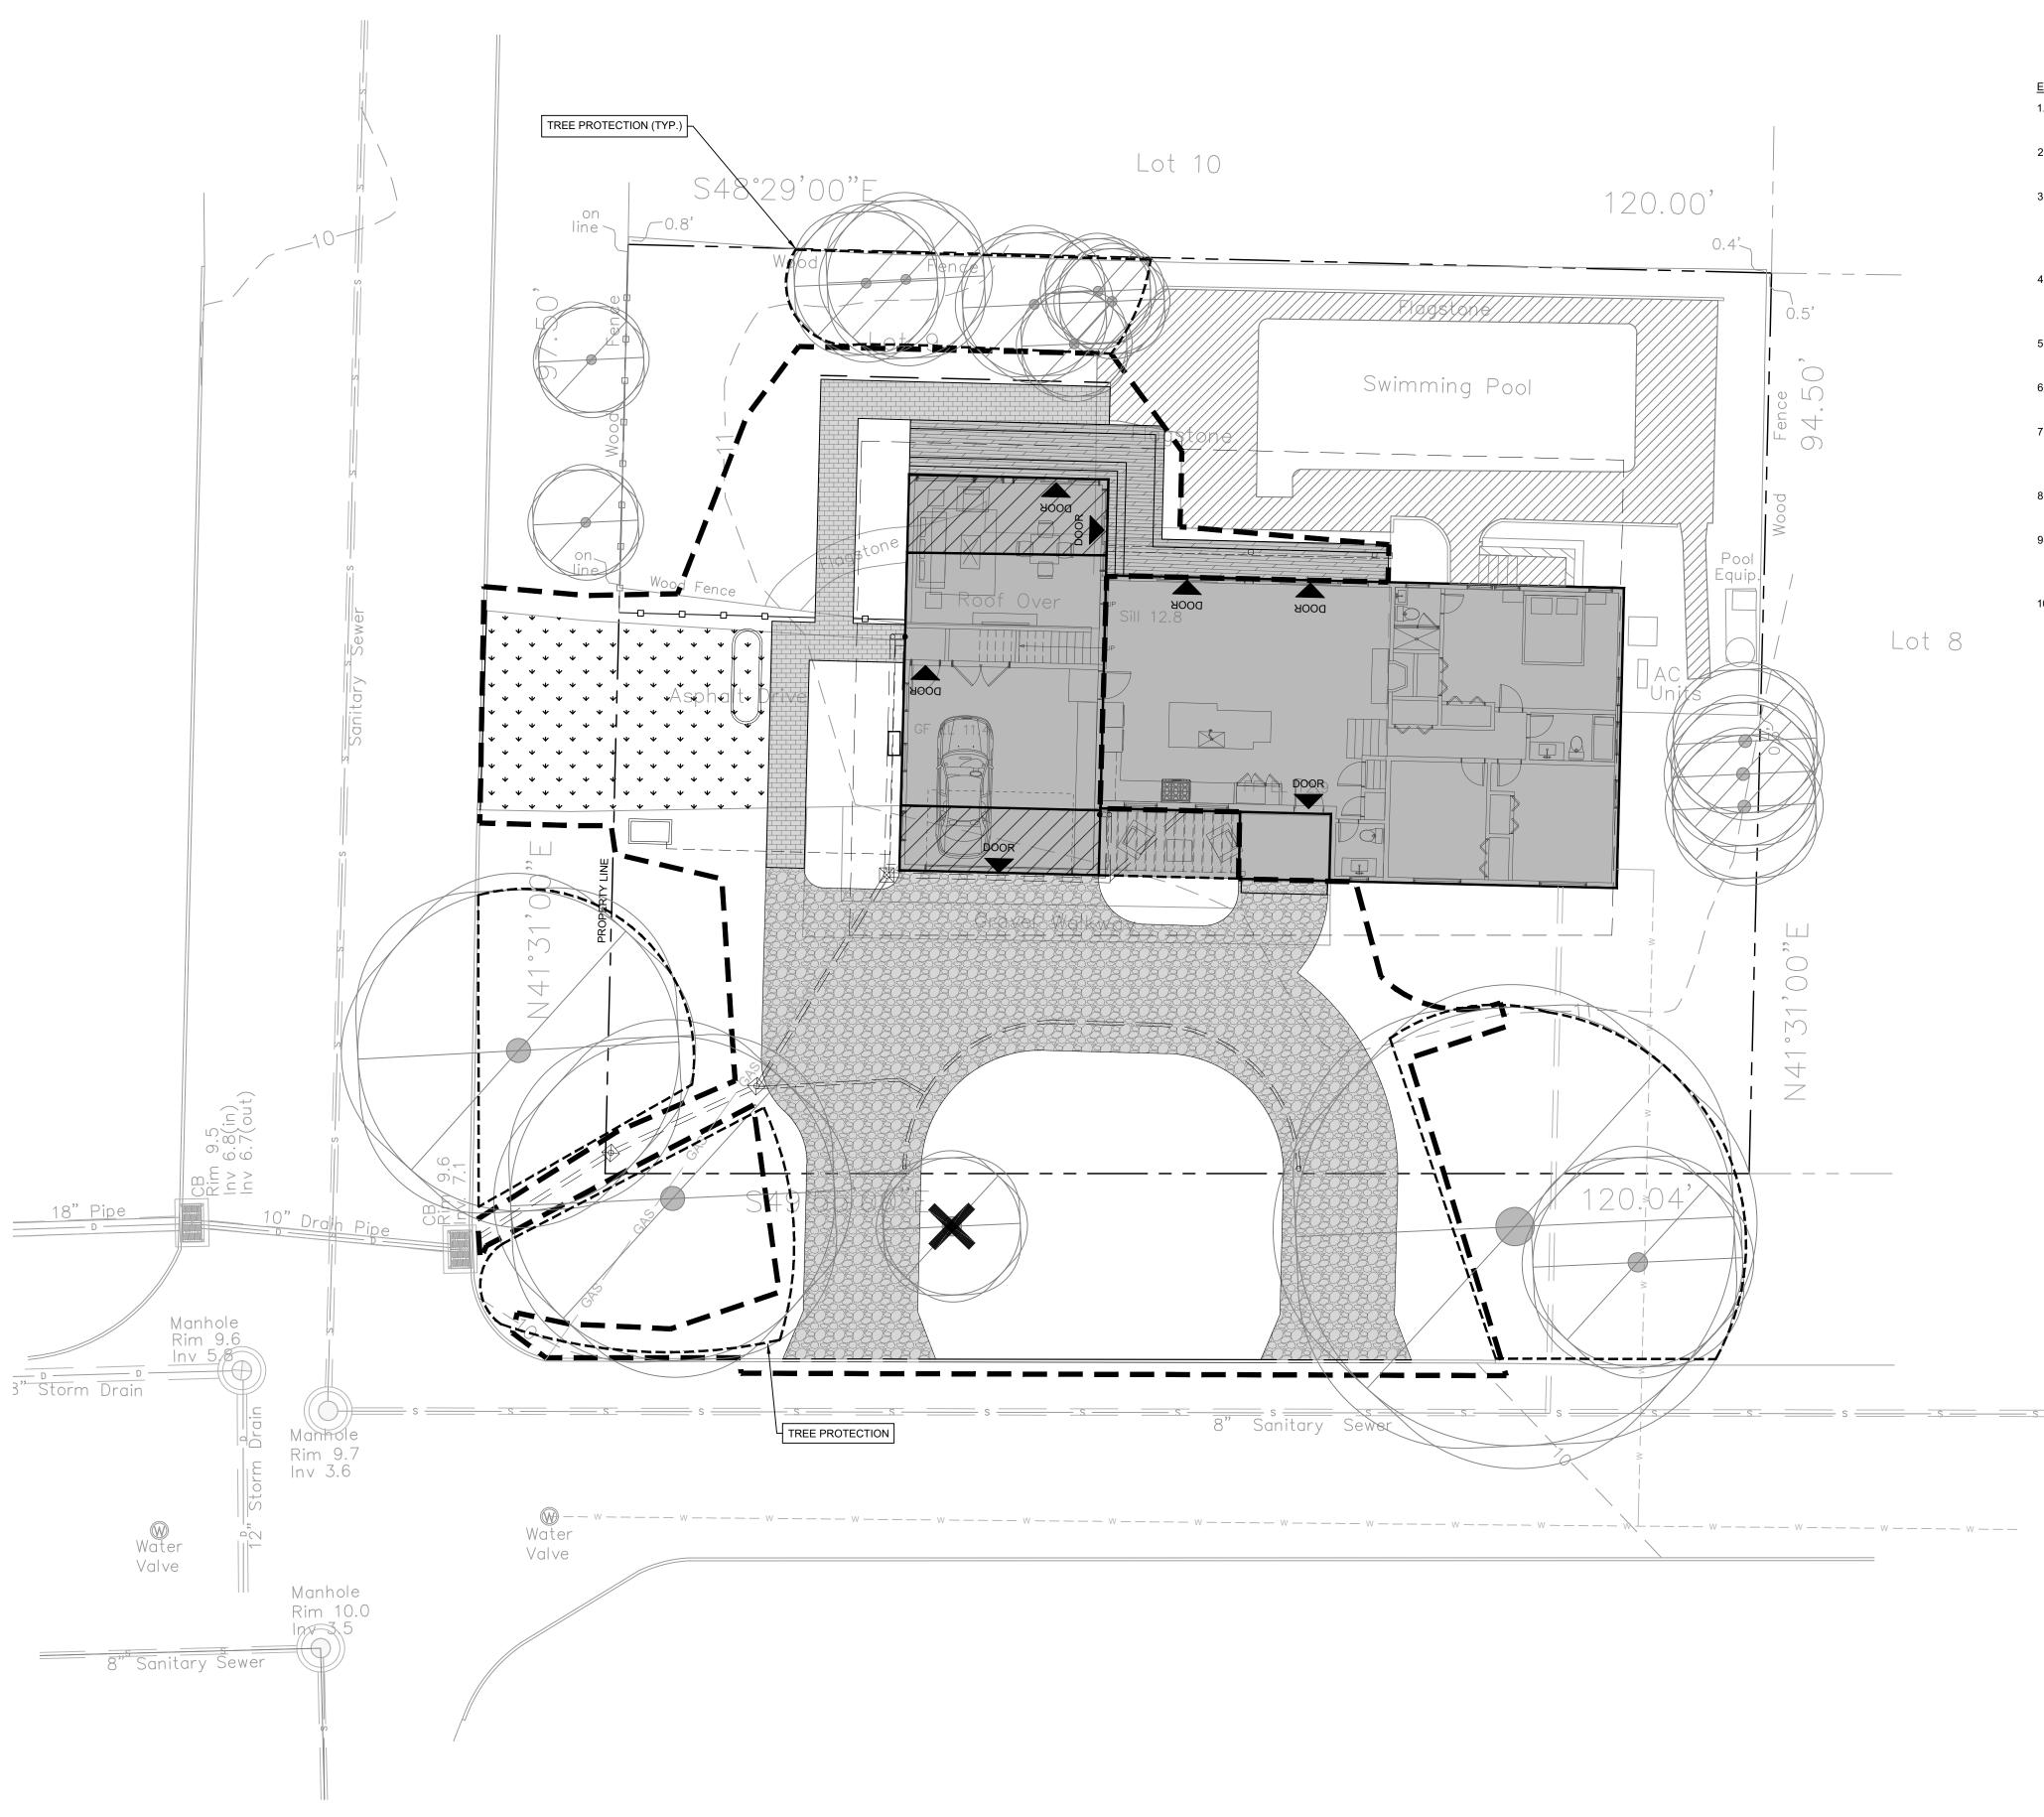

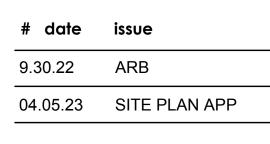
### Landscape Plan

project:	20023
drawn by:	MAD
checked by:	PAC
date:	02.14.23
scale:	I" = I0'



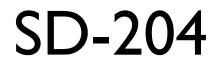

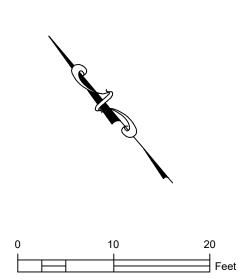

#### BASE NOTES:

- PREPARED BY RICHARD A. SPINELLI.
- 1.1. SURVEYED: NOVEMBER 14, 2003
- 1.2. SURVEY UPDATED: MAY 14, 2012 1.3. TOPOGRAPHICAL ADDED: NOVEMBER 14, 2020
- EROSION AND SEDIMENT CONTROL NOTES:

PROPERTIES.

- REMOVED WHEN THE ACCUMULATION REACHES 50% OF THE EFFECTIVE DEPTH.
- HAVE BEEN STABILIZED.

Manhole

Rim 10.3 lnv 4.5

1. BASE INFORMATION WAS TAKEN FROM A SURVEY TITLED "SURVEY OF LOT 9 ON A MAP ENTITLED, "ORIENTA PROPERTIES, IN THE VILLAGE OF MAMARONECK & THE TOWN OF MAMARONECK, WESTCHESTER COUNTY, NEW YORK. FILED ON SEPTEMBER 15, 1953 AS MAP NO. 8392" FOR PROPERTY LOCATED AT 850 RUSHMORE AVENUE,

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2. SEDIMENT AND EROSION CONTROL INSTALLATION AND MAINTENANCE MEASURES SHALL MEET THE REQUIREMENTS OF THE NEW YORK STANDARDS AND SPECIFICATIONS FOR EROSION AND SEDIMENT CONTROL.

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4. ANY POTENTIALLY EROSIVE MATERIAL TEMPORARILY STOCKPILED ON THE SITE DURING THE CONSTRUCTION PROCESS SHALL BE LOCATED IN AN AREA AWAY FROM STORM DRAINAGE AND SHALL BE PROPERLY PROTECTED FROM EROSION BY A SURROUNDING SILT FENCE.

5. DISTURBED AREAS WHERE WORK IS DELAYED OR COMPLETED SHALL BE STABILIZED WITH TEMPORARY OR PERMANENT VEGETATIVE COVER WITHIN 14 DAYS.


6. DUST CONTROL SHALL BE ACCOMPLISHED BY STANDARD METHODS OF LIGHTLY WATERING ALL EXPOSED SOIL AND RAPIDLY STABILIZING THE RE-GRADED AREAS WITH TOPSOIL, LOAM AND/OR SEEDING.


7. THE VILLAGE OF MAMARONECK SHALL BE NOTIFIED NO LESS THAN 48 HOURS PRIOR TO THE START OF ANY SITE WORK AND, BY SUCH NOTIFICATION, SHALL BE PROVIDED WITH THE NAME AND TELEPHONE NUMBER OF THE GENERAL CONTRACTOR RESPONSIBLE FOR SUCH WORK.

8. THE VILLAGE OF MAMARONECK MAY INSPECT EROSION AND SEDIMENT CONTROL PRACTICES TO DETERMINE THEIR EFFECTIVENESS AND MAY REQUIRE ADDITIONAL MEASURES, AS DEEMED NECESSARY.


9. ALL EROSION CONTROL MEASURES EMPLOYED DURING THE CONSTRUCTION PROCESS SHALL BE INSPECTED AND MAINTAINED BY THE CONTRACTOR FOR CONFORMANCE WITH NYSDEC STANDARDS. SEDIMENT SHALL BE

10. TEMPORARY EROSION AND SEDIMENT CONTROL MEASURES SHALL BE REMOVED ONCE THE DISTURBED AREAS

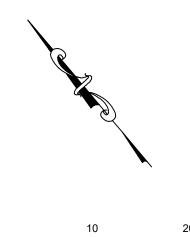

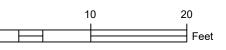



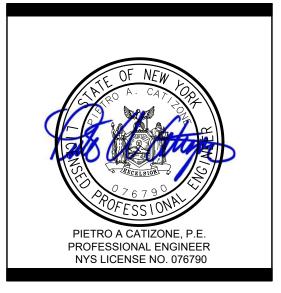




# date	issue
9.30.22	ARB
04.05.23	SITE PLAN APP

#### TREE PROTECTION PLAN


project:	20023
drawn by:	MAD
checked by:	PAC
date:	02.14.23
scale:	I" = I0'

## SD-205

UNAUTHORIZED ALTERATIONS OR ADDITIONS TO THIS DRAWING IS A VIOLATION OF SECTION 7209 (2) OF THE NEW YORK STATE EDUCATION LAW

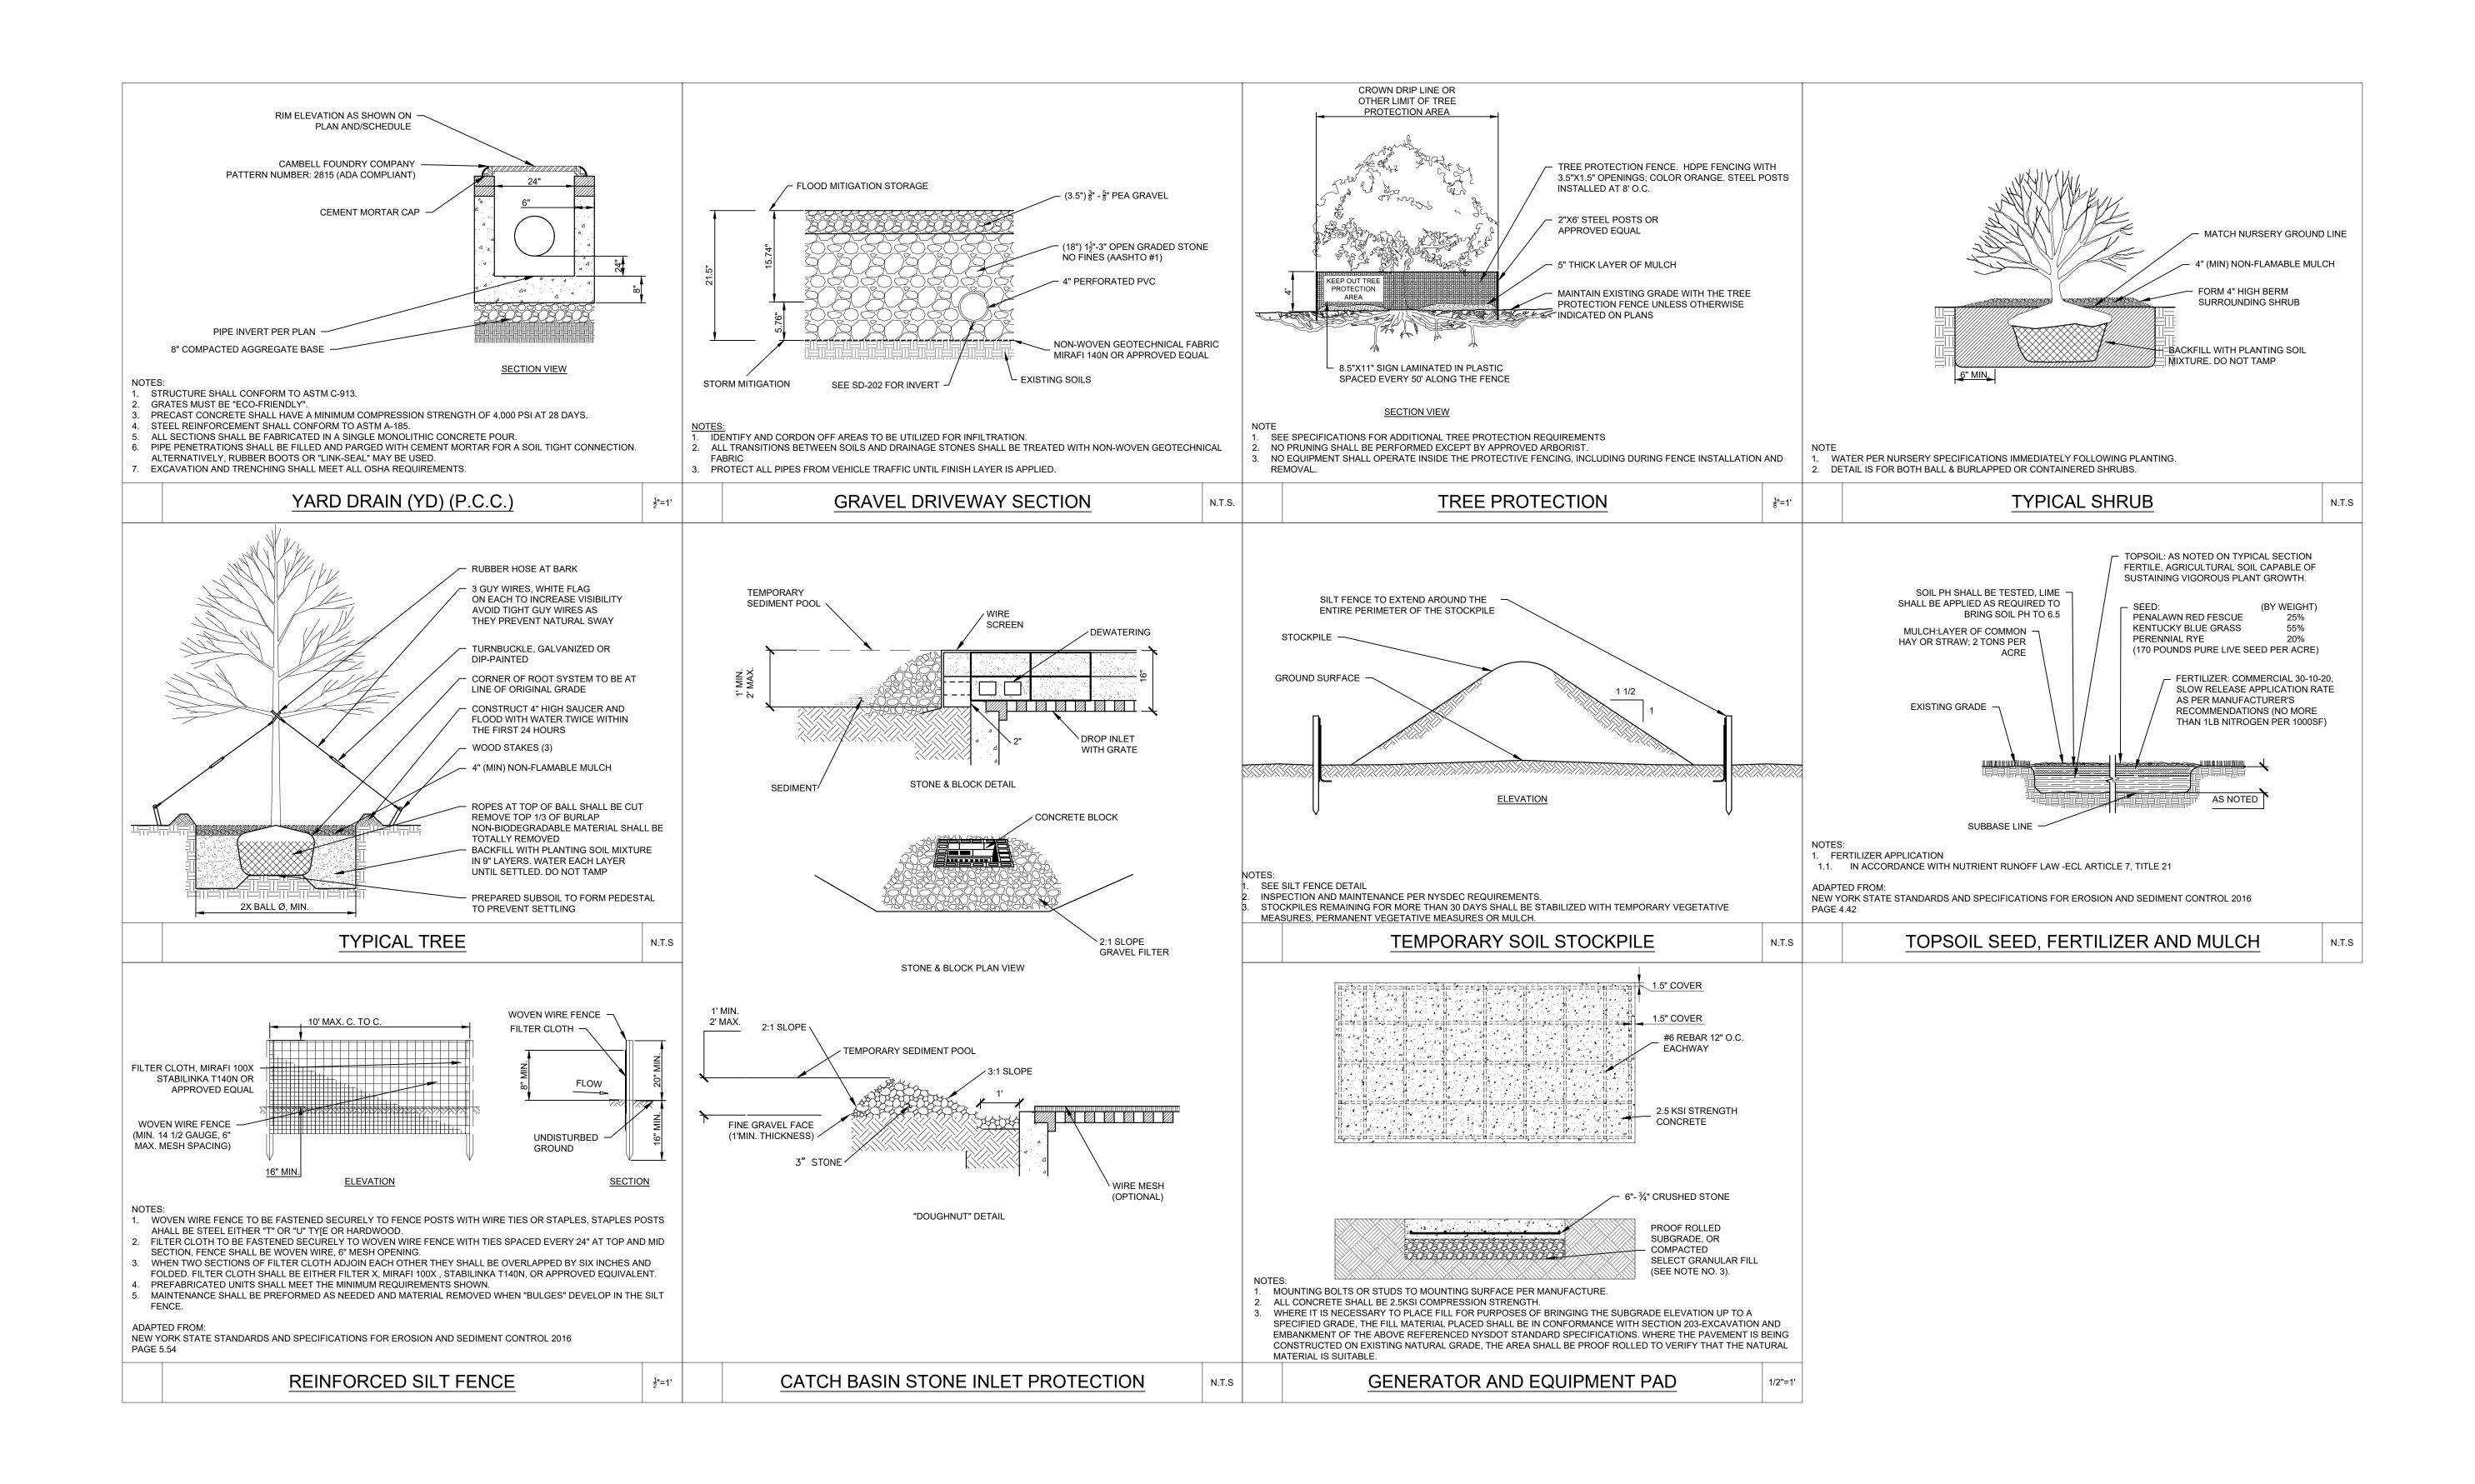

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**ADDITION** 
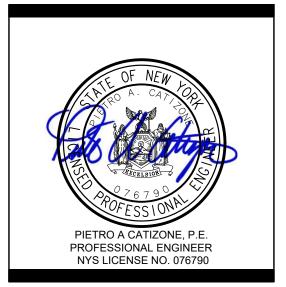
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REMODEL

850 Rushmore Ave. Mamaroneck, NY 10543


# date	issue
9.30.22	ARB
04.05.23	SITE PLAN APP

#### Details

project:	20023
drawn by:	MAD
checked by:	PAC
date:	02.14.23
scale:	As Noted

SD-401

UNAUTHORIZED ALTERATIONS OR ADDITIONS TO THIS DRAWING IS A VIOLATION OF SECTION 7209 (2) OF THE NEW YORK STATE EDUCATION LAW

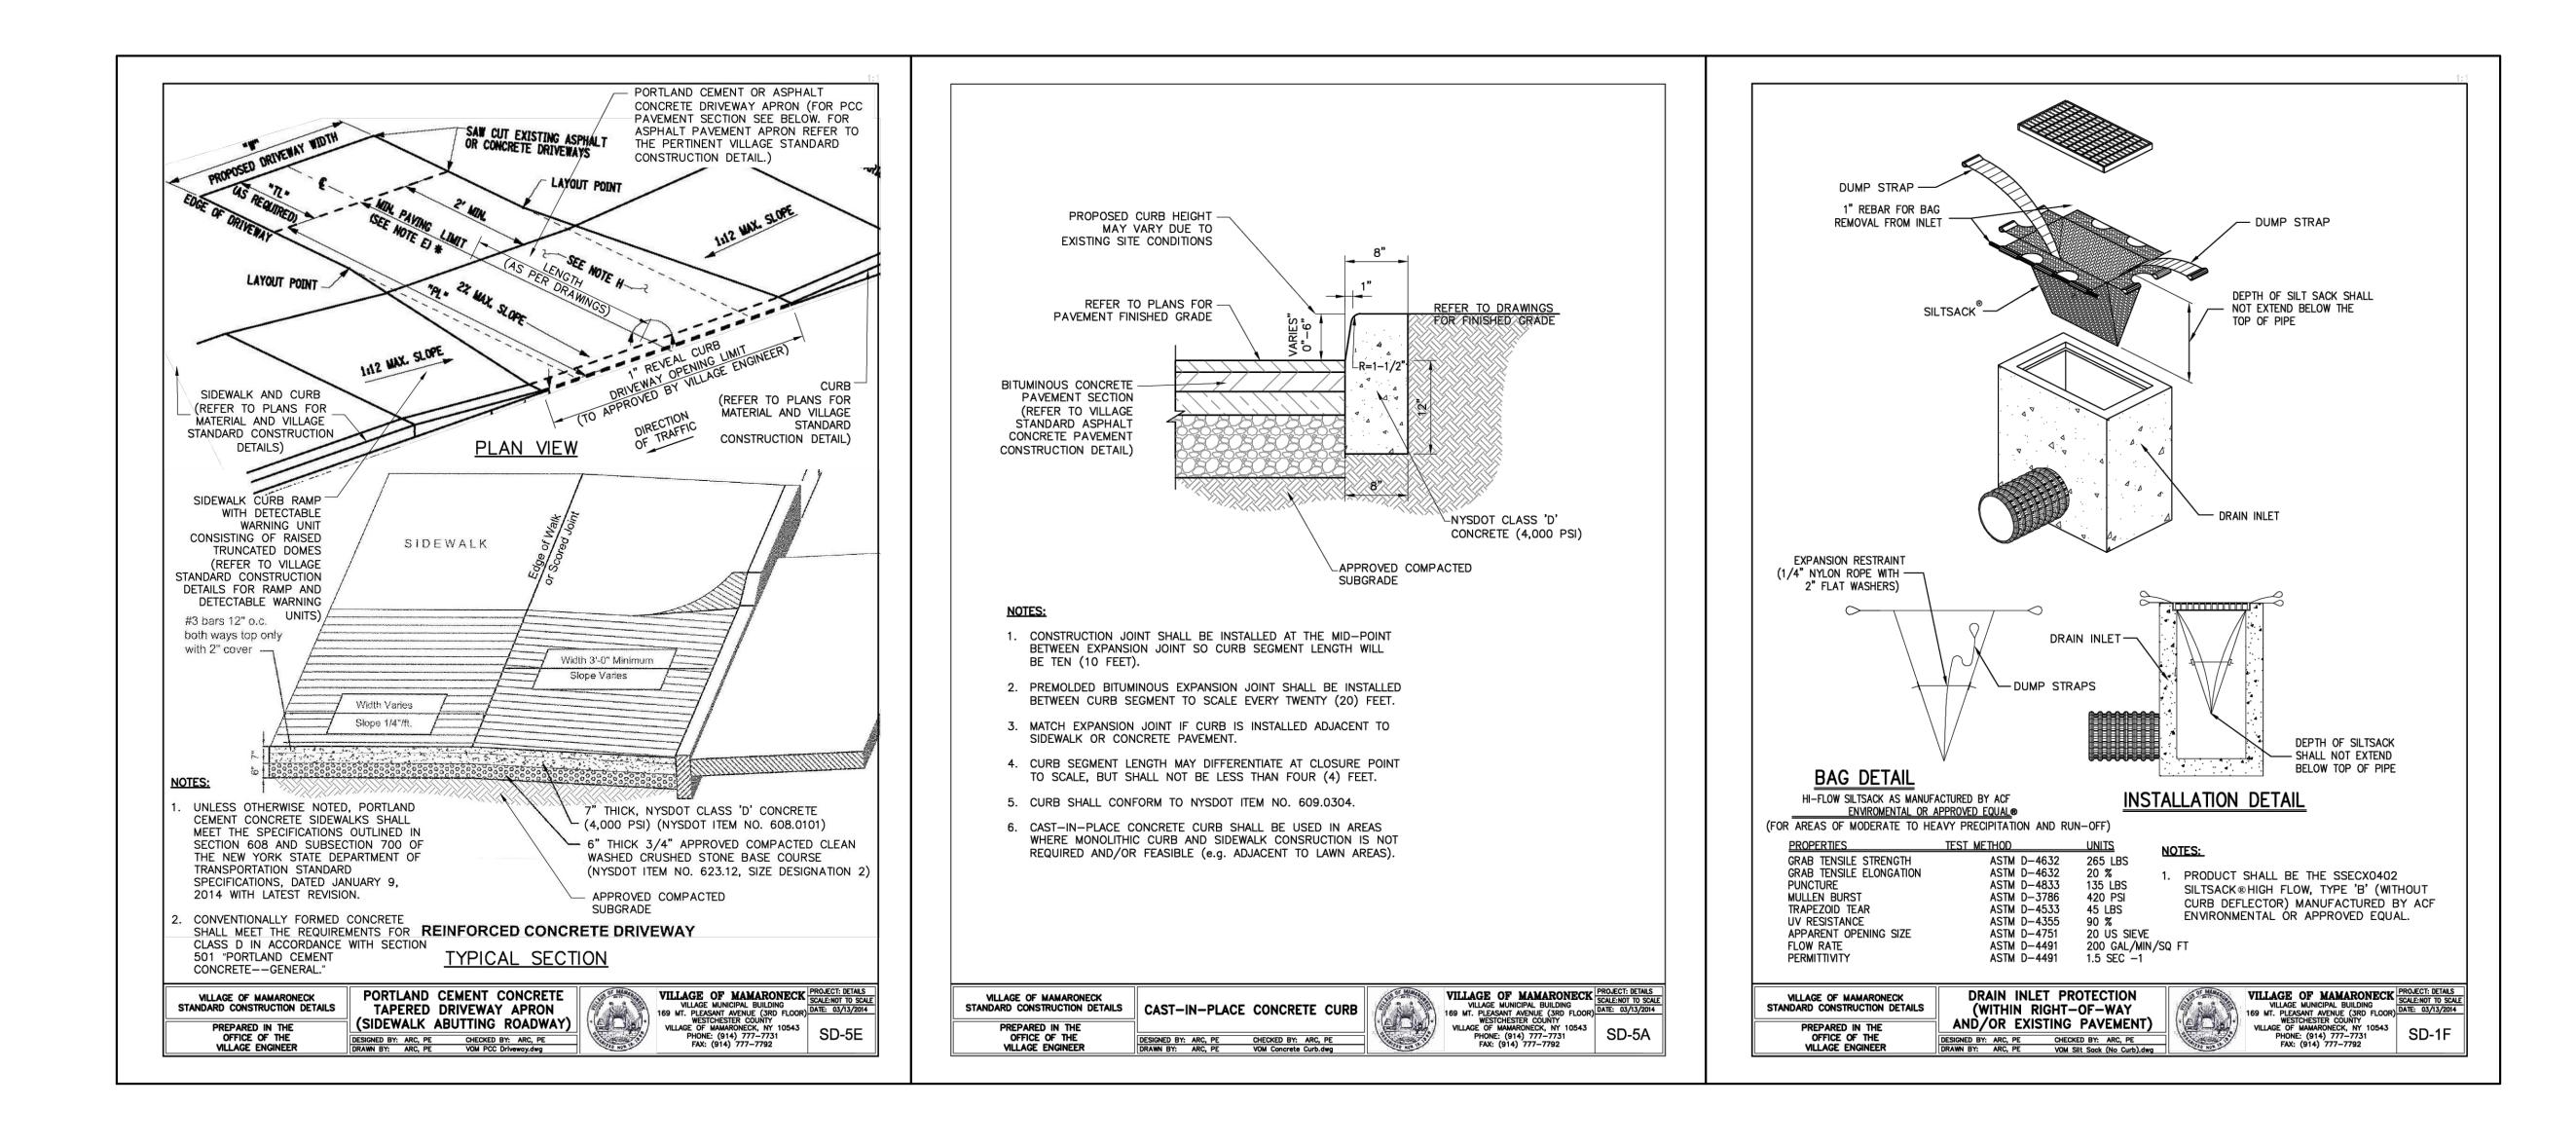







# date	issue
9.30.22	ARB
04.05.23	SITE PLAN APP


#### Details

project:	20023
drawn by:	MAD
checked by:	PAC
date:	02.14.23
scale:	As Noted

SD-402





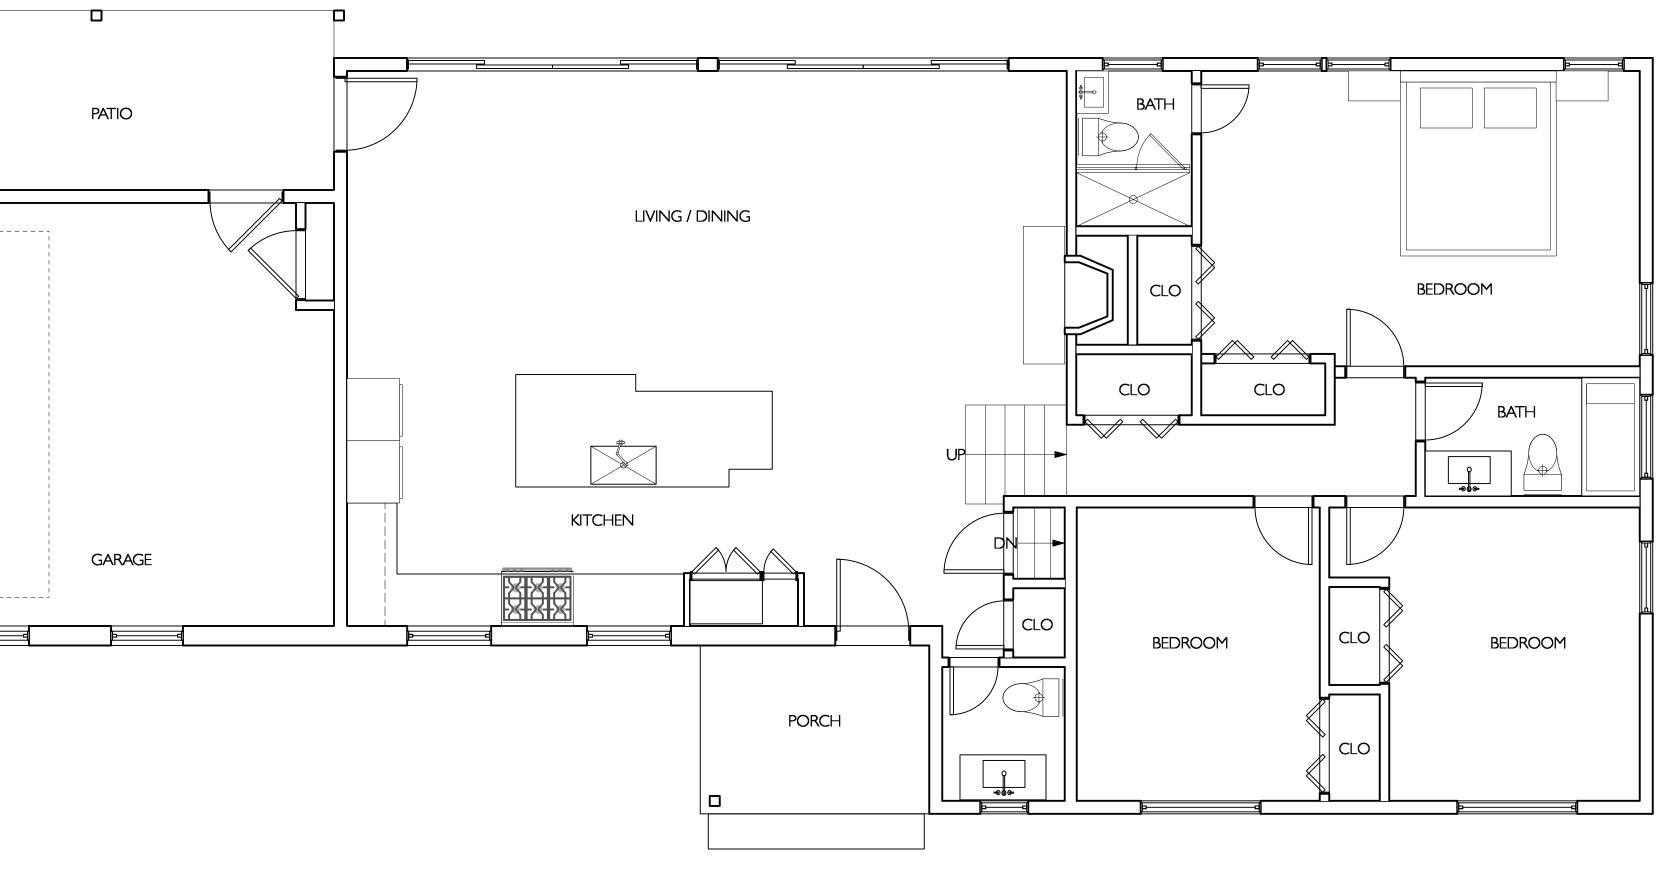



	REMODEL & ADDITION	ASSLER RESIDENCE	850 Rushmore Ave.	Mamaroneck, NY 10543	
	REMC	ΑH	850 Rı	Mama	
#	date	issu	Je		
	9.30.22 1.05.23	ARB SITE P	LAN A	PP	
Exi	sting F	loor Pla	JU		
proje				22.08	
				KJC	

06.30.22

AS NOTED



## KEY


(E) WALL (N) WALL

----- FIXTURE TO DEMO WALL TYPE - SEE A-3 date:

scale:

A-2.0

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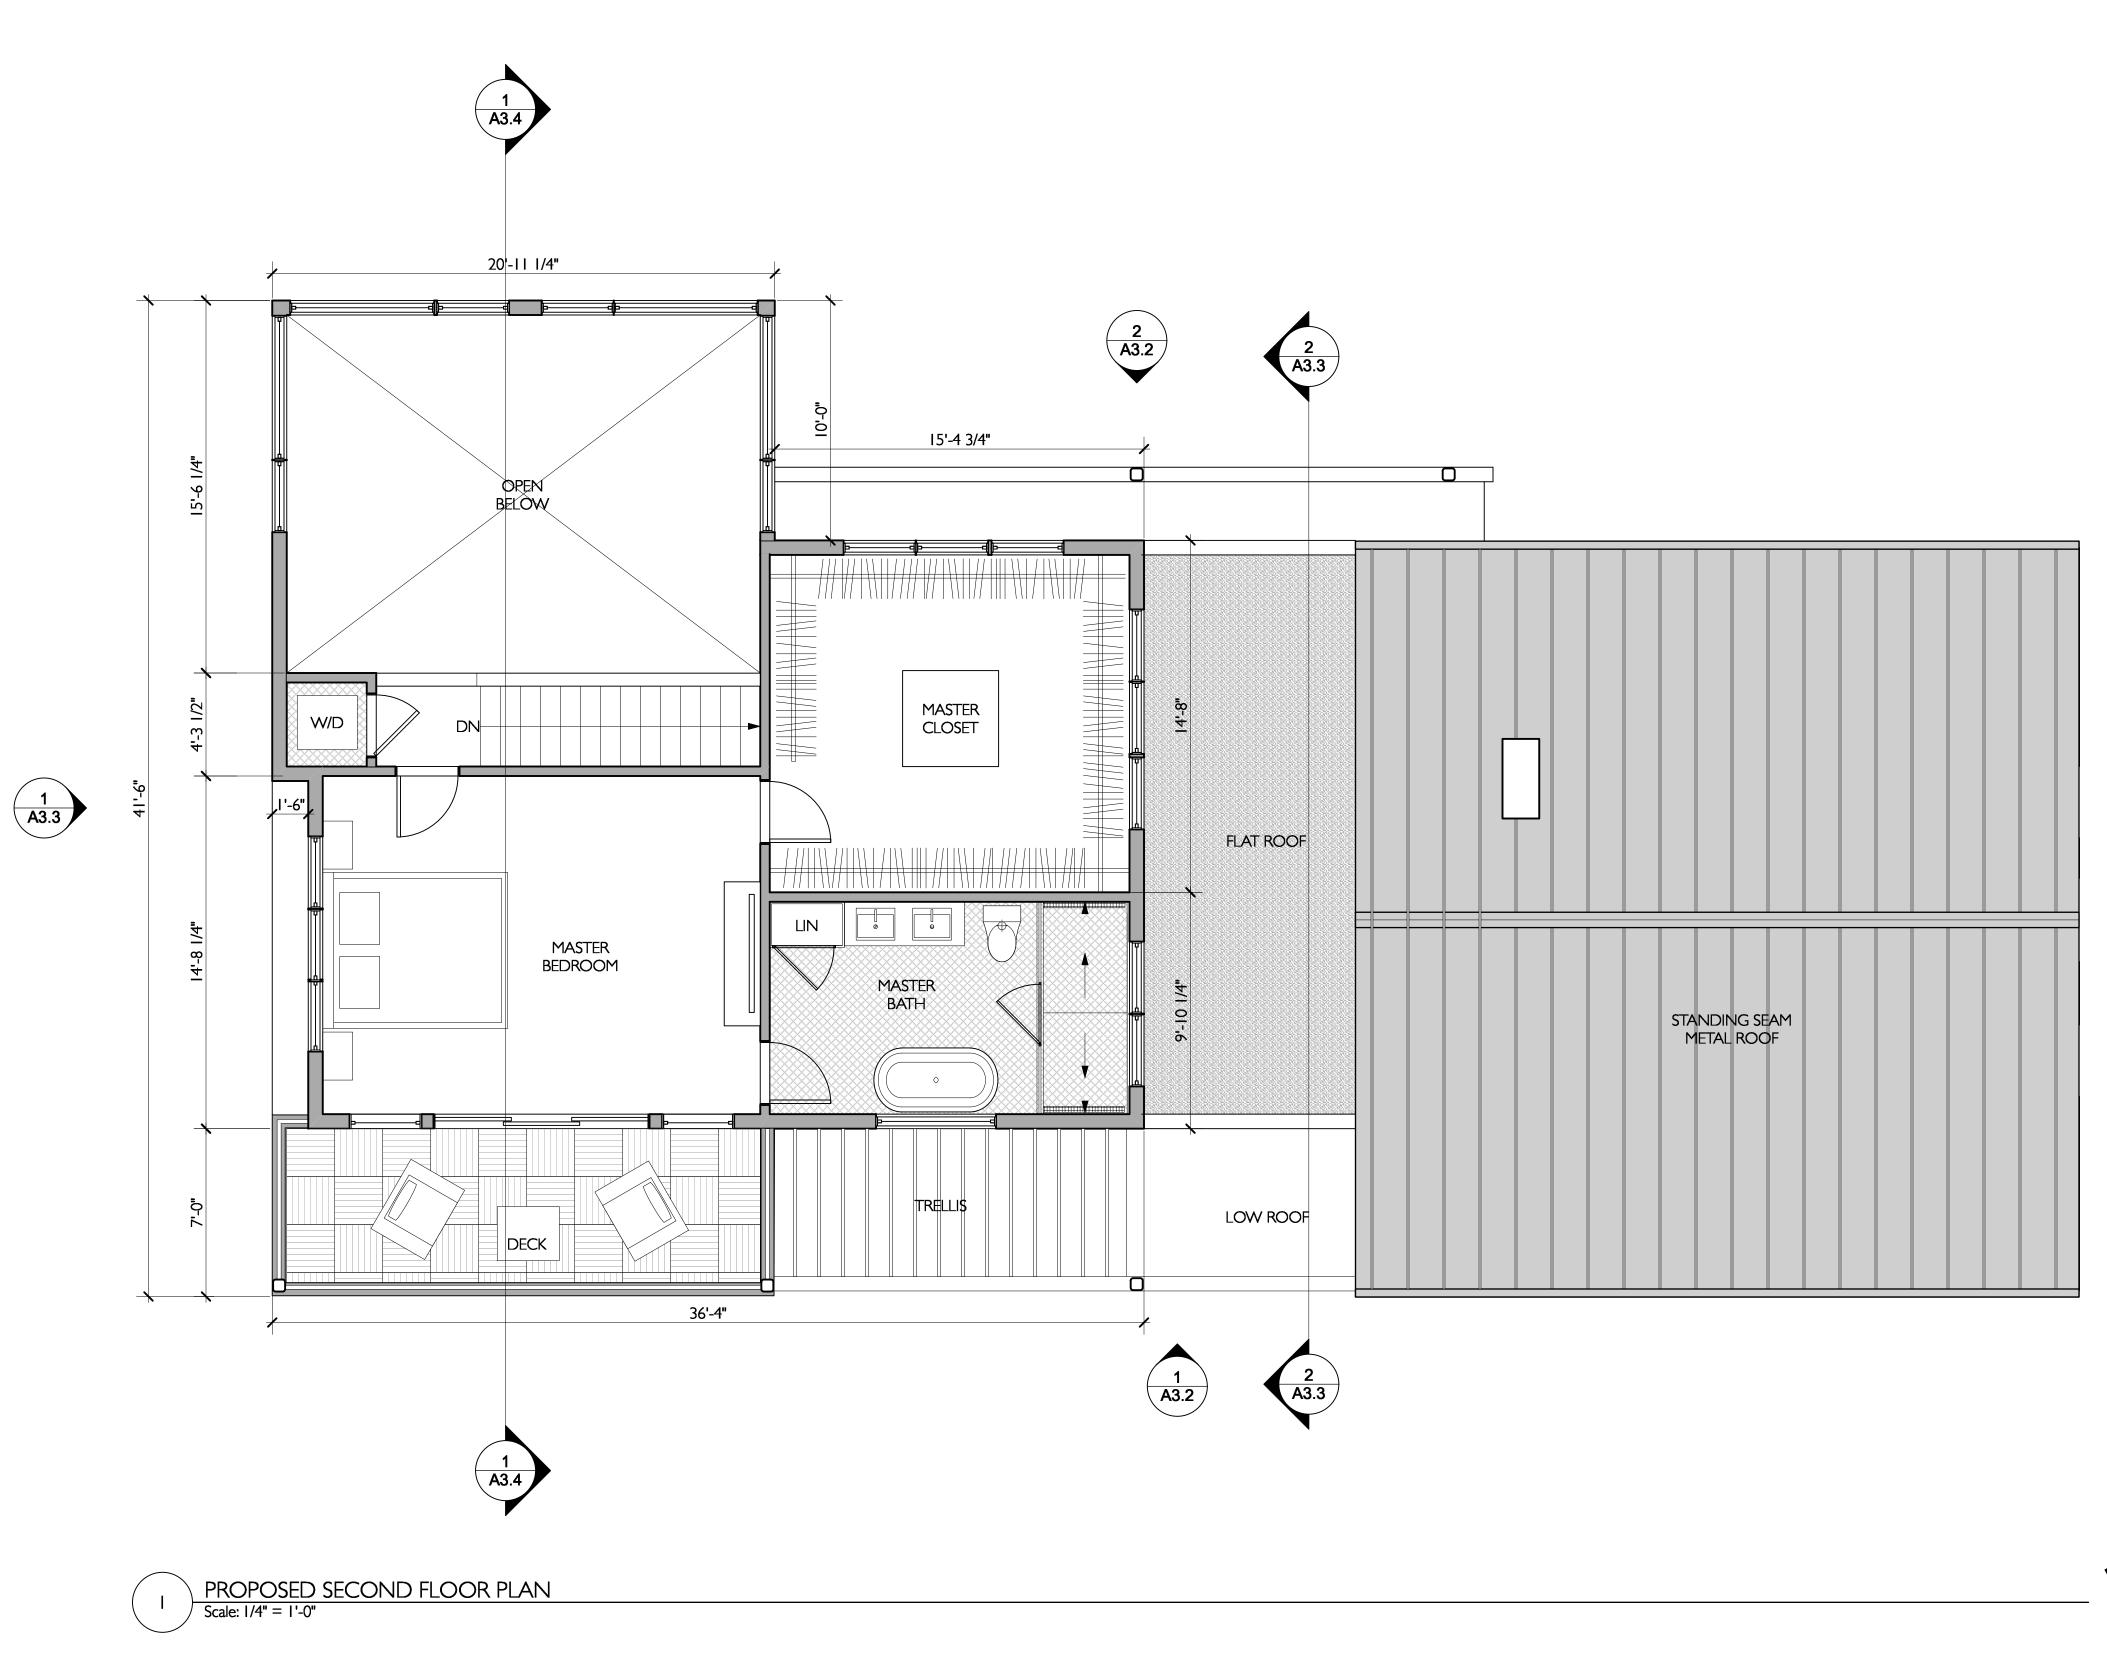
	<b>REMODEL &amp; ADDITION</b>	HASSLER RESIDE	850 Rushmore Ave. Mamaroneck, NY 10543
#	date	issu	e
	09.30.22	ARB	
l	04.05.23	SITE F	PLAN APP
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KEY	

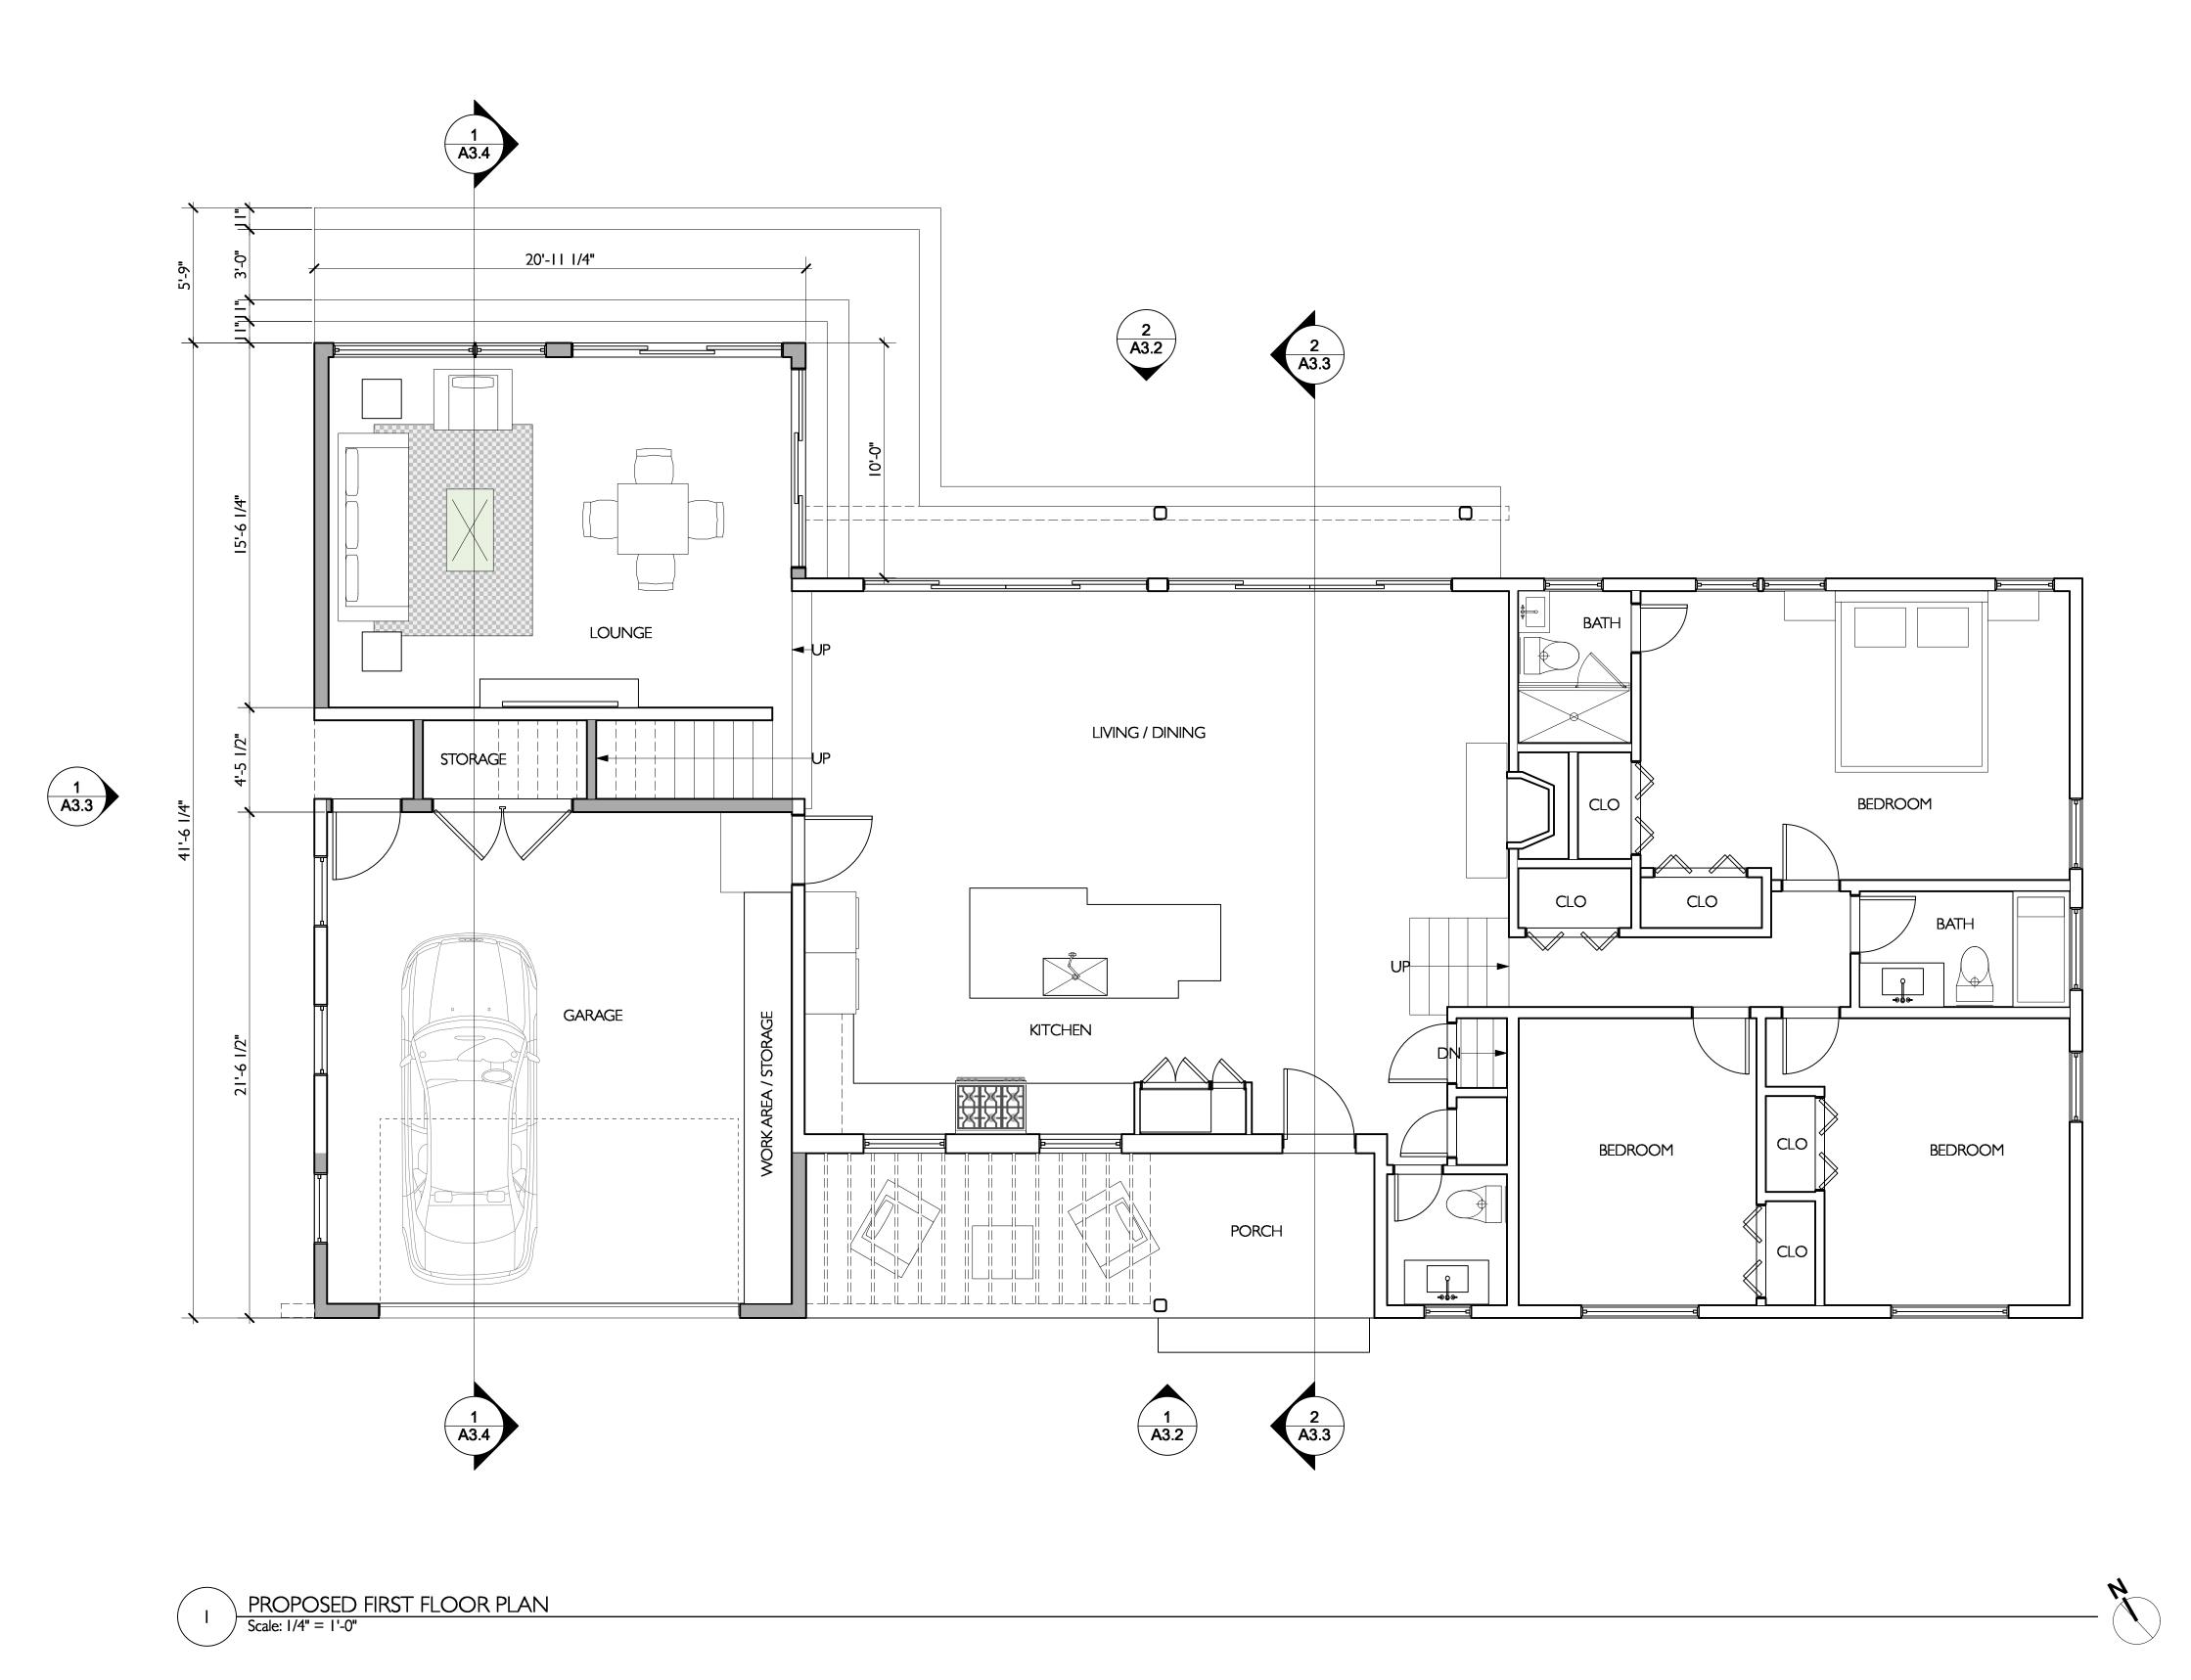(E) WALL (N) WALL 

----- FIXTURE TO DEMO WALL TYPE - SEE A-3



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& ADDITION

REMODEL

hmore Ave. neck, NY 10543 850 Rush Mamaror

#	date	issue
	09.30.22	ARB
	04.05.23	SITE PLAN APP

### Proposed 2nd Floor Plan

project:	22.08
drawn by:	KJC
checked by:	
date:	06.30.22
scale:	AS NOTED


A-2.2





(E) WALL (N) WALL

KEY

----- FIXTURE TO DEMO WALL TYPE - SEE A-3

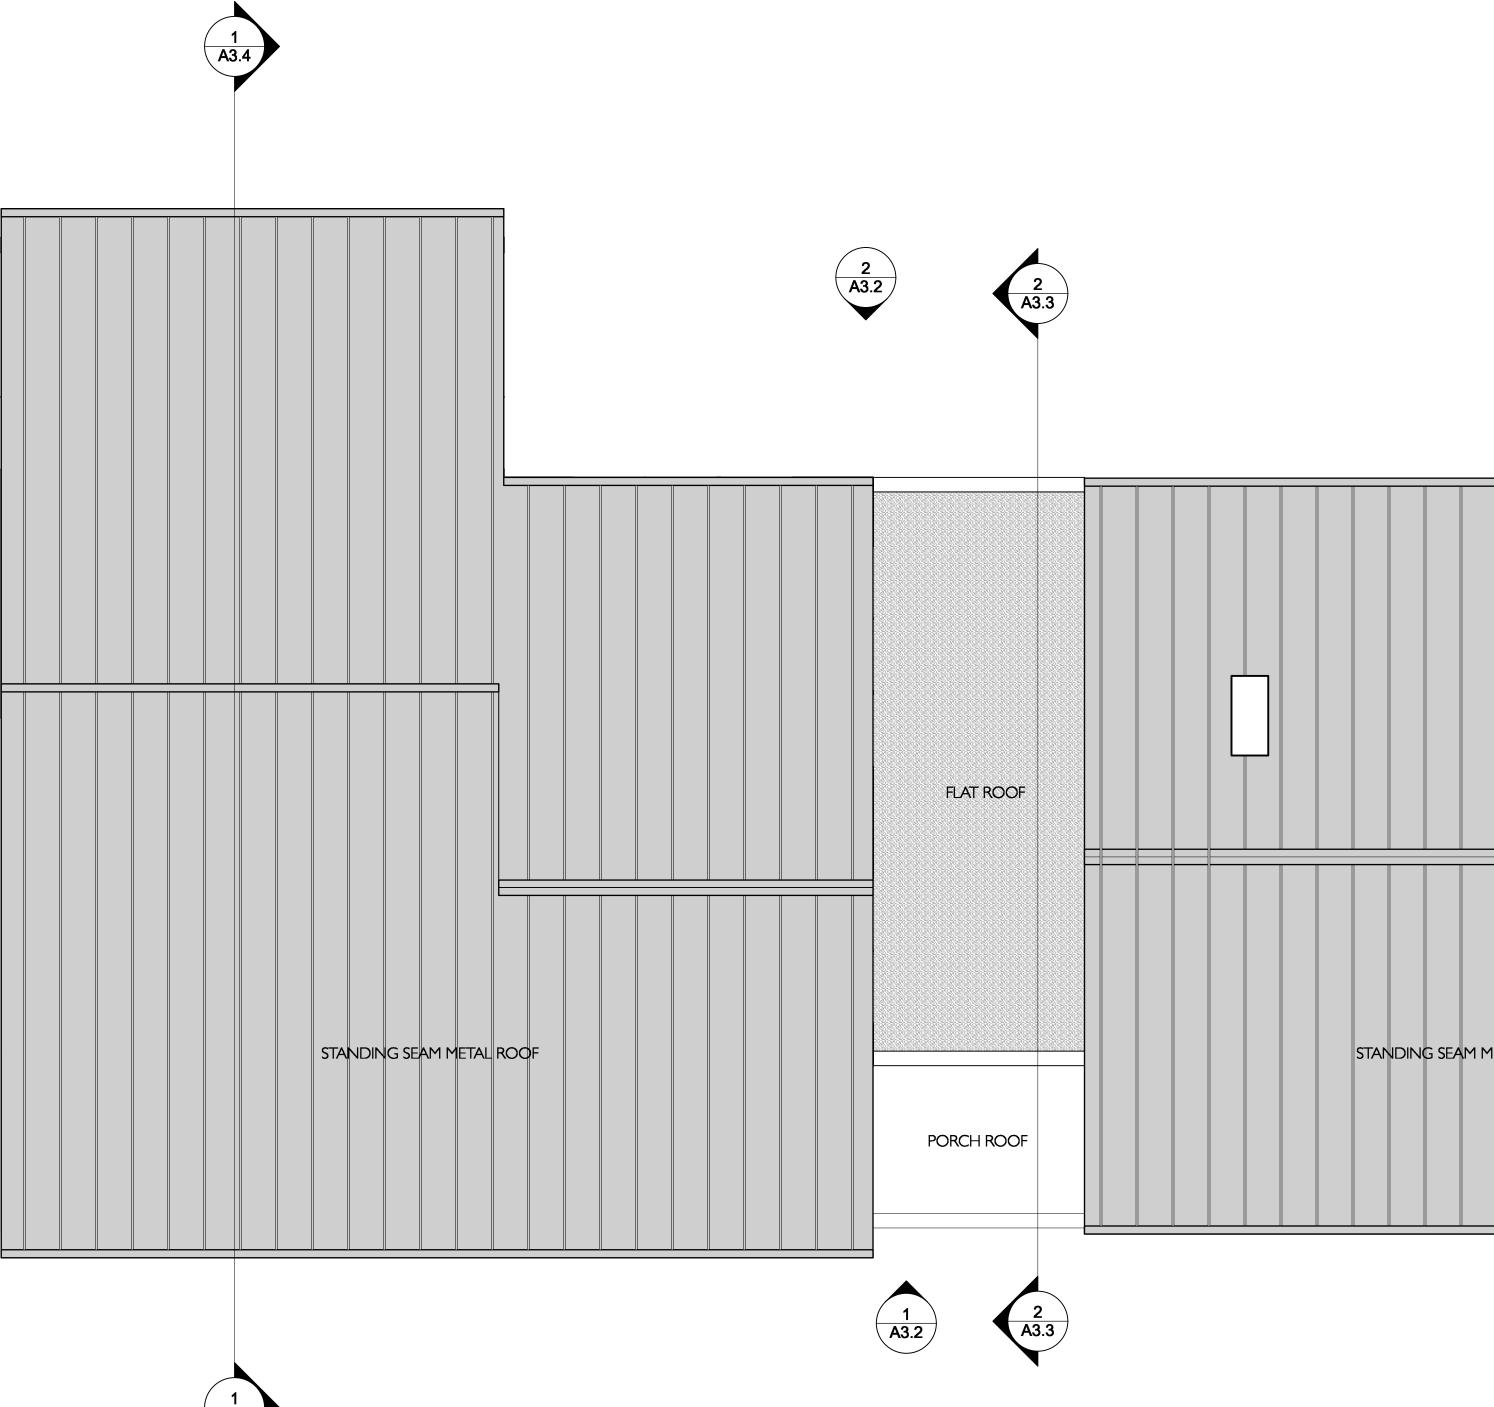

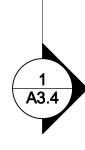

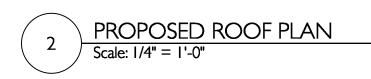

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(E) WALL (N) WALL

KEY

----- FIXTURE TO DEMO WALL TYPE - SEE A-3

\_\_\_\_\_ A-2.3



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NCE HASSLER RESIDE

**REMODEL & ADDITION** 

850 Rushmore Ave. Mamaroneck, NY 10543

# date issue 09.30.22 ARB 04.05.23 SITE PLAN APP

Proposed Roof Plan

22.08 project: \_\_\_\_\_ KJC drawn by: checked by: \_\_\_\_ date: 06.30.22 scale: AS NOTED



4 EXISTING NORTH Scale: 1/4" = 1'-0"	H ELEVATION	





PROPOSED SOUTH ELEVATION Scale: 1/4" = 1'-0"





PROPOSED NORTH ELEVATION Scale: 1/4" = 1'-0" 2

WOOD TONE (OR EQ) RUSTIC— SEARIES SIDING




#### CLEARATORY WINDOWS @ BEDROOM-

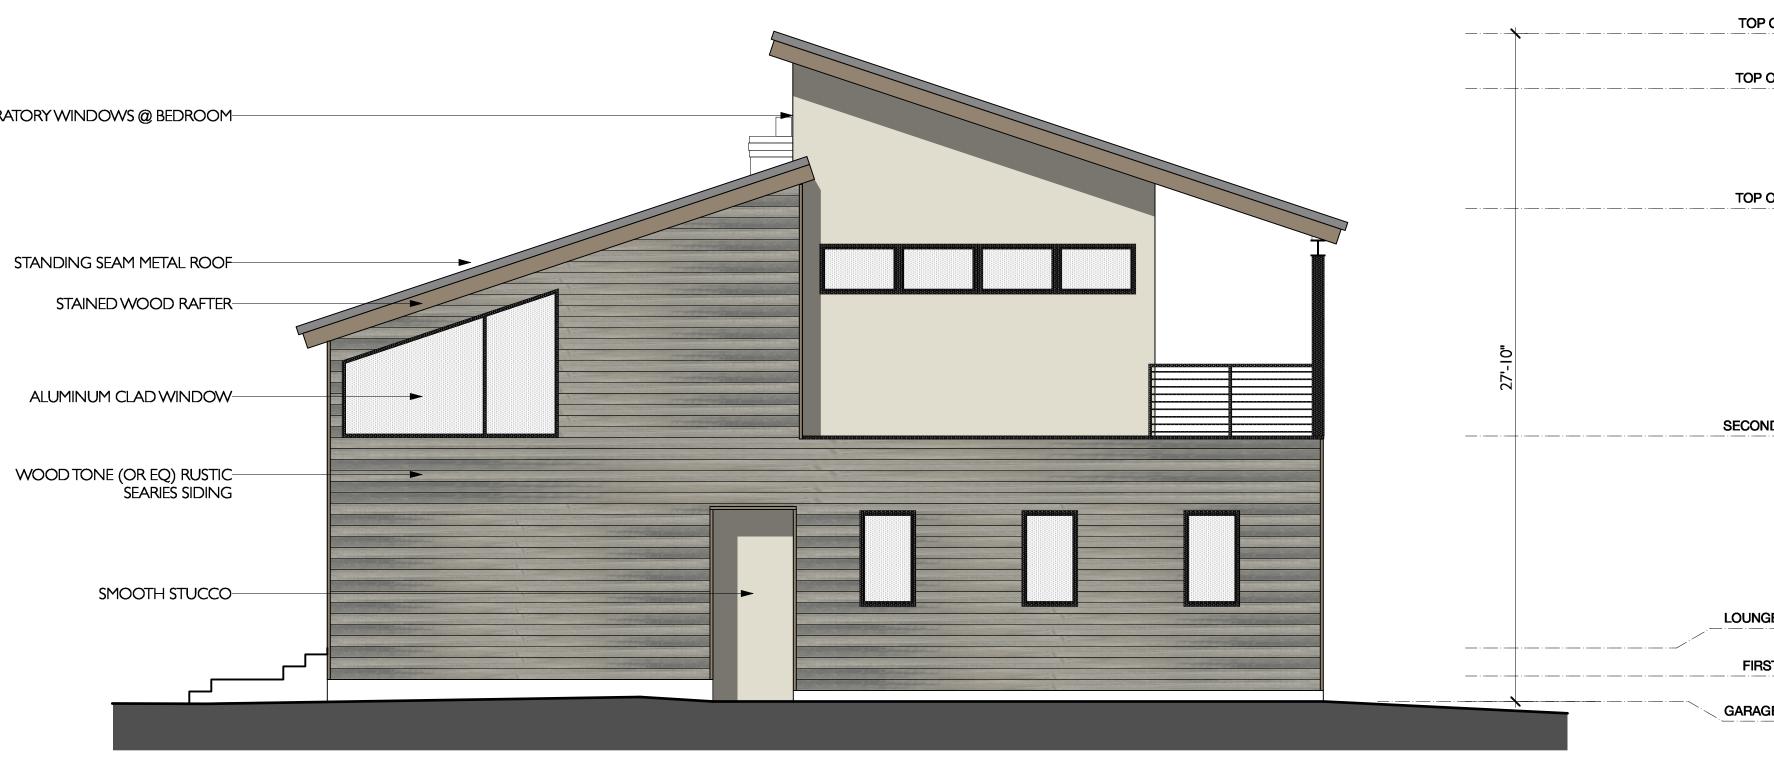

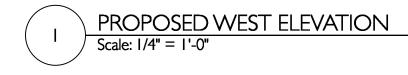


STANDING SEAM METAL ROOF STEEL BEAM-STEEL POST-SMOOTH STUCCO--STEEL GUARD RAIL-ROOF OVER PORCH ENTRY-WOOD TONE (OR EQ) RUSTIC— SEARIES SIDING



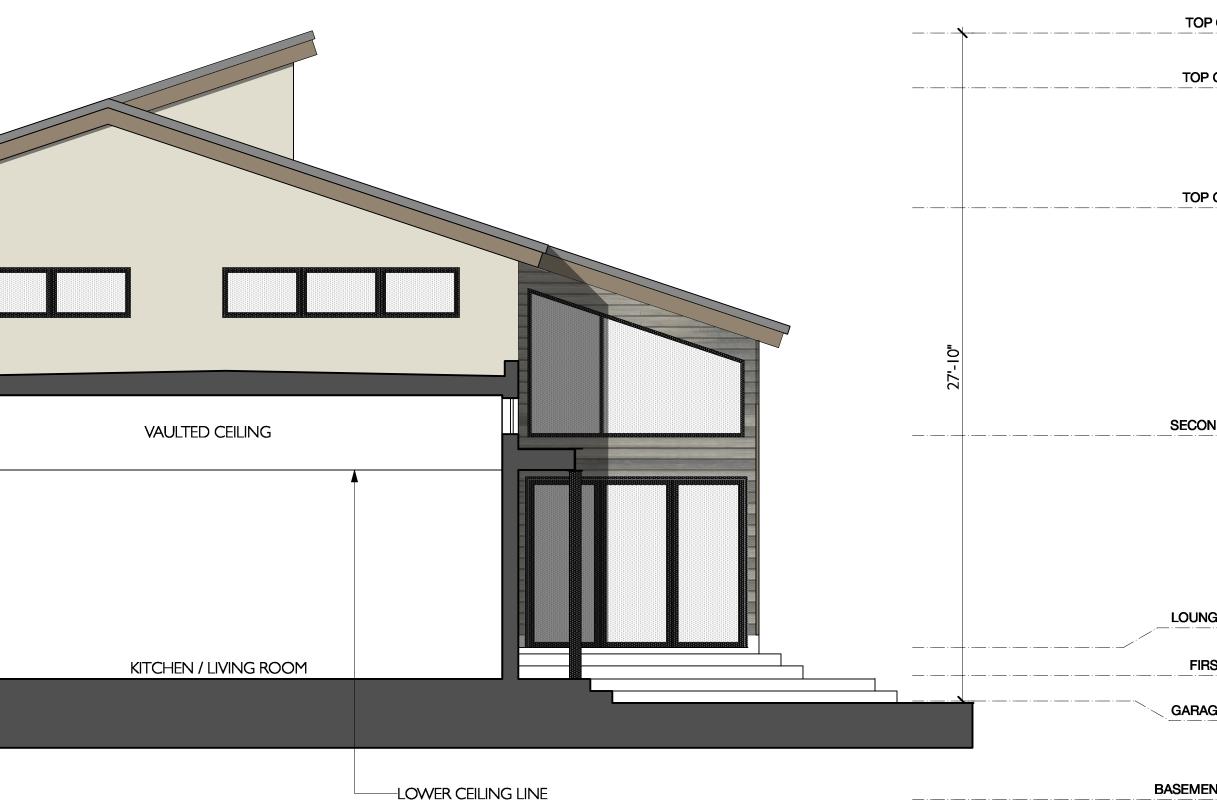

TOP OF ROOF +34.64'	BCÅ
TOP OF RIDGE +37.39'	Brian Crowley Architecture
	65 Birch Road Briarcliff Manor, NY 10510 P. 917.301.3616 www.bc-architecture.com
	www.bc-architecture.com
TOP OF RIDGE +32.39'	
SECOND FLOOR +24.23'	
LOUNGE FLOOR +14.07'	
FIRST FLOOR +12.90'	
+12.90'	
+11.73	
BASEMENT FLOOR	
0" 🔽	
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TOP OF RIDGE +32.39'	
+32.39'	REMODEL & AD HASSLER 850 Rushmore A Mamaroneck, NY
	SDEL SSI Ushm Ushm
SECOND FLOOR +24.23'	
	# date issue
	·
	04.05.23 SITE PLAN APP
LOUNGE FLOOR +14.07'	
FIRST FLOOR +12.90'	
GARAGE FLOOR +11.73'	
+11./3	Proposed Elevations
BASEMENT FLOOR 0"	22.08
	project
	drawn by: KJC
	checked by:
	date: 06.30.22
	scale: AS NOTED
	A-3.3

I BUILDING SECTION Scale: 1/4" = 1'-0"

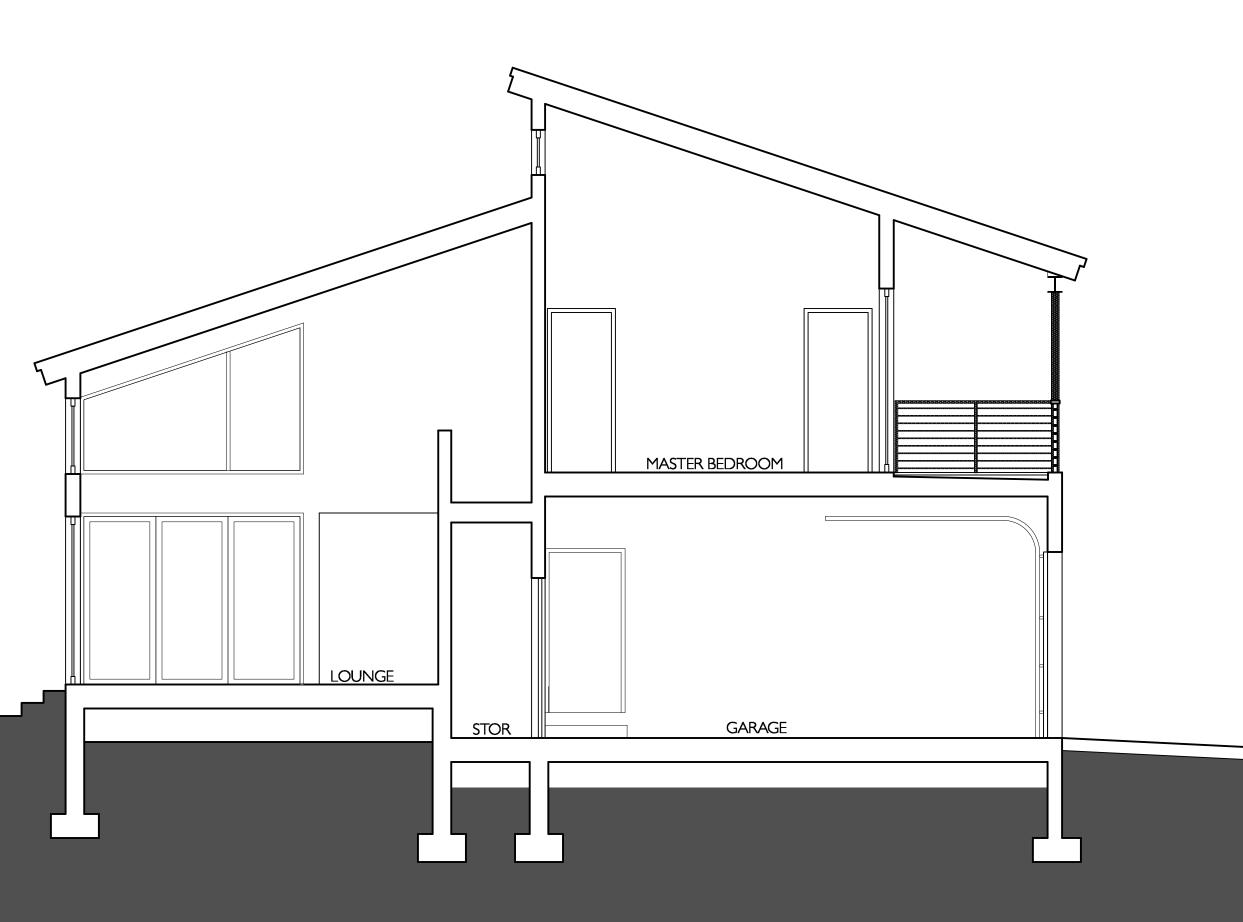



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NCE HASSLER RESIDE


850 Rushmore Ave. Mamaroneck, NY 10543


**REMODEL & ADDITION** 


#	date	issue
09	9.30.22	ARB
04	.05.23	SITE PLAN APP
Proi	posed	Elevations

## 1 Props

project:	22.08
drawn by:	KJC
checked by:	
date:	06.30.22
scale:	AS NOTED
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#### LEGEND

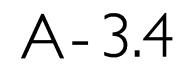= $=$ $=$	-	EXISTING WALL TO REMAIN
	-	NEW WALL
	-	EXISTING WALL TO BE DEMOLISHED
	-	EXISTING FRAMING, ie: EX FJ, EX CJ, EX RR
▶	_	NEW FRAMING, N INDICATES NUMBER OF COMMON NAILS REQUIRED AT END OF MEMBER. AT LAPS: 10d, 12d OR 16d AS REQ'D FOR FULL NAIL PENETRATION TOE NAILS: 16d
<u> </u>	-	H_, SEE HEADER SCHEDULE
■ OR <b>O</b> P_ P_	-	P_, SEE POST SCHEDULE
	-	INDICATES POST ABOVE
JH_	_	JH_, SEE JOIST HANGER SCHEDULE
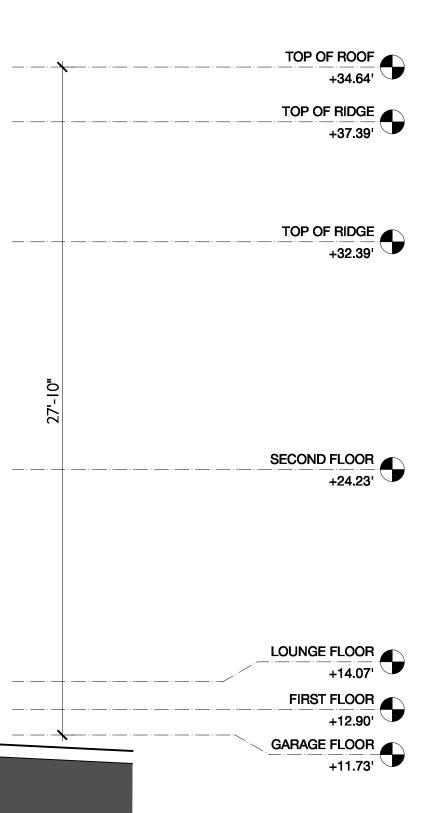
#### JOIST HANGER SCHEDULE

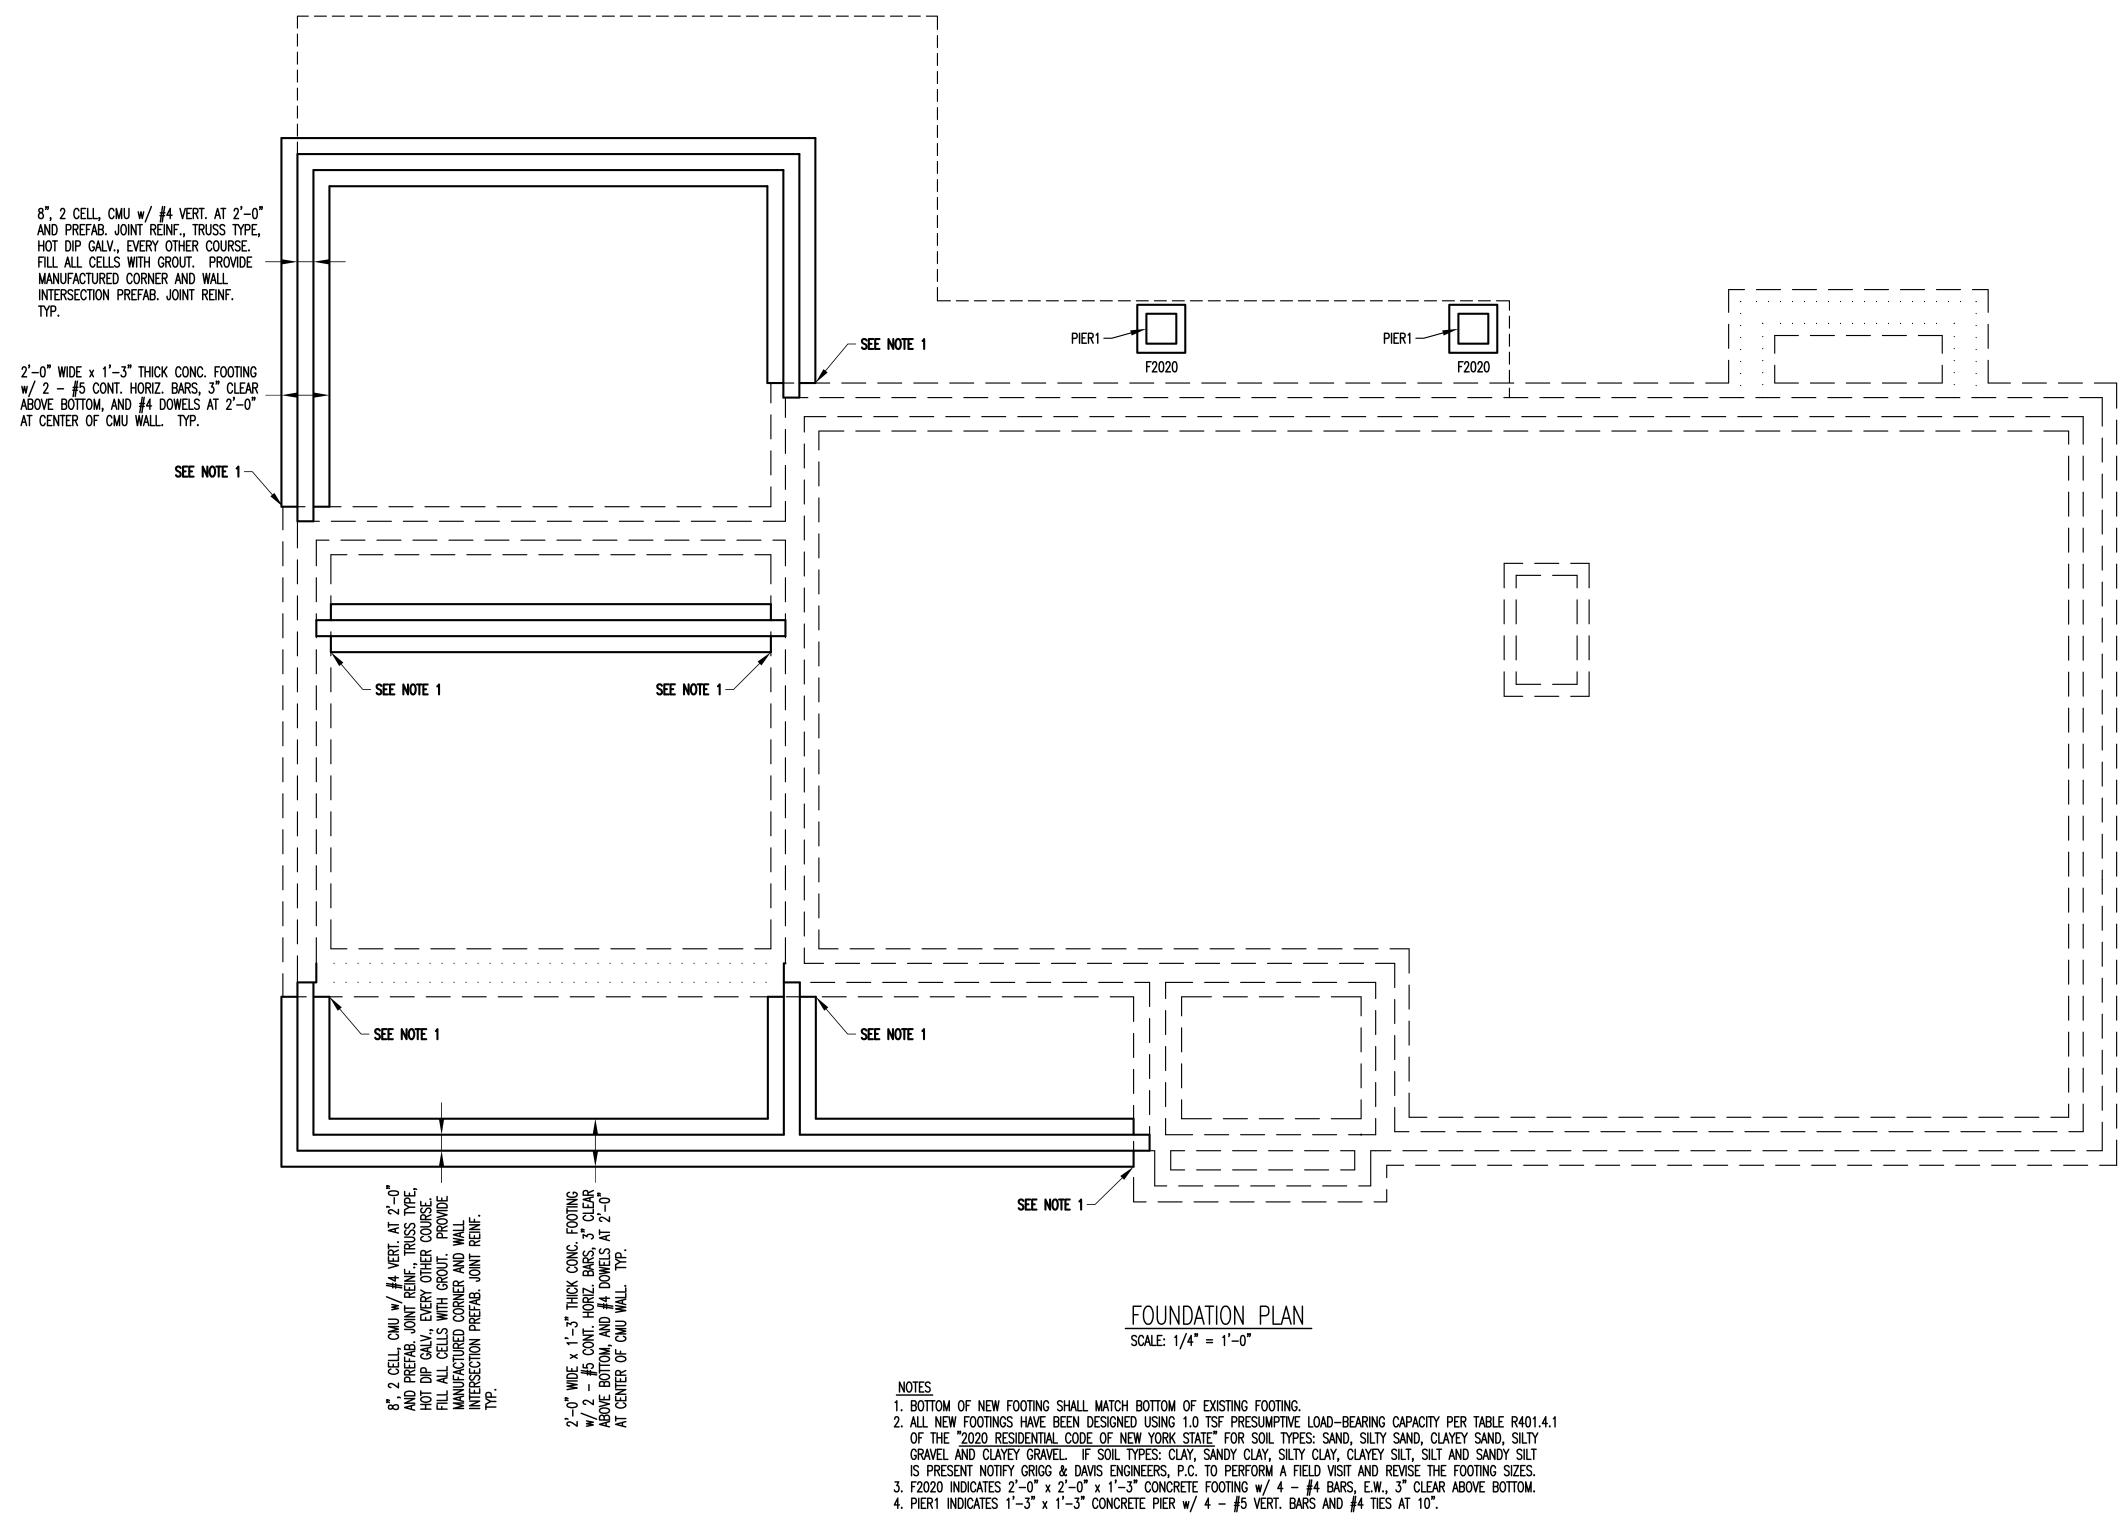ALL JOIST HANGERS SHALL BE MANUFACTURED BY SIMPSON STRONG-TIE AND SHALL BE INSTALLED WITH SIMPSON STRONG-TIE NAILS, 16d x 2 1/2" OR 10d x 1 1/2", DEPENDING ON AVAILABLE NAIL PENETRATION DEPTH, TYP. U.O.N. ALL ROUND AND TRIANGULAR HOLES SHALL HAVE THE SPECIFIED NAIL.

JH1	-	HU412 X SLD18*
JH2	-	HUC412 X SLD18*
JH3	-	HUC610
JH4	-	U210-2
JH5	-	U210
JH6	-	U26
JH7	-	HU610

\* - INDICATES SPECIAL ORDER ITEM

#### HEADER SCHEDULE

- H1 6 x 12 H2 -  $3 - 2 \times 10 + 2 - 1/2" \times 9"$  PLYWOOD H3 -  $2 - 2 \times 12 + 1/2" \times 11"$  PLYWOOD
- H4  $3 1 \frac{3}{4} \times 9 \frac{1}{4} \text{ LVL} + \frac{1}{4} \times 9 \frac{1}{4} \text{ PLYWOOD}$

#### POST SCHEDULE

FOR HEADERS THE WOOD POST INDICATED ARE THE JACK STUDS REQUIRED. PROVIDE A KING STUD IN ADDITION TO THE JACK STUDS. ALL BUILT-UP WOOD POSTS SHALL BE FASTENED TOGETHER WITH 3/8" A307 BOLTS AT EQUAL SPACING NOT GREATER THAN 2'-6".

		4 x 6 HSS5 x 5 x 1/4 w/ 1/2" x 6" x 10" CAP PL 3/4" x 6" x 10" BASE PL
P3	_	$2 - 2 \times 6$
P4		$3 - 2 \times 4$
P5	_	2 - 2 x 4
P6	-	4 x 4
P7	-	3"ø STD. PIPE w/ 1/2" x 5 1/4" x 7" CAP PL 3/4" x 4" x 9" BASE PL
P8	-	3"ø STD. PIPE w/ 1/2" x 8" x 7" CAP PL 3/4" x 4" x 9" BASE PL
P9	-	3"ø STD. PIPE w/ 1/2" x 5 3/4" x 7" CAP PL 3/4" x 4" x 9" BASE PL
P10	-	$4 - 2 \times 6$

NOTE: INSTALL SOLID BLOCKING BELOW POST SO THAT ENTIRE POST AREA IS IN DIRECT BEARING OVER WALL DOUBLE TOP PLATE, OR FOUNDATION SILL PLATE, BELOW. FOR EXISTING CONSTRUCTION USE 1.55E TIMBERSTRAND LSL BLOCKING. FOR NEW CONSTRUCTION BLOCKING SHALL MATCH FLOOR FRAMING, ie: 2 x 's FOR 2 x FRAMING AND 1.55E TIMBERSTRAND LSL FOR TJI/LVL FRAMING.


# NOT FOR CONSTRUCTION SCHEMATIC DESIGN 9/22/22



#### FOUNDATION PLAN

project:	22.08
drawn by:	BED
checked by:	BED
date:	9.22.22
scale:	AS NOTED

S - 1

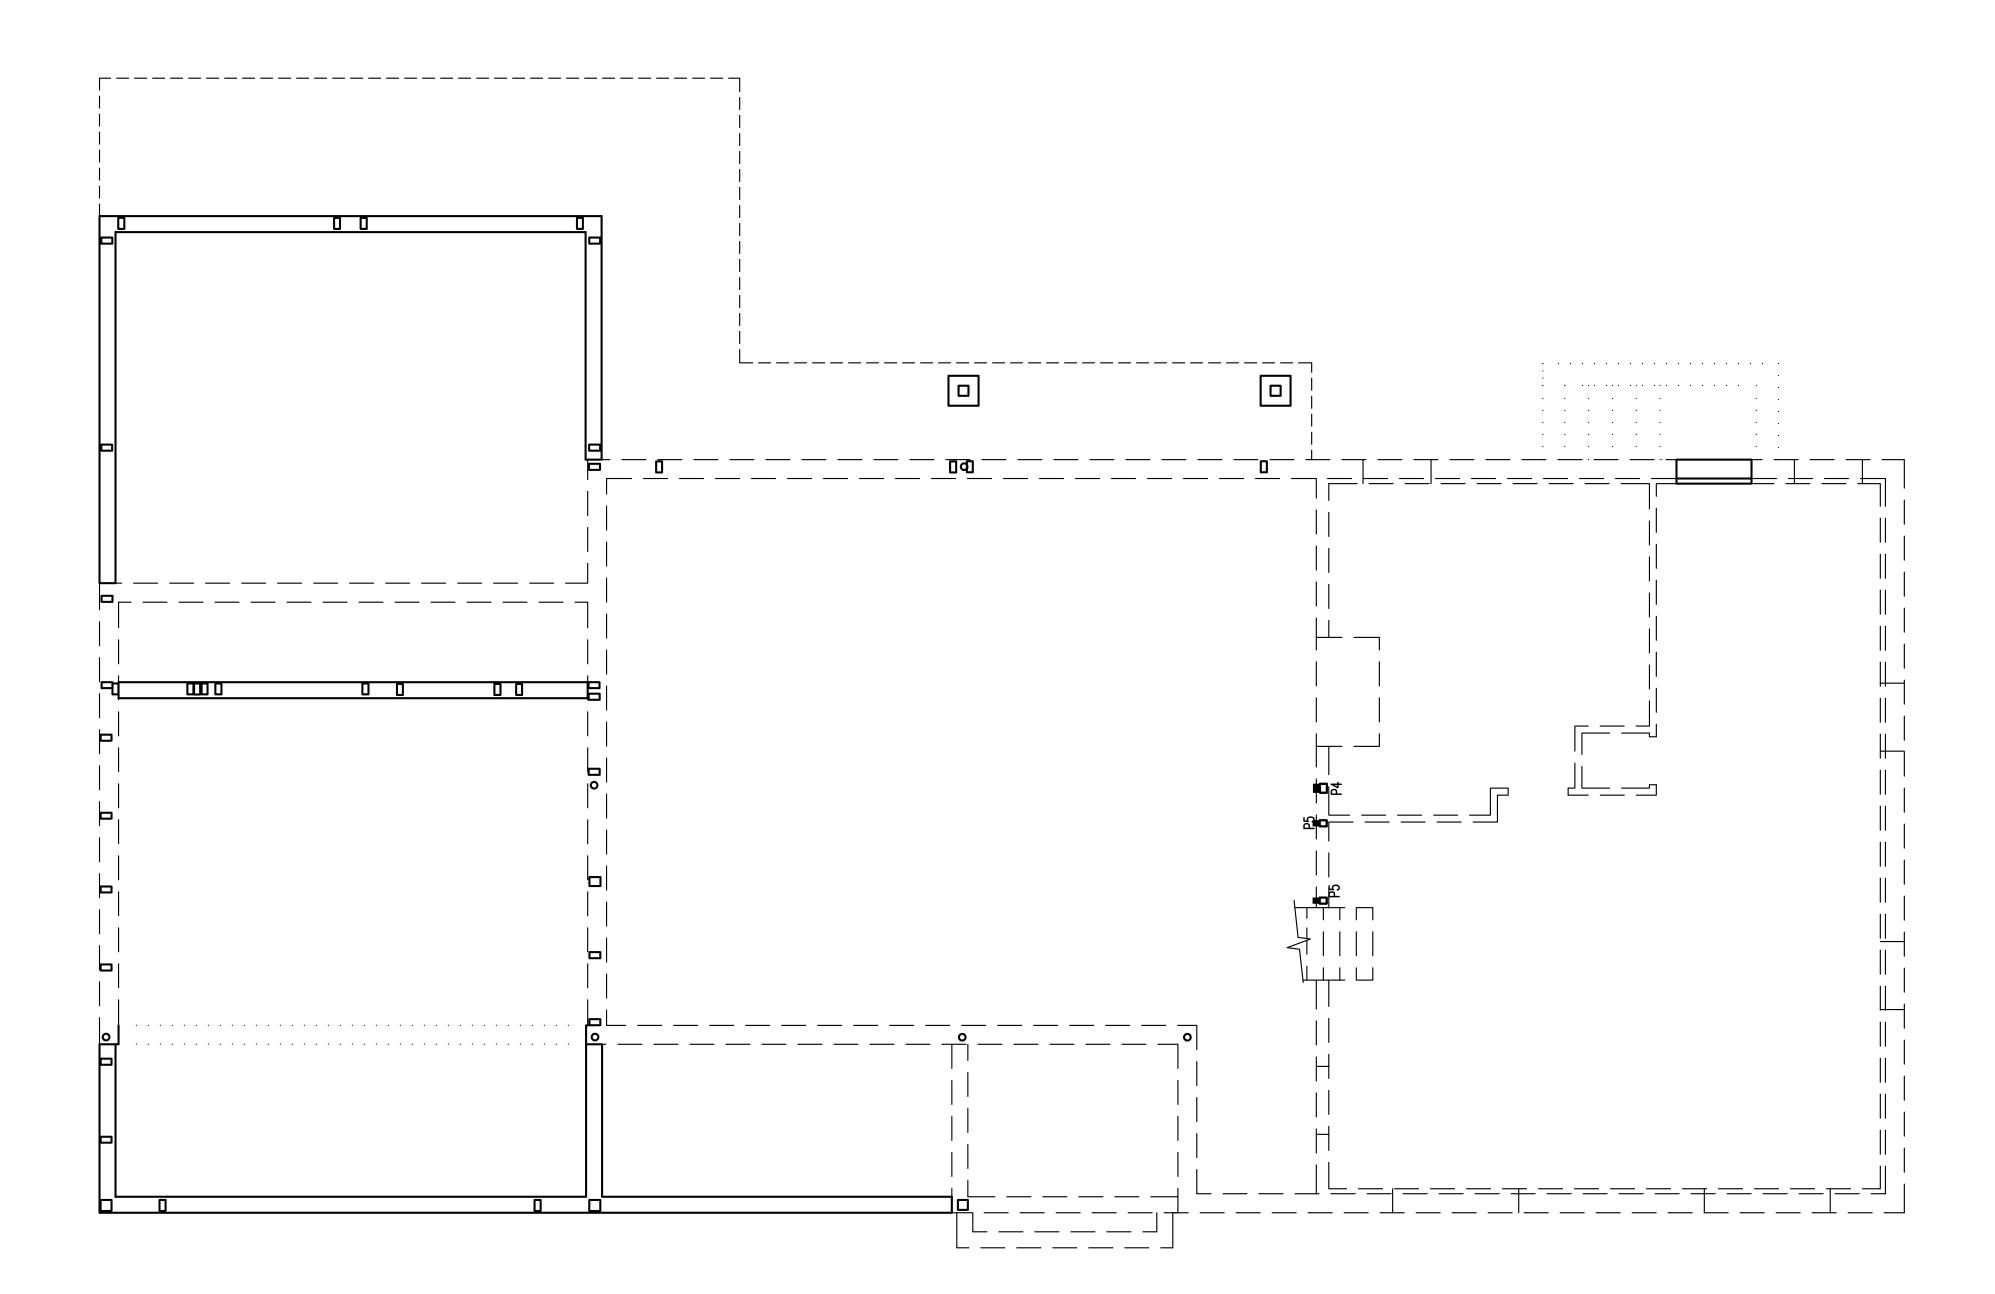





#### LEGEND

===	- EXISTING WALL TO REMAIN
	– NEW WALL
: : : : : : : : : :	- EXISTING WALL TO BE DEMOLISHED
	– EXISTING FRAMING, ie: EX FJ, EX CJ, EX RR
<u>▶</u>	<ul> <li>NEW FRAMING, N INDICATES NUMBER OF COMMON NAILS REQUIRED AT END OF MEMBER. AT LAPS: 10d, 12d OR 16d AS REQ'D FOR FULL NAIL PENETRATION TOE NAILS: 16d</li> </ul>
H	- H_, SEE HEADER SCHEDULE
■ OR <b>O</b> P_ P_	– P_, SEE POST SCHEDULE
	- INDICATES POST ABOVE
JH_	– JH_, SEE JOIST HANGER SCHEDULE

#### JOIST HANGER SCHEDULE

ALL JOIST HANGERS SHALL BE MANUFACTURED BY SIMPSON STRONG-TIE AND SHALL BE INSTALLED WITH SIMPSON STRONG-TIE NAILS, 16d x 2 1/2" OR 10d x 1 1/2", DEPENDING ON AVAILABLE NAIL PENETRATION DEPTH, TYP. U.O.N. ALL ROUND AND TRIANGULAR HOLES SHALL HAVE THE SPECIFIED NAIL.

JH1	-	HU412 X SLD18*
JH2	-	HUC412 X SLD18*
JH3	-	HUC610
JH4	-	U210-2
JH5	-	U210
JH6	-	U26
JH7	_	HU610

\* - INDICATES SPECIAL ORDER ITEM

### HEADER SCHEDULE

- H1 6 x 12 H2 -  $3 - 2 \times 10 + 2 - 1/2" \times 9"$  PLYWOOD H3 – 2 – 2 x 12 + 1/2" x 11" PLYWOOD
- H4 3 1 3/4 x 9 1/4 LVL + 1/4" x 9 1/4" PLYWOOD

#### POST SCHEDULE

FOR HEADERS THE WOOD POST INDICATED ARE THE JACK STUDS REQUIRED. PROVIDE A KING STUD IN ADDITION TO THE JACK STUDS. ALL BUILT-UP WOOD POSTS SHALL BE FASTENED TOGETHER WITH 3/8" A307 BOLTS AT EQUAL SPACING NOT GREATER THAN 2'-6".

P1 P2	- -	, , ,
P3	_	3/4" x 6" x 10" BASE PL 2 - 2 x 6
P4	-	$3 - 2 \times 4$
P5	-	2 - 2 x 4
P6	-	4 x 4
P7	-	3"ø STD. PIPE w/ 1/2" x 5 1/4" x 7" CAP PL 3/4" x 4" x 9" BASE PL
P8	-	3"ø STD. PIPE w/ 1/2" x 8" x 7" CAP PL 3/4" x 4" x 9" BASE PL
P9	-	3"ø STD. PIPE w/ 1/2" x 5 3/4" x 7" CAP PL 3/4" x 4" x 9" BASE PL
P10	-	$4 - 2 \times 6$


NOTE: INSTALL SOLID BLOCKING BELOW POST SO THAT ENTIRE POST AREA IS IN DIRECT BEARING OVER WALL DOUBLE TOP PLATE, OR FOUNDATION SILL PLATE, BELOW. FOR EXISTING CONSTRUCTION USE 1.55E TIMBERSTRAND LSL BLOCKING. FOR NEW CONSTRUCTION BLOCKING SHALL MATCH FLOOR FRAMING, ie: 2 x 's FOR 2 x FRAMING AND 1.55E TIMBERSTRAND LSL FOR TJI/LVL FRAMING.

# NOT FOR CONSTRUCTION SCHEMATIC DESIGN 9/22/22 S-2

65 Birch Briarcliff I P. 917.30 www.bc-a GRIGG & D/ 21	Manor, NY 10510
REMODEL & ADDITION	HASSLER RESIDENCE 850 Rushmore Ave. Mamaroneck, NY 10543
# date	issue
9.30.22	ARB
04.05.23	SITE PLAN APP

#### FIRST FLOOR FRAMING PLAN

project:	22.08
drawn by:	BED
checked by:	BED
date:	9.22.22
scale:	AS NOTED

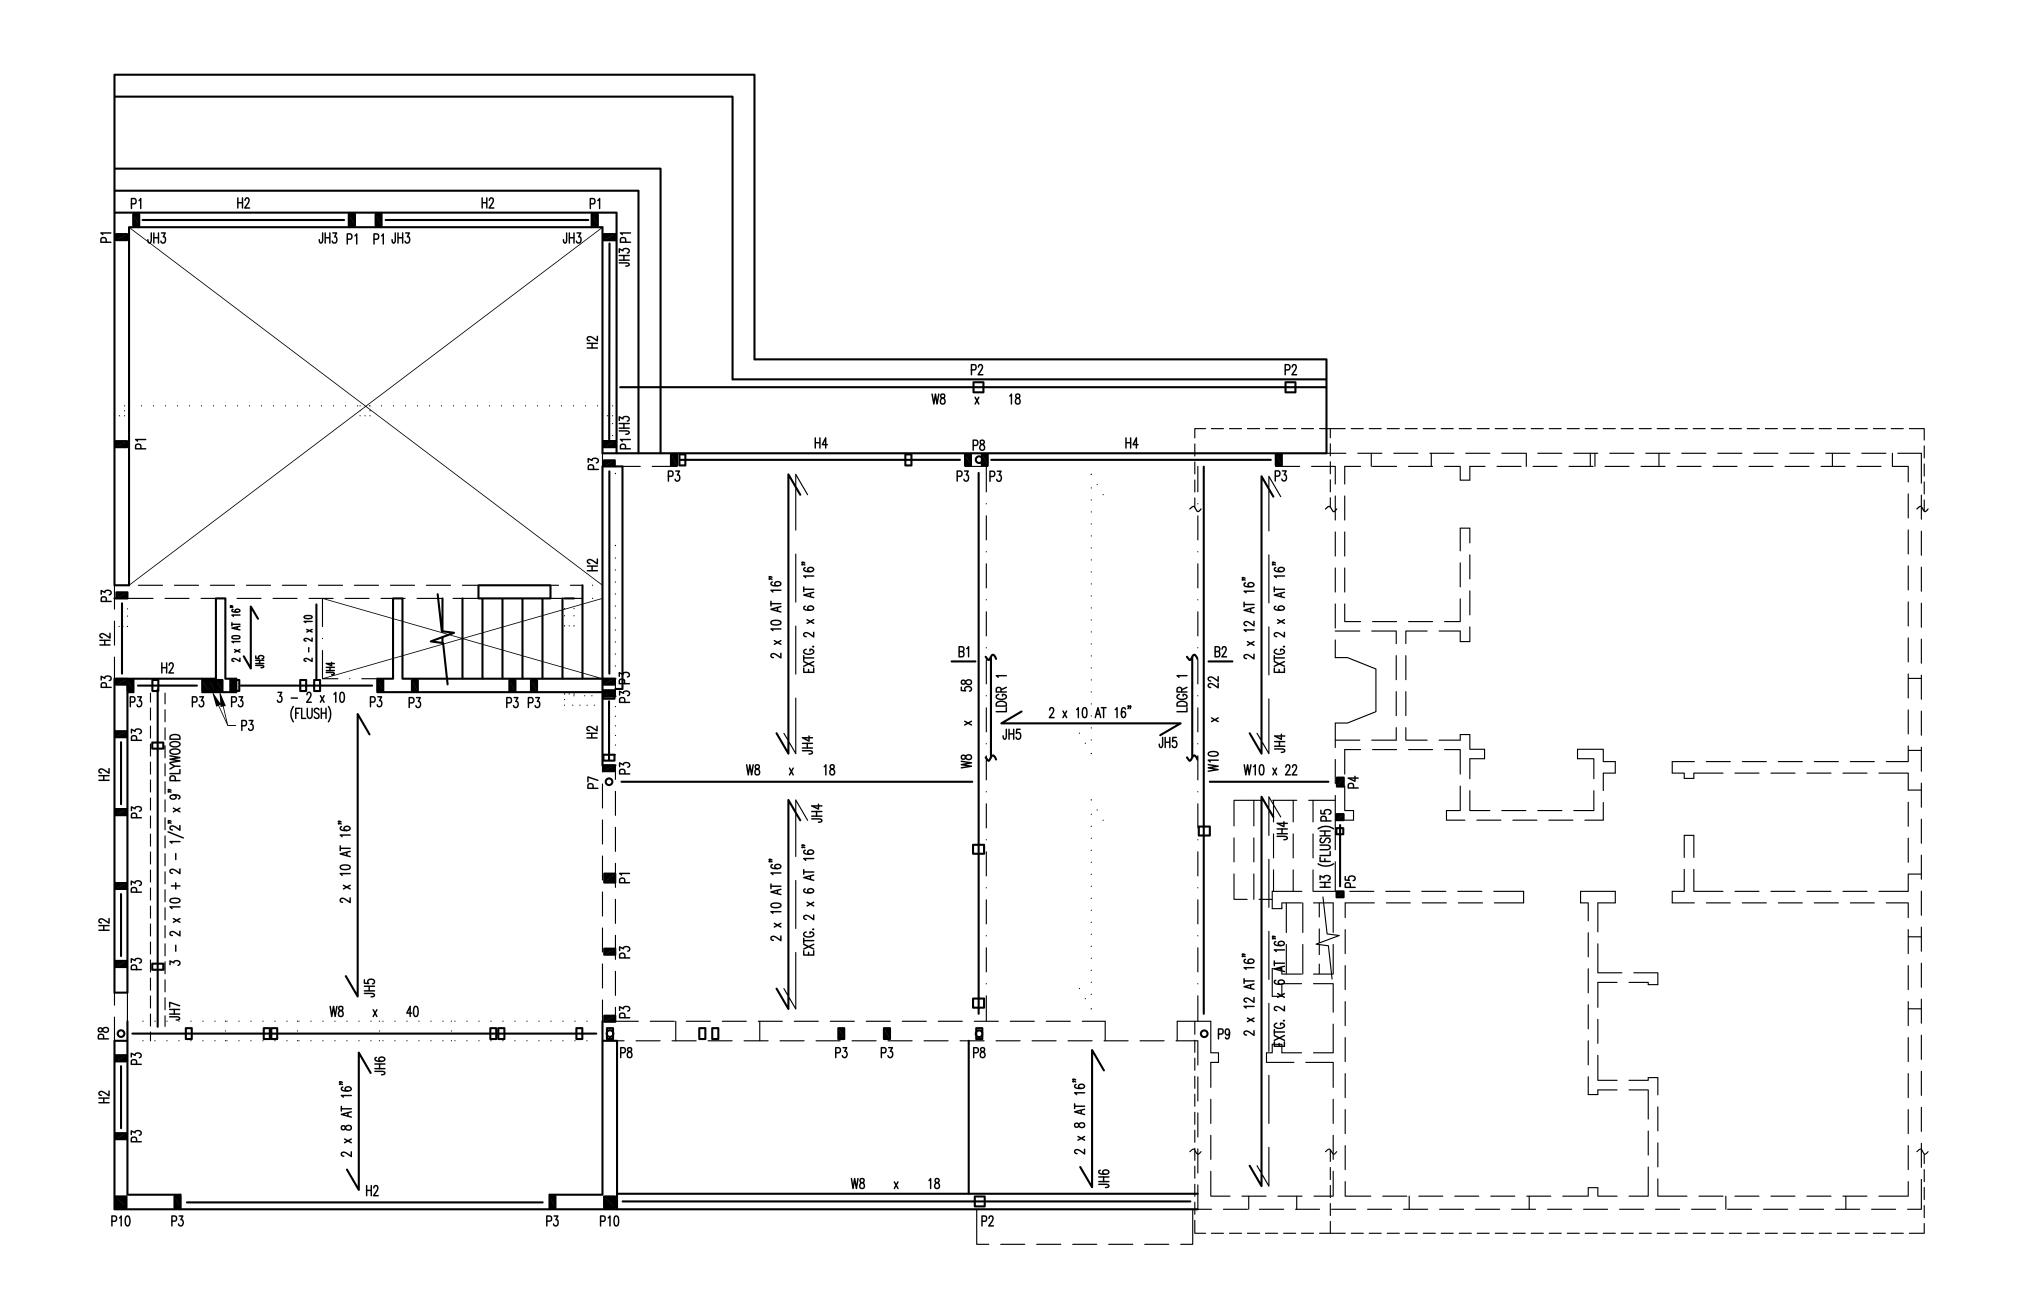

SECOND FLOOR FRAMING PLAN SCALE: 1/4'' = 1'-0''



### LEGEND

===	-	EXISTING WALL TO REMAIN
	-	NEW WALL
	-	EXISTING WALL TO BE DEMOLISHED
	-	EXISTING FRAMING, ie: EX FJ, EX CJ, EX RR
▶	-	NEW FRAMING, N INDICATES NUMBER OF COMMON NAILS REQUIRED AT END OF MEMBER. AT LAPS: 10d, 12d OR 16d AS REQ'D FOR FULL NAIL PENETRATION TOE NAILS: 16d
<u> </u>	-	H_, SEE HEADER SCHEDULE
■ OR <b>O</b> P_ P_	-	P_, SEE POST SCHEDULE
	-	INDICATES POST ABOVE
JH_	-	JH_, SEE JOIST HANGER SCHEDULE

### JOIST HANGER SCHEDULE

ALL JOIST HANGERS SHALL BE MANUFACTURED BY SIMPSON STRONG-TIE AND SHALL BE INSTALLED WITH SIMPSON STRONG-TIE NAILS, 16d x 2 1/2" OR 10d x 1 1/2", DEPENDING ON AVAILABLE NAIL PENETRATION DEPTH, TYP. U.O.N. ALL ROUND AND TRIANGULAR HOLES SHALL HAVE THE SPECIFIED NAIL.

JH1	-	HU412 X SLD18*
JH2	-	HUC412 X SLD18*
JH3	-	HUC610
JH4	-	U210-2
JH5	-	U210
JH6	-	U26
JH7	-	HU610

\* - INDICATES SPECIAL ORDER ITEM

#### HEADER SCHEDULE

- H1 6 x 12 H2 -  $3 - 2 \times 10 + 2 - 1/2" \times 9"$  PLYWOOD H3 - 2 - 2 x 12 +  $1/2^{\circ}$  x 11" PLYWOOD
- H4 3 1 3/4 x 9 1/4 LVL + 1/4" x 9 1/4" PLYWOOD

#### POST SCHEDULE

FOR HEADERS THE WOOD POST INDICATED ARE THE JACK STUDS REQUIRED. PROVIDE A KING STUD IN ADDITION TO THE JACK STUDS. ALL BUILT-UP WOOD POSTS SHALL BE FASTENED TOGETHER WITH 3/8" A307 BOLTS AT EQUAL SPACING NOT GREATER THAN 2'-6".

		4 x 6
P2	-	HSS5 x 5 x 1/4 w/ 1/2" x 6" x 10" CAP PL 3/4" x 6" x 10" BASE PL
Р3	-	$2 - 2 \times 6$
P4	-	$3 - 2 \times 4$
P5	-	2 – 2 x 4
P6	-	4 x 4
P7	-	3"ø STD. PIPE w/ 1/2" x 5 1/4" x 7" CAP PL 3/4" x 4" x 9" BASE PL
P8	-	3"ø STD. PIPE w/ 1/2" x 8" x 7" CAP PL 3/4" x 4" x 9" BASE PL
P9	-	3"ø STD. PIPE w/ 1/2" x 5 3/4" x 7" CAP PL 3/4" x 4" x 9" BASE PL
P10	-	$4 - 2 \times 6$


NOTE: INSTALL SOLID BLOCKING BELOW POST SO THAT ENTIRE POST AREA IS IN DIRECT BEARING OVER WALL DOUBLE TOP PLATE, OR FOUNDATION SILL PLATE, BELOW. FOR EXISTING CONSTRUCTION USE 1.55E TIMBERSTRAND LSL BLOCKING. FOR NEW CONSTRUCTION BLOCKING SHALL MATCH FLOOR FRAMING, ie: 2 x 's FOR 2 x FRAMING AND 1.55E TIMBERSTRAND LSL FOR TJI/LVL FRAMING.

# NOT FOR CONSTRUCTION SCHEMATIC DESIGN 9/22/22



#### SECOND FLOOR FRAMING PLAN

project:	22.08
drawn by:	BED
checked by:	BED
date:	9.22.22
scale:	AS NOTED
S - 3	

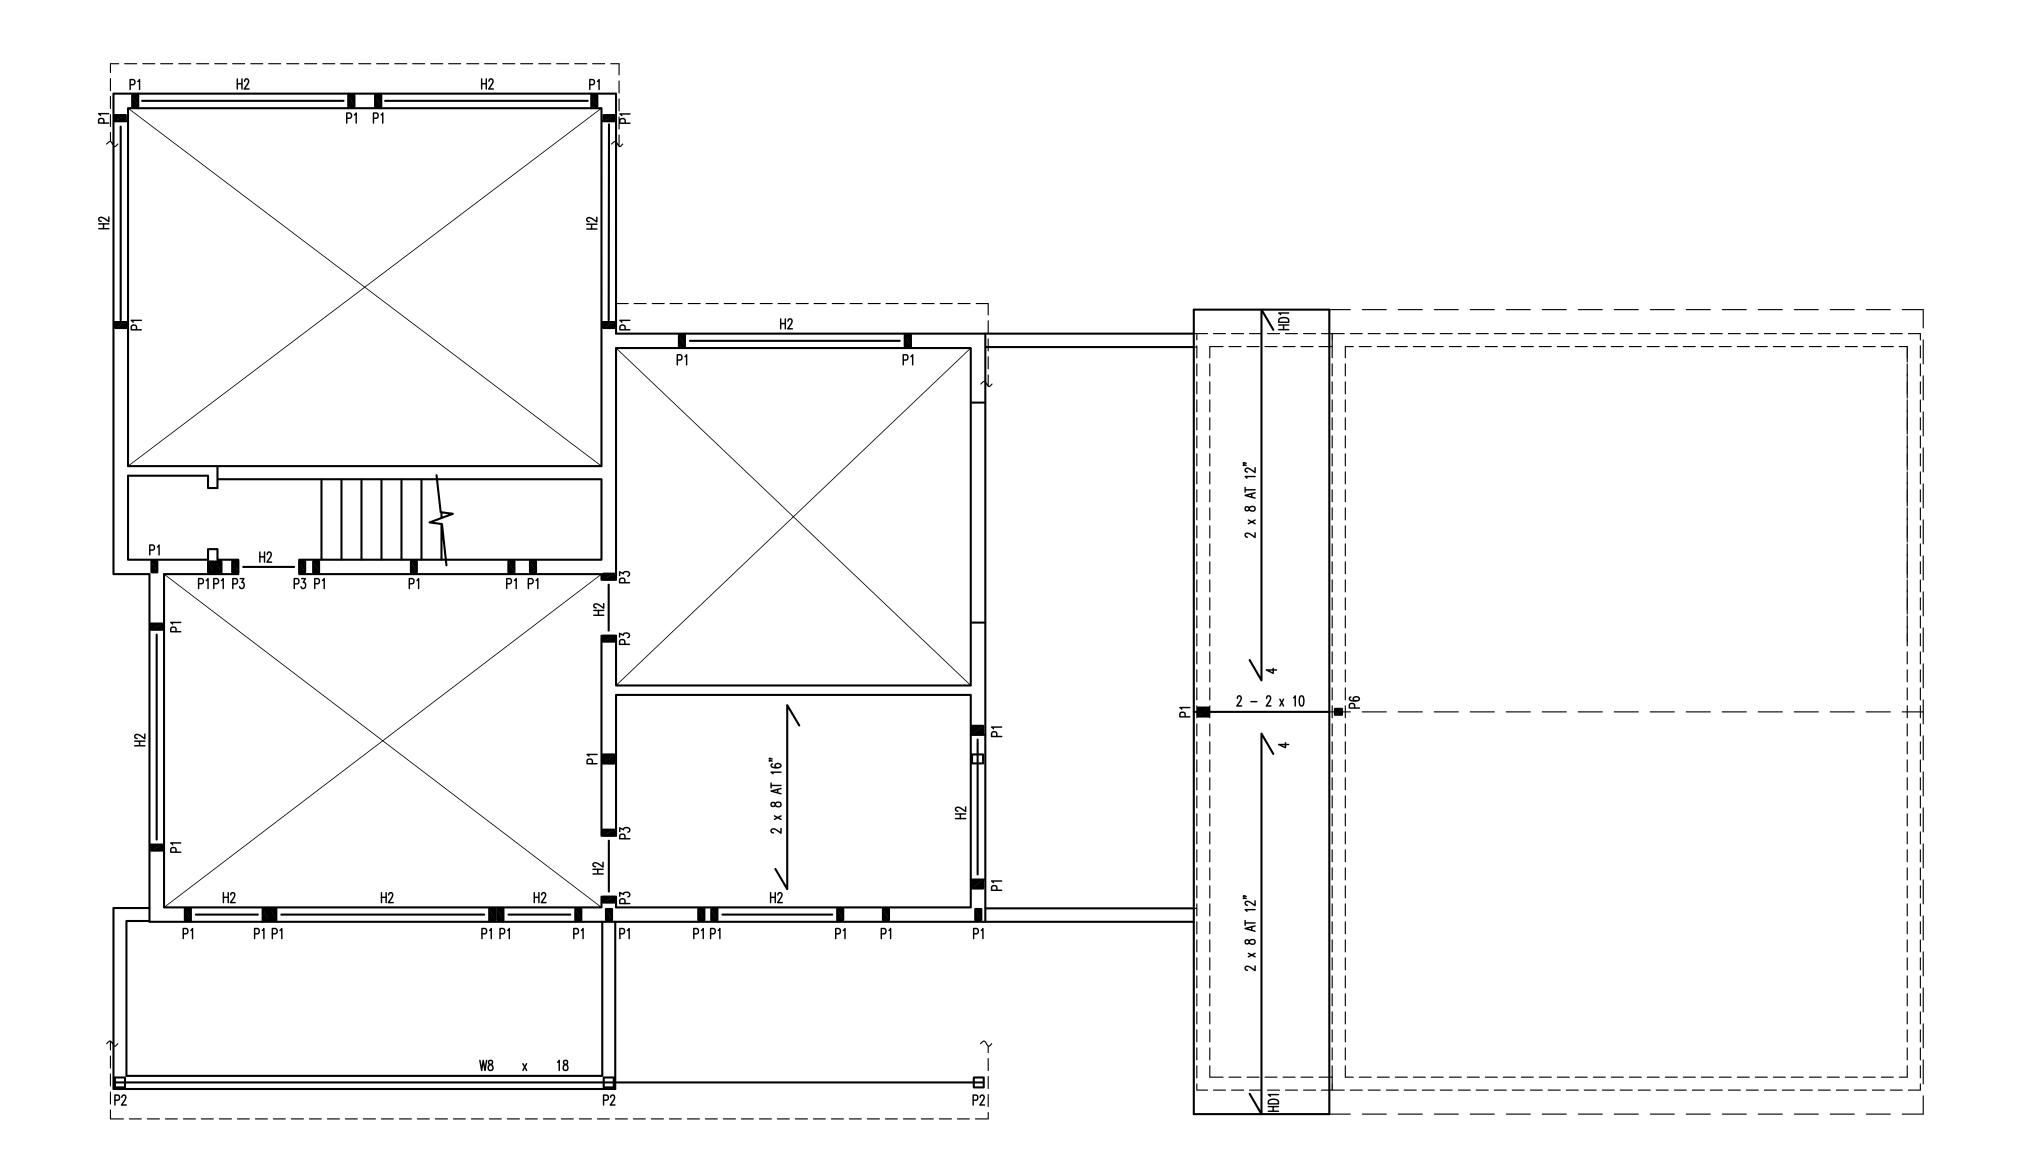

ATTIC FRAMING PLAN SCALE: 1/4" = 1'-0"



### LEGEND

===	-	EXISTING WALL TO REMAIN
	-	NEW WALL
	-	EXISTING WALL TO BE DEMOLISHED
	-	EXISTING FRAMING, ie: EX FJ, EX CJ, EX RR
▶	_	NEW FRAMING, N INDICATES NUMBER OF COMMON NAILS REQUIRED AT END OF MEMBER. AT LAPS: 10d, 12d OR 16d AS REQ'D FOR FULL NAIL PENETRATION TOE NAILS: 16d
H	-	H_, SEE HEADER SCHEDULE
■ OR <b>O</b> P_ P_	-	P_, SEE POST SCHEDULE
	-	INDICATES POST ABOVE
JH_	_	JH_, SEE JOIST HANGER SCHEDULE

### JOIST HANGER SCHEDULE

ALL JOIST HANGERS SHALL BE MANUFACTURED BY SIMPSON STRONG-TIE AND SHALL BE INSTALLED WITH SIMPSON STRONG-TIE NAILS, 16d  $\times$  2 1/2" OR 10d x 1 1/2", DEPENDING ON AVAILABLE NAIL PENETRATION DEPTH, TYP. U.O.N. ALL ROUND AND TRIANGULAR HOLES SHALL HAVE THE SPECIFIED NAIL.

JH1	-	HU412 X SLD18*
JH2	-	HUC412 X SLD18*
JH3	-	HUC610
JH4	-	U210-2
JH5	-	U210
JH6	-	U26
JH7	-	HU610

\* - INDICATES SPECIAL ORDER ITEM

#### HEADER SCHEDULE

- H1 6 x 12 H2 -  $3 - 2 \times 10 + 2 - 1/2" \times 9"$  PLYWOOD  $H3 - 2 - 2 \times 12 + 1/2" \times 11" PLYWOOD$
- H4 3 1  $3/4 \times 9 1/4$  LVL +  $1/4^{"} \times 9 1/4^{"}$  PLYWOOD

#### POST SCHEDULE

FOR HEADERS THE WOOD POST INDICATED ARE THE JACK STUDS REQUIRED. PROVIDE A KING STUD IN ADDITION TO THE JACK STUDS. ALL BUILT-UP WOOD POSTS SHALL BE FASTENED TOGETHER WITH 3/8" A307 BOLTS AT EQUAL SPACING NOT GREATER THAN 2'-6".


		4 x 6 HSS5 x 5 x 1/4 w/ 1/2" x 6" x 10" CAP PL
		3/4" x 6" x 10" BASE PL
P3	-	$2 - 2 \times 6$
P4	-	$3 - 2 \times 4$
P5	-	$2 - 2 \times 4$
P6	-	4 x 4
P7	-	3"ø STD. PIPE w/ 1/2" x 5 1/4" x 7" CAP PL 3/4" x 4" x 9" BASE PL
P8	-	3"ø STD. PIPE w/ 1/2" x 8" x 7" CAP PL 3/4" x 4" x 9" BASE PL
P9	-	3"ø STD. PIPE w/ 1/2" x 5 3/4" x 7" CAP PL 3/4" x 4" x 9" BASE PL
P10	-	$4 - 2 \times 6$

NOTE: INSTALL SOLID BLOCKING BELOW POST SO THAT ENTIRE POST AREA IS IN DIRECT BEARING OVER WALL DOUBLE TOP PLATE, OR FOUNDATION SILL PLATE, BELOW. FOR EXISTING CONSTRUCTION USE 1.55E TIMBERSTRAND LSL BLOCKING. FOR NEW CONSTRUCTION BLOCKING SHALL MATCH FLOOR FRAMING, ie: 2 x 's FOR 2 x FRAMING AND 1.55E TIMBERSTRAND LSL FOR TJI/LVL FRAMING.



#### ATTIC FRAMING PLAN

project:	22.08
drawn by:	BED
checked by:	BED
date:	9.22.22
scale:	AS NOTED

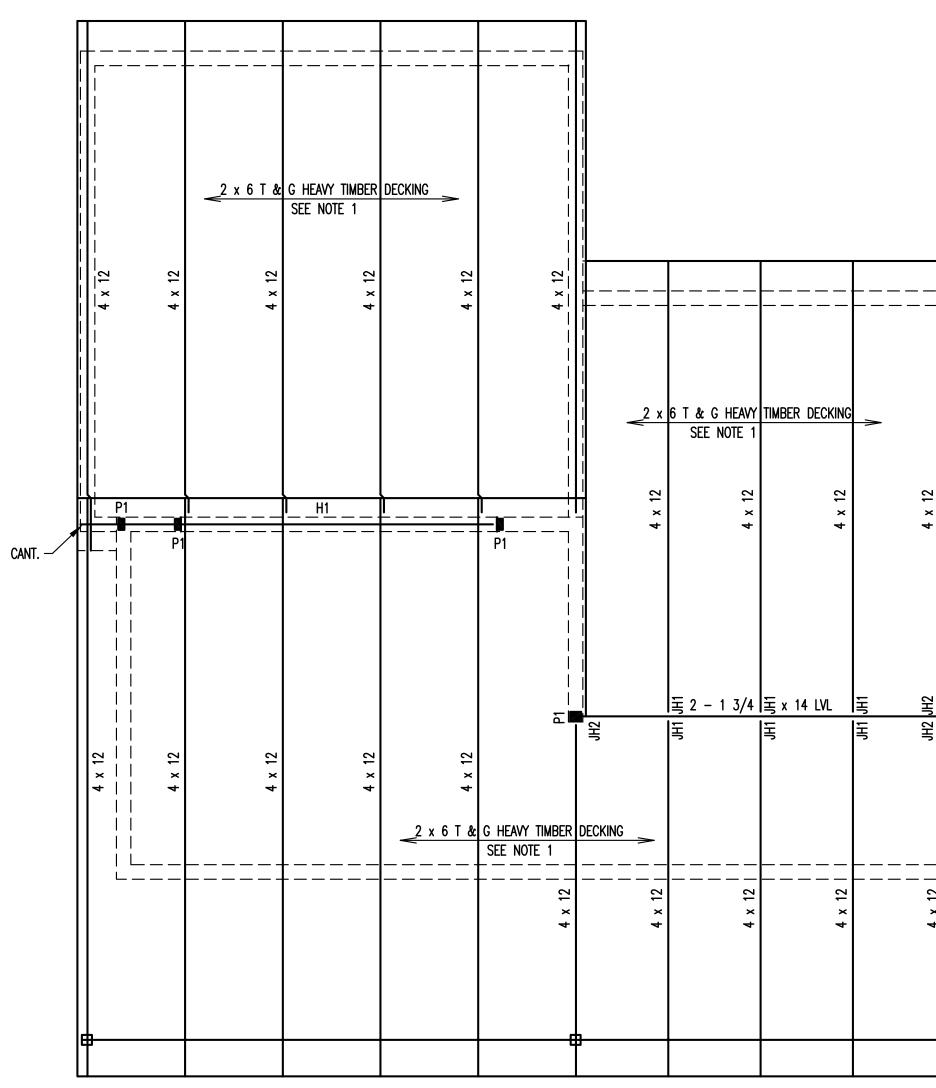

## ROOF FRAMING PLAN scale: 1/4" = 1'-0"

<u>NOTES</u> 1. 2 x 6 T & G HEAVY TMBER DECKING SHALL BE WOOD SPECIES: SPRUCE-PINE-FIR, COMMERCIAL QUALITY, OR BETTER, AND SHALL BE INSTALLED IT THE "COMBINATION SIMPLE AND TWO-SPAN CONTINUOUS LAYUP" ARRANGEMENT.





#### LEGEND

===	-	EXISTING WALL TO REMAIN
	-	NEW WALL
	-	EXISTING WALL TO BE DEMOLISHED
	-	EXISTING FRAMING, ie: EX FJ, EX CJ, EX RR
▶	_	NEW FRAMING, N INDICATES NUMBER OF COMMON NAILS REQUIRED AT END OF MEMBER. AT LAPS: 10d, 12d OR 16d AS REQ'D FOR FULL NAIL PENETRATION TOE NAILS: 16d
H	-	H_, SEE HEADER SCHEDULE
■ OR <b>O</b> P_ P_	-	P_, SEE POST SCHEDULE
	-	INDICATES POST ABOVE
JH_	_	JH_, SEE JOIST HANGER SCHEDULE

### JOIST HANGER SCHEDULE

ALL JOIST HANGERS SHALL BE MANUFACTURED BY SIMPSON STRONG-TIE AND SHALL BE INSTALLED WITH SIMPSON STRONG-TIE NAILS, 16d  $\times$  2 1/2" OR  $10d \times 1 1/2$ ", DEPENDING ON AVAILABLE NAIL PENETRATION DEPTH, TYP. U.O.N. ALL ROUND AND TRIANGULAR HOLES SHALL HAVE THE SPECIFIED NAIL.

JH1	-	HU412 X SLD18*
JH2	-	HUC412 X SLD18*
JH3	-	HUC610
JH4	-	U210-2
JH5	-	U210
JH6	-	U26
JH7	-	HU610

\* - INDICATES SPECIAL ORDER ITEM

#### HEADER SCHEDULE

- H1 6 x 12 H2 -  $3 - 2 \times 10 + 2 - 1/2" \times 9"$  PLYWOOD  $H3 - 2 - 2 \times 12 + 1/2" \times 11" PLYWOOD$
- H4 3 1 3/4 x 9 1/4 LVL + 1/4" x 9 1/4" PLYWOOD

#### POST SCHEDULE

FOR HEADERS THE WOOD POST INDICATED ARE THE JACK STUDS REQUIRED. PROVIDE A KING STUD IN ADDITION TO THE JACK STUDS. ALL BUILT-UP WOOD POSTS SHALL BE FASTENED TOGETHER WITH 3/8"\$ A307 BOLTS AT EQUAL SPACING NOT GREATER THAN 2'-6".

Р1 Р2		4 x 6 HSS5 x 5 x 1/4 w/ 1/2" x 6" x 10" CAP PL 3/4" x 6" x 10" BASE PL
P3	_	$2 - 2 \times 6$
		3 – 2 x 4
P5	-	2 – 2 x 4
P6	-	4 x 4
P7	-	3"ø STD. PIPE w/ 1/2" x 5 1/4" x 7" CAP PL 3/4" x 4" x 9" BASE PL
P8	-	3"ø STD. PIPE w/ 1/2" x 8" x 7" CAP PL 3/4" x 4" x 9" BASE PL
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# NOT FOR CONSTRUCTION SCHEMATIC DESIGN 9/22/22 S-5



#### ROOF FRAMING PLAN

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