

- 2. Contractor (s) shall obtain any and all permits as required by the local authorities.
- 3. All work shall be designed and must be performed in compliance with the 2020 Residential Code of New York State, and all applicable local Codes and Zoning regulations. 4. The general contractor shall coordinate the work of all trades
- and sub-contractor (s) unless otherwise noted. 5. All contractors to cooperate in coordinating construction.

that the final patch is not visible after finish (es).

- 6. All cutting and patching shall be done by the general contractor and shall be the responsibility of the G.C. to see
- 7. The contractor shall protect and not damage trees, planting or shrubs where work or operation for work is required at
- 8. The storage of materials and equipment shall be located where directed by the architect or owner.
- 9. Where partition(s) are removed, flooring(s) at old partition(s) shall be filled-in level with existing to receive final finish(es). At walls and ceilings patch and align finish surfaces to match existing or as required to receive new finishes.
- 10. Install R-21 insulation in new perimeter walls and R-38 in between new roof framing.
- 11. New windows to be Andersen double hung with insulating glass white — sizes as noted on drawings. Provide insect screens for all operating sashes.
- 12. All glass within 18" of the floor shall be tempered safety
- 13. Provide  $4" \times 4"$  post or  $2 2" \times 4"$  spiked at bearing points of all double framing members and LVL's unless otherwise
- 14. All operable windows and exterior doors to be weatherstripped and all windows shall be caulked.
- 15. The contractor, by submitting his bid, represents that he has visited the project location and agrees with plans and details as representing the full extent of construction. If contractor has found that plans and details are at variance with what is physically in the field, he shall notify the architect or owner before submitting his bid.
- 16. Contractor to carry appropriate insurance, workmens compensation and liability in the sums prescribed by authorities having jurisdiction over the project.

#### STRUCTURAL SPECIFICATIONS:

#### GENERAL NOTES:

- 1. The contractor shall be responsible for visiting the site and familiarizing himself with existing conditions.
- 2. The contractor shall be solely responsible for all safe working conditions and shall observe all safety requirements established by jurisdictional agencies and owner. Where conflicts exist, the more stringent requirements shall apply. Care shall be exercised to avoid endangering personnel or the structure.
- 3. All structural work shall conform to the requirements of the Uniform Building Code of New York State, latest edition.
- 4. All structural drawings shall be used in conjunction with specifications, architectural and mechanical drawings.
- 5. All dimensions shall be verified by the contractor. The general contractor shall coordinate and be responsible for the approved size and location of all openings through roof, floors and walls.
- 6. All sections and details shall be considered typical and apply for the same and similar conditions, unless otherwise specifically noted.
- 7. Contractor shall furnish and be solely responsible for all temporary bracing required to maintain stability of the structure during oonstruction.

## FOUNDATION:

- 1. All footings shall rest on undisturbed soil of minimum bearing capacity of 2.0 tons per square foot.
- 2. Backfill with approved material. Backfilling under the slab, around piers and on each side of foundation walls shall be done in layers, not to exceed 10": compaction shall be 95 percent of maximum density at optimum moisture content, when tested in accordance with ASTM D 1557.
- 3. Excavation shall be protected from frost in cold weather. All frozen soil shall be removed before footings are poured. Footings shall be protected from freezing of underlying soil before final backfill.

## CONCRETE:


- 1. All concrete construction shall conform to building code requirements for reinforced concrete, ACI 318 (latest edition), and shall be in accordance with the manual of standard practice for detailing of reinforced concrete.
- 2. All cast—in—place concrete shall be controlled stone concrete having a minimum compressive design strength, Fc of 3,000 Ibs. per square inch at 28 days, with minimum cement factor 5.75 bags per cubic yard of concrete. Contractor shall supply concrete having a 28 day strength 25 percent greater than the design strength specified.
- 3. Accelguard—80, non—chloride accelerating admixtures as manufactured by the Euclid Chemical Company, or approved equal, shall be used in all concrete slabs placed at temperatures below 50 degrees F. Admixture shall conform with ASTM C-494 requirements, and contain no more chloride ions than are present in municipal drinking water.
- 4. Air entraining admixture conforming to ASTM C260, such as liquid air—mix as manufactured by the Euclid Chemical Co., or approved equal, shall be used in all concrete.
- 5. Horizontal placement stops interrupting the vertical thickness of concrete being placed are not permitted.
- 6. All slabs on earth shall be reinforced with welded wire mesh as called for on drawings, placed 2" from top and over any pipes or conduits in slab.
- 7. All reinforcing bars shall be new billet steel, deformed type, (ASTM A-615 GRADE 40) and shall comply with ACl code requirements.
- 8. All welded wire mesh (WWM) shall conform to the requirements of ASTM A-185.

### WOVEN WIRE FENCE (MIN. 14 GAUGE " W/ MAX. 6" MESH 10' MAX. C. TO C. SPACING) 36" MIN. LENGTH FENCE POSTS DRIVEN MIN. 16" INTO GROUND. HEIGHT OF FILTER PERSPECTIVE VIEW 36" MIN. FENCE POST ---VOVEN VIRE FENCE (MIN. 14 -GAUGE W/ MAX. 6" MESH SPACING) WITH FILTER CLOTH FLOV \_\_\_\_ UNDISTURBED GROUND COMPACTED SOIL -16"MIN. EMBED FILTER CLOTH A MIN. OF 6' IN GROUND. SECTION VIEW

SILT FENCE DETAIL - N.T.S.

## CONSTRUCTION SPECIFICATIONS


- 1. WOVEN WIRE FENCE TO BE FASTENED SECURELY TO FENCE POSTS WITH WIRE TIES OR STAPLES. POSTS SHALL BE STEEL EITHER 'T' OR 'U' TYPE OR HARDWOOD.
- 2. FILTER CLOTH TO BE FASTENED SECURELY TO WOVEN WIRE FENCE WITH TIES SPACED EVERY 24" AT TOP AND MID SECTION, FENCE SHALL BE VOVEN WIRE, 6" MAXIMUM MESH OPENING.
- 3. WHEN TWO SECTIONS OF FILTER CLOTH ADJOIN EACH OTHER THEY SHALL BE OVER-LAPPED BY SIX INCHES AND FOLDED. FILTER CLOTH SHALL BE EITHER FILTER X, MIRAFI 100X, STABILINKA T140N, OR APPROVED EQUIVALENT.
- 4. PREFABRICATED UNITS SHALL MEET THE MINIMUM REQUIREMENTS SHOWN,
- 5. MAINTENANCE SHALL BE PERFORMED AS NEEDED AND MATERIAL REMOVED WHEN "BULGES" DEVELOP IN THE SILT FENCE.

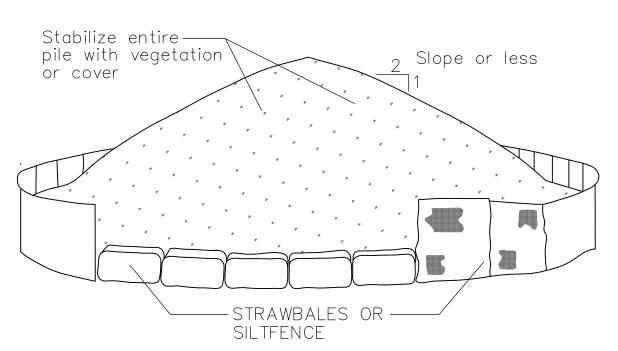

INSTALLATION NOTES:

I. TOPSOIL AND OTHER APPROVED NON-SURPLUS MATERIAL STOCKPILES SHALL BE LOCATED ON UNPAVED, LEVEL, DRY GROUND.

- 2. MAXIMUM SLOPE OF STOCKPILE SHALL BE 1:2
- 3. STOCKPILES SHALL BE COVERED WITH TARPS OR TEMPORARY SEEDING AND BE SURROUNDED BY PROPERLY INSTALLED HAYBALE/STRAWBALE SEDIMENT BARRIERS AND/OR SILT FENCING 4. WHEN UNABLE TO PLACE STOCKPILE ON UNPAVED SURFACES, CONTRACTOR SHALL, AT THE SOLE DISCRETION
- OF THE ENGINEER, PLACE STOCKPILE OVER TARP AND COVER AND/OR CONTAIN AS DESCRIBED ABOVE.
- 5. SEE SPECIFICATIONS FOR INSTALLATION OF SILTFENCE.
- 6. NO STOCKPILE OF SURPLUS MATERIAL WILL BE PERMITTED.

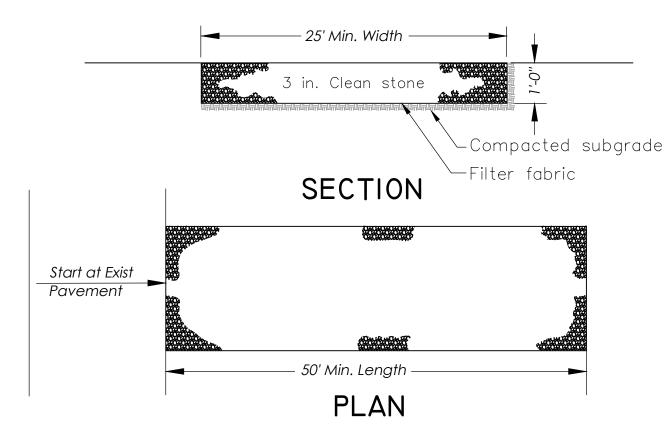

**INSTALATION NOTES:** 

I. STONE SIZE - USE 3" STONE, OR RECLAIMED OR RECYCLED CONCRETE EQUIVALENT. 2. LENGTH - AS REQUIRED, BUT NOT LESS THAN 50 FEET (EXCEPT ON A SINGLE RESIDENCE LOT WHERE A 30 FOOT MINIMUM LENGTH WOULD APPLY. 3. THICKNESS - NOT LESS THAN SIX (6) INCHES.

4. WIDTH - 25 FOOT MINIMUM, BUT NOT LESS THAN THE FULL WIDTH AT POINTS WHERE INGRESS OR EGRESS OCCUR.

5. FILTER CLOTH - WILL BE PLACED OVER THE ENTIRE AREA PRIOR TO PLACING OF STONE. FILTER CLOTH WILL NOT BE REQUIRED ON A SINGLE FAMILY RESIDENCE LOT. 6. SURFACE WATER - ALL SURFACE WATER FLOWING OR DIVERTED TOWARD CONSTRUCTION ENTRANCES SHALL BE PIPED ACROSS THE ENTRANCE. IF PIPING IS IMPRACTICAL, A

MOUNTABLE BERM WITH 5:1 SLOPES WILL BE PERMITTED. 7. MAINTENANCE - THE ENTRANCE SHALL BE MAINTAINED IN A CONDITION WHICH WILL PREVENT TRACKING OR FLOWING OF SEDIMENT ONTO PUBLIC RIGHT OF WAY. THIS MAY REQUIRE PERIODIC TOP DRESSING WITH ADDITIONAL STONE AS CONDITIONS DEMAND AND REPAIR AND/OR CLEANOUT OF ANY MEASURES USED TO TRAP SEDIMENT. ALL SEDIMENT SPILLED DROPPED, WASHED OR TRACKED ONTO PUBLIC RIGHT OF WAY MUST BE REMOVED IMMEDIATELY. 8. WASHING - WHEELS SHALL BE CLEANED TO REMOVE SEDIMENT PRIOR TO ENTRANCE ONTO PUBLIC RIGHT OF WAY. WHEN WASHING IS REQUIRED, IT SHALL BE DONE ON AN AREA

STABILIZED WITH STONE AND WHICH DRAINS INTO AN APPROVED SEDIMENT TRAPPING DEVICE 9. PERIODIC INSPECTION AND NEEDED MAINTENANCE SHALL BE PROVIDED AFTER EACH RAIN.

- 9. Honeycombed, spalled or otherwise defective surfaces shall be patched with an adhesive base cementitious compound. The adhesive shall be a non water sensitive acrylic.
- 10. Concrete shall be cured for a period of seven (7) days. Immediately after placement, concrete shall be protected from premature drying extremes in temperatures, rapid temperature change, mechanical injury and injury from rain and flowing water. Air and forms in contact with concrete shall be maintained at a temperature above 50 degrees F for the first 3 days and at a temperature above 32 degrees F for the remainder of the specified curing period.

## CONCRETE MASONRY:

- 1. All structural concrete masonry shall be in accordance with standard specification for hollow load bearing concrete masonry units ASTM C-90 typical. All concrete masonry units shall be minumum 55 percent solid.
- 2. Structural masonry shall have a minimum strength Fm=
- 3. Mortar for interior shall comply with ASTM C-476, type M & S.
- 4. Calcium chloride or admixtures containing calcium chloride shall not be used in mortar or grout.
- 5. Metal ties and anchors shall be of corrosion—resistant metal or be galvanized.
- 6. Masonry reinforcement shall conform to ASTM A-82 for wire reinforcing.
- 7. All reinforcement shall be deformed bars conforming to ASTM A-615, grade 40. 8. Provide horizontal joint reinforcing at every second course,

## STRUCTURAL LUMBER:

No. 9 Dur-o-wall or equal.

- 1 All framing to be No. 1 & No.2 Doug Fir Larch (North) DESIGN VALUES:
- Fb Single Member = 825 psiFb - Repetitive Member = 1150 psi
- Fv 75 psi Fc - 405 psi perpendicular to grain Fc — 2400 psi parallel to grain
- E 1,400,000 psi 2. All L.V.L.'s to be laminated veneer lumber as manufactured by TrusJoist, type 2800 F-2.0 or equal, with design values:
- Fb 2600 psi Fv - 285 psi
- Fc 750 psi perpendicular to grain
- Fc 2510 psi parallel to grain E - 1.9 x 10 (6) psi
- 3. All framing indicated "LVL" on plan shall be laminated veneer lumber equal to TrusJoist LVL as manufactured by TrusJoist, A Weyerhaeuser Business, 1 800 678 8787 or approved All TJI's and Parallam PSL's shall be by TrusJoist or
- approved equal. 4. For dimensions see architectural drawings.

- 5. All joists or beams framing into (not bearing over) beams, headers or girders shall be supported with galvanized steel joist or beam hangers by Simpson Strong—Tie Co. (914 279 2037) or approved equal. End nailing of joists is not permitted. All post to beam, beam to post and post to footing connections to be made with Simpson post or column cap and base connectors as detailed. Use nailing as recommended by manufacturer.
- 6. Block solid between joists and rafters at bearing walls or girders. Provide bridging at 8'-0" o.c. maximum.
- 7. All plywood sheathing shall be 5/8" exterior grade, C-D, species group 1 or 2. Install roof, floor, wall sheathing with face grain perpendicular to supports. Stagger joints.
- 8. Provide double floor joists under all walls parallel to framing. 9. Provide ledgers, blocking, nailers and rough framing hardware as required.
- 10. Set all framing with natural crown up.
- 11. Frame with double headers and trimmers around openings larger than spacing between joists, studs or rafters, unless larger is shown on plans
- 12. All framing shall be done in accordance with the latest edition of "National Design Specifications for Stress Graded Lumber and its Fastenings" as published by the National Lumber Manufacturers Association.
- 13. All workmanship including minimum nailing, blocking, bridging, etc., shall conform to the New York State Building Code.
- 14. All lumber materials used in the construction shall be new, sound and dry materials, free from rot, large and loose knots, shakes and other imperfections whereby strength may be impaired. Sizes shall be as indicated on the drawings.
- 15. Provide special heavy duty metal hangers and / or steel fabrications where shown and as may be required to transfer all loads.
- 16. Contractor shall supply all temporary bracing of the structure, as required, until all exterior sheathing has been installed. 17. Built-up girders and headers shall be fastened together as
- follows: A). For up to 3 plies, use 2 rows of nails staggered at
- 12" centers; use 10 d nails on 1-1/2" members and 16 d nails on 1-3/4" members. For more than 3 plies, use 2 rows of 1/2" diameter
- through bolts at 12" centers staggered. 18. Ceiling joists must be lapped against and attached directly to rafters with 3 - 16 d common nails. Do not use
- 19. Toe nail all joists and rafters to top plate of stud bearing walls or partitions with a minimum of 3 - 16 d common nails.
- 20. Precautions shall be taken to minimize air borne saw dust created from cutting CCA treated members. Dust masks shall be worn by anyone working in the immediate area where treated members are being cut.

- 21. Provide minimum 3-1/2" deep bearing full width of headers
- 22. Notching of members is not permitted. This applies to all framing members, trusses and structural lumber. 23. Ceiling joists shall be connected to each other to create
- continuous members to tie opposite roof rafters together. 24. Collar ties shall be one continuous member to tie opposite
- roof rafters together. 25. Install all collar ties and ceiling joists simultaneously with roof rafters.

## LOADING SCHEDULE:

SOIL BEARING ASSUMED TO BE 4,000 P.S.F.

ROOF LOADING 30 P.S.F. SNOW LOAD DEAD LOAD 15 P.S.F. 45 P.S.F. TOTAL LOAD FLOOR LOADING LIVE LOAD ATTIC 30 P.S.F. 1st and 2nd FLOOR 40 P.S.F. DEAD LOAD ATTIC 15 P.S.F. 15 P.S.F. 1st and 2nd FLOOR

STRUCTURAL STEEL TO BE A-36, Fb = 24,000

## ELECTRICAL NOTES:

- 1. Unless dimensioned all electrical layouts are schematic. Exact location to be determined by field coordination with owner's approval.
- 2. Electrical contractor shall obtain all inspections and approvals required by local, state and national codes and shall be responsible that all electrical work called for on drawings and specifications and other requirements of codes are met.
- 3. Electrical contractor shall verify total electrical load for existing and proposed work and shall notify architect on service requirements, and additional service shall be installed in conformance with local codes.
- 4. All light fixtures by owner installed by contractor unless specified otherwise.
- connections for all mechanical equipment as required. 6. Thermostats to be supplied by HVAC contractor and installed by electrical contractor.

5. Electrical contractor to do all necessary wiring and

- 7. All telephone and T.V. outlets shall be located and installed by others. Contractor shall coordinate with owner and installer during construction to insure all wires are hidden in construction prior to installation of final finishes.

8. All new switches to be silent switches.

9. Wiring shall be "Rome X" cable.

- 10. Minimum service shall be 120/240 V, 3 wire, single phase with min, 50 amp spare capacity.
- 11. Distribution shall be circuit breakers type w/ min. 2 extra circuits.
- 12. Dedicated circuits shall be provided for high-draw equipment and appliances.
- 13. All electrical receptacles shall be duplex type, 15 amp minimum.
- 14. Smoke detecting alarm devices shall be single-station type, either photo-electric or ionization shall be directly connected to a lighting circuit with no intervening wall switch. Provide detectors to protect each separate sleeping area adequately.

## PLUMBING NOTES:

- 1. Work shall consist of furnishing all labor, materials, and equipment necessary and required to complete all plumbing work as indicated on the drawings and specified herein including but not limited to the following:
- A. Rubbish removal.
- B. A sanitary drainage and venting system conveying the wastes from plumbing fixtures, to connect with the sanitary sewer, septic system, or existing system.
- C. Cold water supply from the water main or existing system, distribution piping, and connections to all plumbing fixtures and equipment requiring cold water.
- D. Hot water supply from new or existing hot water supply system, hot water supply piping, and connections to all piping fixtures and equipment requiring hot water.
- E. Cleaning, adjusting and testing.
- F. All plumbing fixtures and supports, trimmings, pipe fittings, hangers, valves, traps, vacuum breakers, insulation, and other accessories required to complete the work ready for operation.
- 2. Pipes and materials shall be as follows:
- A. Soil and main vent plastic Branch vents — plastic.
- temper above grade, type K below grade. 3. All materials shall be new and installed with skilled labor in a first class manner.
- 4. All drainage piping shall pitch at a minimum 1/8" per foot in direction of flow unless otherwise shown on

Hot and cold water — copper tubing type L hard

- 5. All hot and cold water piping and fittings to be insulated with Rubatex R—180 F.S tubing insulation or
- 6. Toilet seats and covers shall be solid plastic, residential weight, medium impact polystyrene, color as selected by owner.
- 7. The contractor shall file all necessary drawings of plumbing work with the proper authorities, shall make any minor changes requested or required and shall obtain and pay for all necessary approvals and permits for the plumbing systems required by local authorities, county, and/or the state; he shall pay for all the fees, changes etc., required by these authorities without any additional charge to the owner.

# For Building Permit Drawing Revisions

Drawing Issue

## Bello Architecture, PLLC

36 New Street Rye, New York 10580 Tel: 914-690-0870 Fax: 914-937-1968

## Project:


409 Delancey Avenue Mamaroneck, New York 10543

Cotter Residence

Sheet Title:

Erosion Control Details and General Notes

20125 As Noted C - 1023/15/21 Drawn By RB

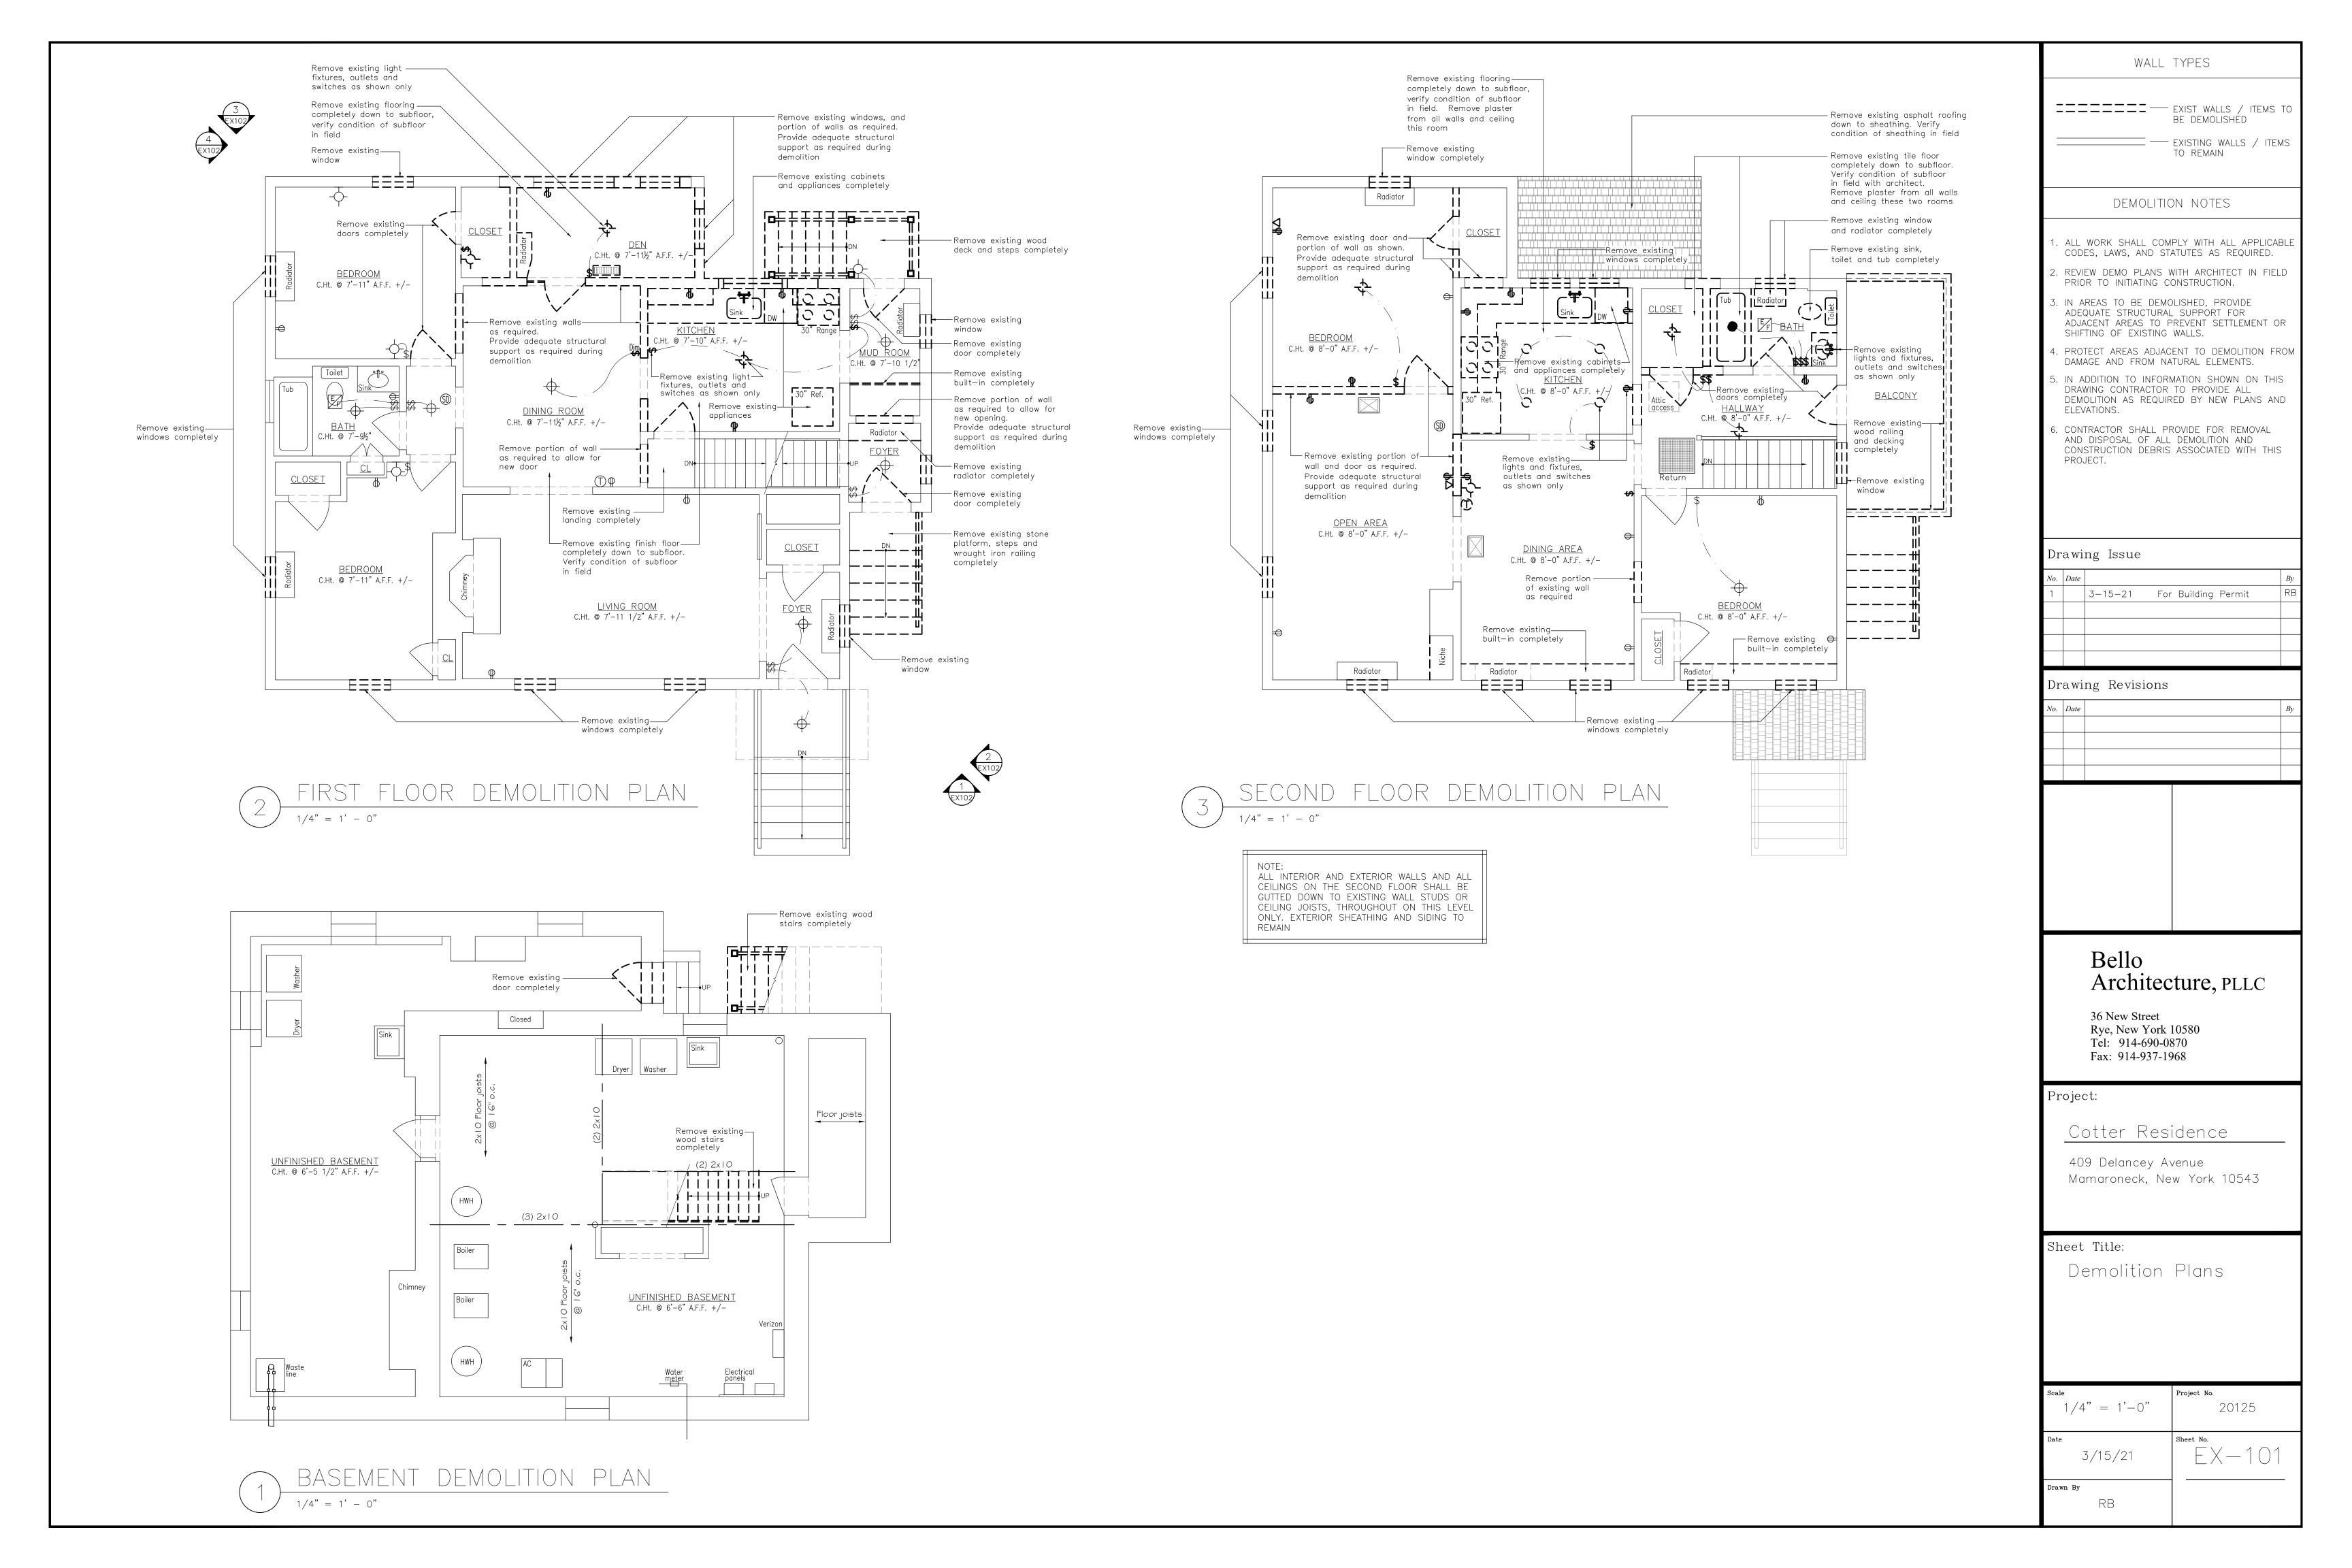



WALL TYPES EXIST WALLS / ITEMS TO BE DEMOLISHED — EXISTING WALLS / ITEMS TO REMAIN DEMOLITION NOTES ALL WORK SHALL COMPLY WITH ALL APPLICABLE CODES, LAWS, AND STATUTES AS REQUIRED. REVIEW DEMO PLANS WITH ARCHITECT IN FIELD PRIOR TO INITIATING CONSTRUCTION. . IN AREAS TO BE DEMOLISHED, PROVIDE ADEQUATE STRUCTURAL SUPPORT FOR ADJACENT AREAS TO PREVENT SETTLEMENT OR SHIFTING OF EXISTING WALLS. PROTECT AREAS ADJACENT TO DEMOLITION FROM DAMAGE AND FROM NATURAL ELEMENTS. IN ADDITION TO INFORMATION SHOWN ON THIS DRAWING CONTRACTOR TO PROVIDE ALL DEMOLITION AS REQUIRED BY NEW PLANS AND ELEVATIONS. CONTRACTOR SHALL PROVIDE FOR REMOVAL AND DISPOSAL OF ALL DEMOLITION AND CONSTRUCTION DEBRIS ASSOCIATED WITH THIS Drawing Issue 3-15-21 For Building Permit Drawing Revisions Bello

## Architecture, PLLC

36 New Street Rye, New York 10580 Tel: 914-690-0870 Fax: 914-937-1968

## Project:


## Cotter Residence


409 Delancey Avenue Mamaroneck, New York 10543

## Sheet Title:

Existing Elevations


Scale $1/4$ " = $1'-0$ "	Project No. 20125
Date 3/15/21	Sheet No
Drawn By	

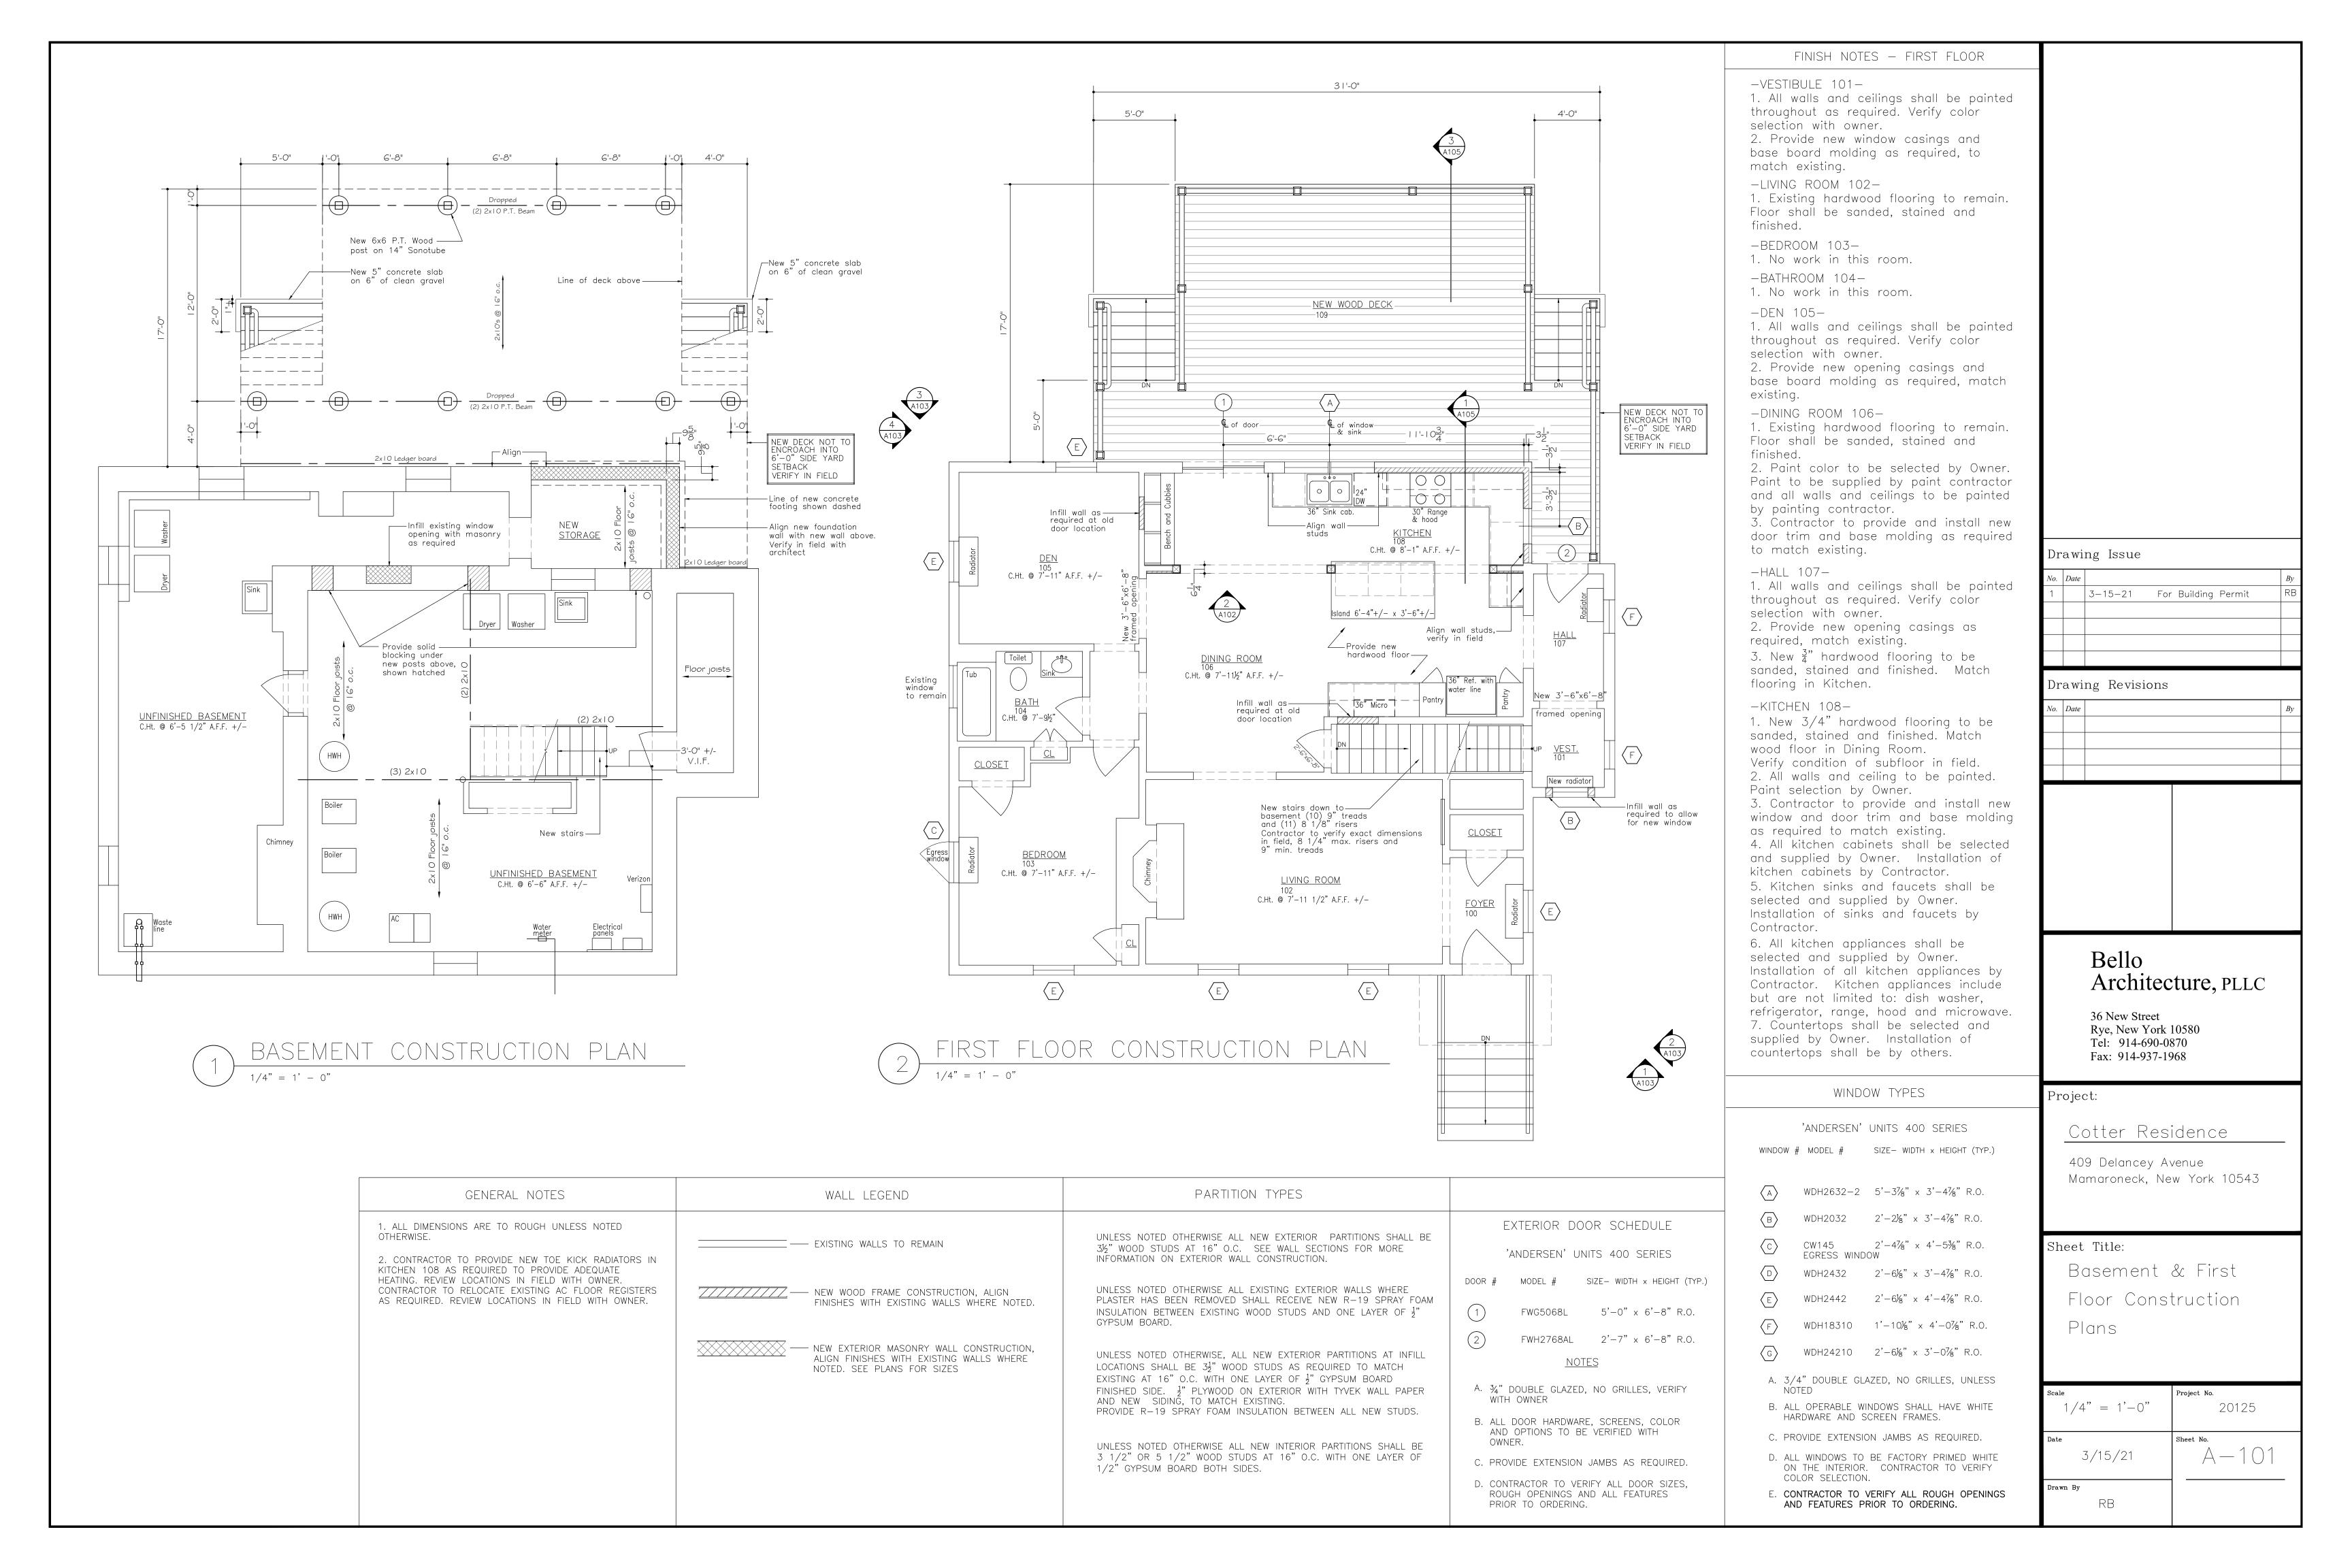

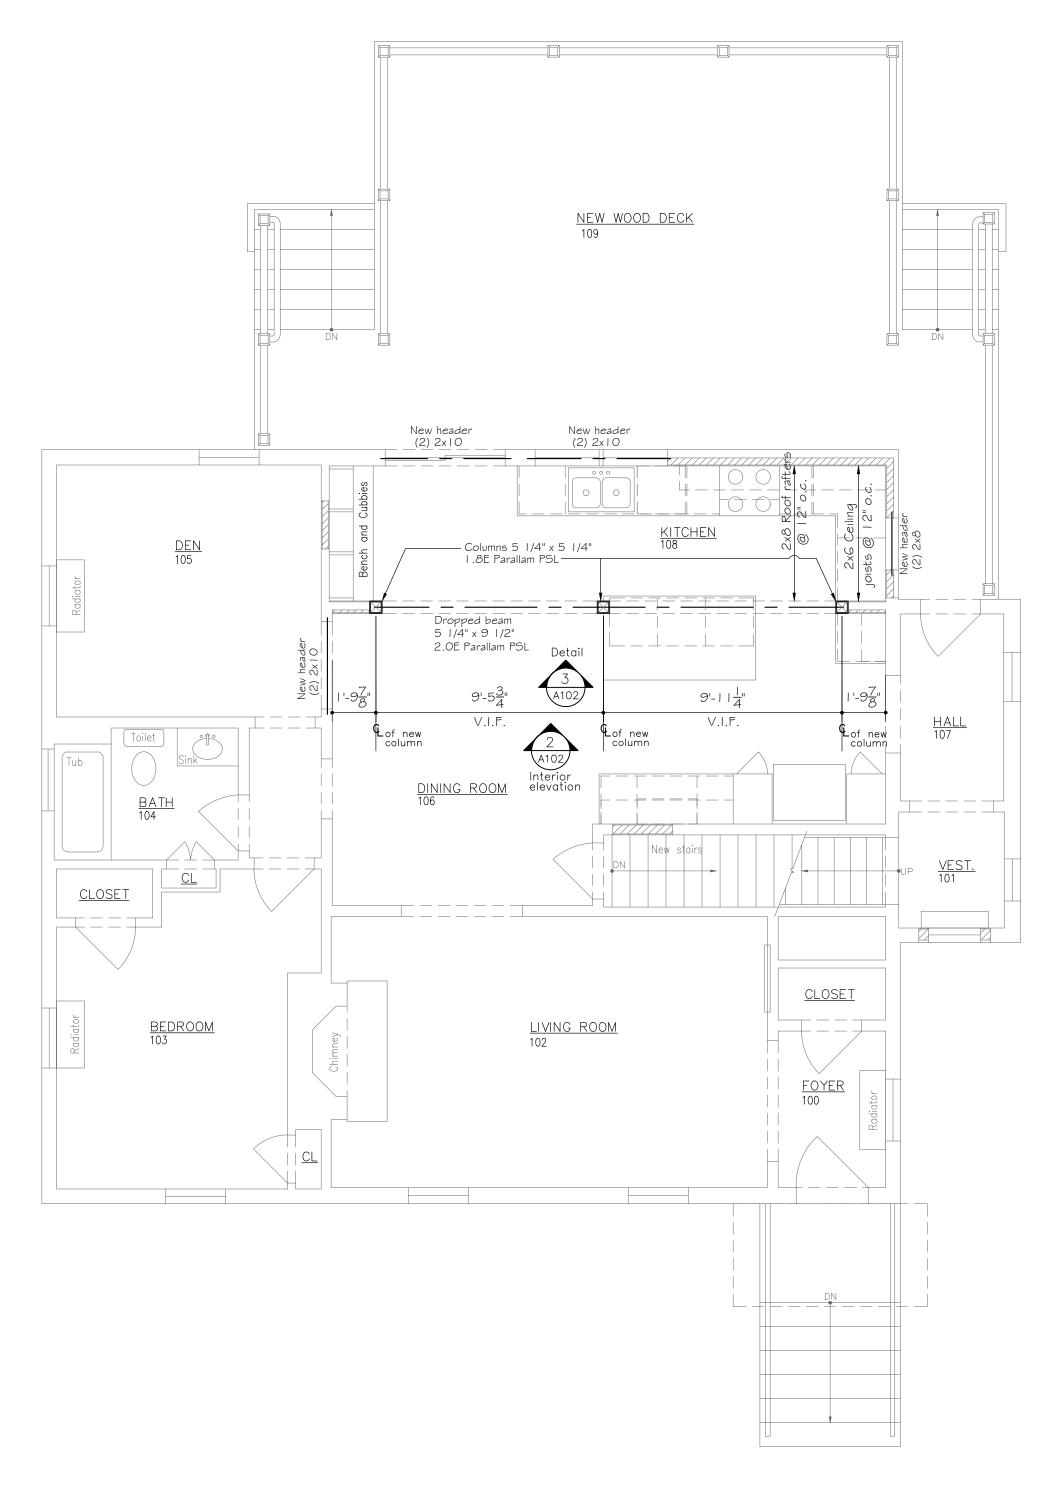


FIRST FLOOR STRUCTURAL PLAN

1/4" = 1' - 0"

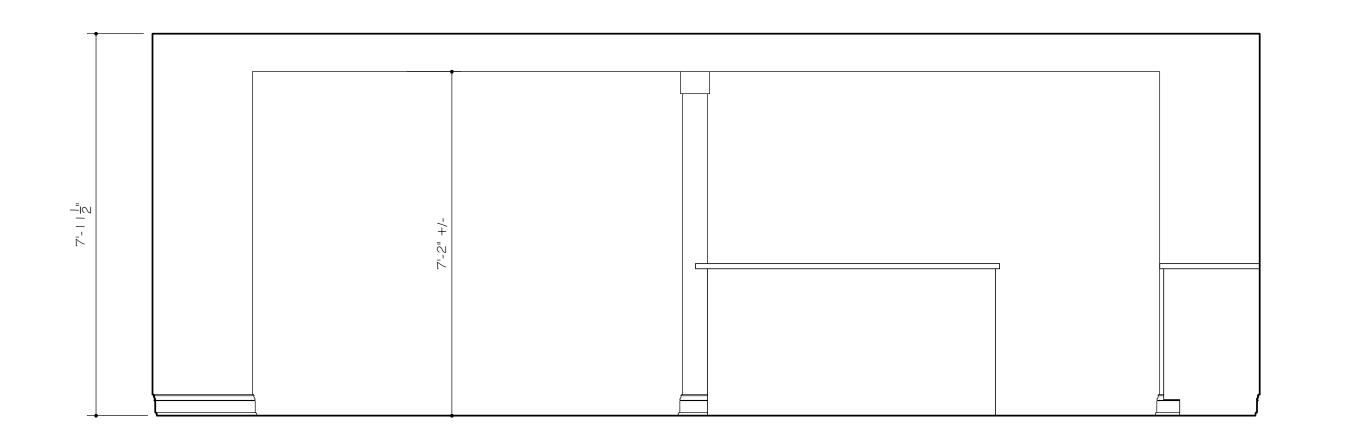

2 INTERIOR KITCHEN ELEVATION

1/2" = 1' - 0"

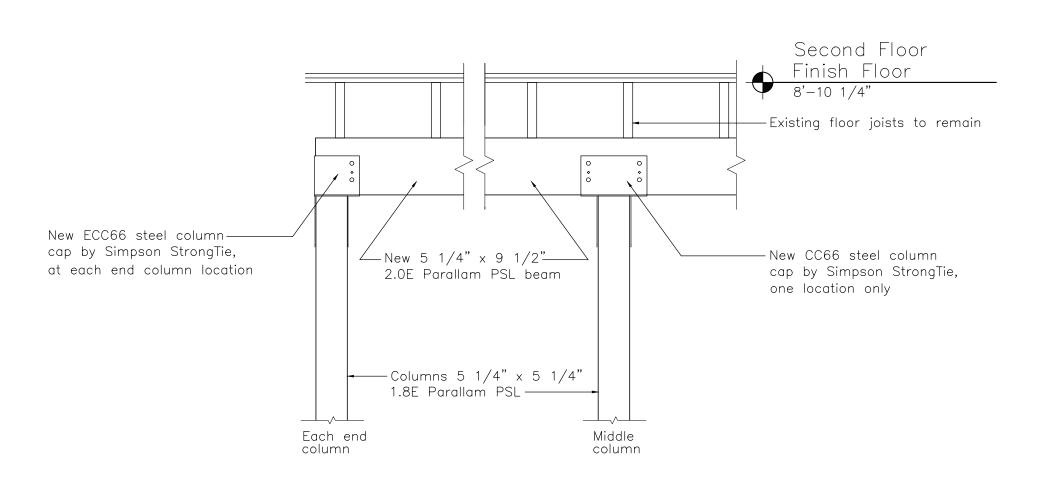

3) NEW BEAM & COL DETAIL

3/4" = 1' - 0"

No.	Date	
1		3-15-21 For Building Permit
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		I
No.	Date	

# Bello Architecture, PLLC

36 New Street Rye, New York 10580 Tel: 914-690-0870 Fax: 914-937-1968

## Project:


Cotter Residence

409 Delancey Avenue Mamaroneck, New York 10543


Sheet Title:

Structural Plan & Details

Scale As Noted	Project No. 20125
Date 3/15/21	Sheet No.
Drawn By	

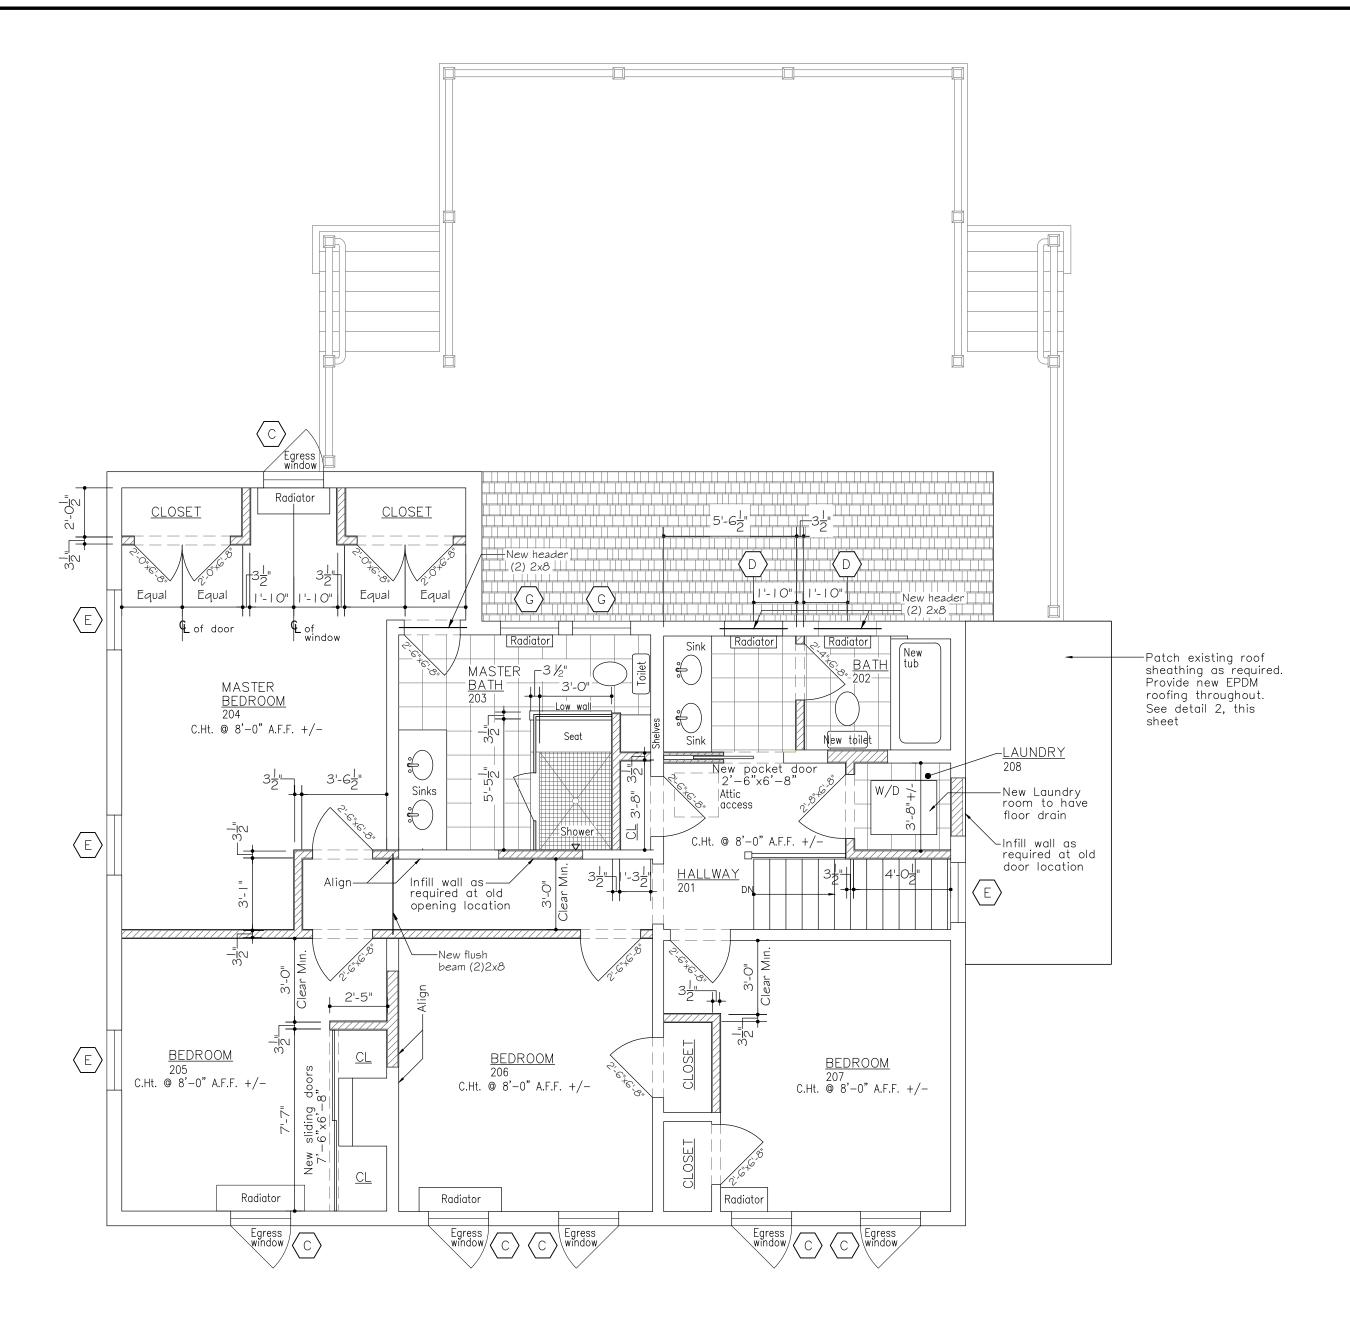

# SECOND FLOOR CONSTRUCTION PLAN

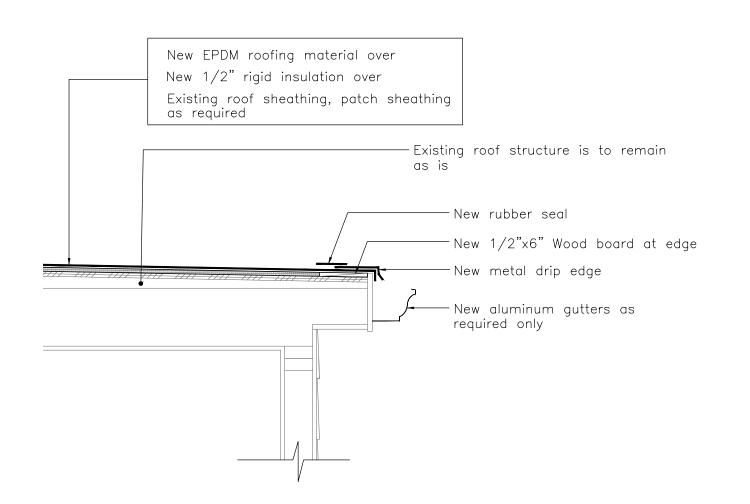



#### FINISH NOTES - SECOND FLOOR

-HALLWAY 201-

1. Existing hardwood flooring to remain. Floor shall be sanded, stained and finished.

2. All walls and ceilings shall be painted throughout as required. Verify color selection with owner.

3. Provide new door casings, baseboard, and shoe molding as required.

-BATHROOM 202-

1. All cabinets at sink area shall be supplied by owner. Installation of cabinets shall be by GC.

2. New toilet by Owner, installed by GC. 3. New tub and related plumbing fixtures for tub shall be by Owner and installed by GC.

4. New ceramic wall tiles by Owner, installed by GC around tub area. 5. All granite for sink areas shall be supplied and installed by others. 6. New ceramic floor tiles by Owner, installed by GC.

7. New sinks and related plumbing fixtures by Owner, installed by GC. 8. New sconces by Owner, installed by

9. New mirrors by Owner, installed by

10. All bathroom accessories shall be selected and supplied by Owner. All accessories shall be installed by GC. 11. Paint color to be selected by Owner. Paint to be supplied by paint contractor and all walls and ceilings to be painted by painting contractor. 12. All new doors and windows shall receive new casings. Match existing. 13. Provide new base board molding throughout this room. Match existing.

-MASTER BATHROOM 203-

1. All cabinets at sink area shall be supplied by owner. Installation of cabinets shall be by GC.

2. New toilet by Owner, installed by GC. 3. New plumbing fixtures for shower by Owner, installed by GC. Verify location in field with Owner.

4. New ceramic wall tiles by Owner, installed by GC in shower. 5. All granite for sink and shower areas shall be supplied and installed by

6. New ceramic floor tiles by Owner, installed by GC.

7. New sinks and related plumbing fixtures by Owner, installed by GC. 8. New sconces by Owner, installed by

9. New mirrors by Owner, installed by

10. All bathroom accessories shall be selected and supplied by Owner. All accessories shall be installed by GC. 11. Glass shower enclosure and door shall be by others.

12. Built—In shelves shall be built by

13. Paint color to be selected by Owner. Paint to be supplied by paint contractor and all walls and ceilings to be painted by painting contractor. 14. All new doors and windows shall receive new casings. Match existing. 15. Provide new base board molding throughout this room. Match existing.

-MASTER BEDROOM 204-

throughout as required. Verify color selection with owner.

as required.

-BEDROOM 205-

1. Existing hardwood flooring to remain. Floor shall be sanded, stained and finished.

2. All walls and ceilings shall be painted throughout as required. Verify color selection with owner.

3. Provide new door and window casings, baseboard and shoe molding as required.

-BEDROOM 206-

1. Existing hardwood flooring to remain. Floor shall be sanded, stained and finished.

2. All walls and ceilings shall be painted throughout as required. Verify color selection with owner.

3. Provide new door and window casings, baseboard and shoe molding as required.

-BEDROOM 207-

1. Existing hardwood flooring to remain. Floor shall be sanded, stained and finished.

2. All walls and ceilings shall be painted throughout as required. Verify color selection with owner.

3. Provide new door and window casings, baseboard and shoe molding as required.

Drawing Issue

No.	Date		Ву
1		3-15-21 For Building Permit	RB

GENERAL NOTES

1. ALL DIMENSIONS ARE TO ROUGH UNLESS NOTED OTHERWISE.

2. CONTRACTOR TO PROVIDE NEW RADIATORS AS REQUIRED ONLY TO PROVIDE ADEQUATE HEATING. REVIEW LOCATIONS IN FIELD WITH OWNER. CONTRACTOR TO RELOCATE EXISTING AC REGISTERS AS

REQUIRED. REVIEW LOCATIONS IN FIELD WITH OWNER.

Drawing Revisions

PARTITION TYPES

\_\_\_\_\_ — EXISTING WALLS TO REMAIN

WITH EXISTING WALLS WHERE

//////// --- NEW WOOD FRAME CONSTRUCTION, ALIGN FINISHES

PARTITION TYPES

UNLESS NOTED OTHERWISE ALL NEW INTERIOR

BATHROOM WALLS AND CEILINGS. PROVIDE  $\frac{1}{2}$ " CEMENT BOARD IN ALL TUB AND SHOWER LOCATIONS.

UNLESS NOTED OTHERWISE ALL EXISTING EXTERIOR WALLS

Bello Architecture, PLLC

36 New Street Rye, New York 10580 Tel: 914-690-0870 Fax: 914-937-1968

Project:

Cotter Residence

409 Delancey Avenue Mamaroneck, New York 10543

Sheet Title:

Second Floor Construction Plan & Detail

20125 As Noted A - 1033/15/21 Drawn By RB

PARTITIONS SHALL BE  $3\frac{1}{2}$ " OR  $5\frac{1}{2}$ " WOOD STUDS AT 16" O.C. WITH ONE LAYER OF  $\frac{1}{2}$  GYPSUM BOARD BOTH SIDES. PROVIDE 17 MOISTURE RESISTANT GYPSUM BOARD AT ALL

1. Existing hardwood flooring to remain. Floor shall be sanded, stained and finished.

2. All walls and ceilings shall be painted


3. Provide new door and window casings, baseboard and shoe molding


WHERE PLASTER HAS BEEN REMOVED SHALL RECEIVE NEW R-19 SPRAY FOAM INSULATION BETWEEN EXISTING WOOD STUDS AND ONE LAYER OF 1" GYPSUM BOARD. PROVIDE 1"MOISTURE RESISTANT GYPSUM BOARD AT ALL BATHROOM WALLS AND CEILINGS. PROVIDE  $\frac{1}{2}$ " CEMENT BOARD IN ALL TUB AND SHOWER LOCATIONS.


UNLESS NOTED OTHERWISE, ALL NEW EXTERIOR PARTITIONS AT INFILL LOCATIONS SHALL BE 37 WOOD STUDS AS REQUIRED TO MATCH EXISTING AT 16" O.C. WITH ONE LAYER OF  $\frac{1}{2}$ " GYPSUM BOARD FINISHED SIDE.  $\frac{1}{2}$ " PLYWOOD ON EXTÉRIOR WITH TYVEK WALL PAPER AND NEW SIDING, TO MATCH EXISTING.


PROVIDE R-19 SPRAY FOAM INSULATION BETWEEN ALL NEW PROVIDE 1"MOISTURE RESISTANT GYPSUM BOARD AT ALL BATHROOM WALLS AND CEILINGS. PROVIDE 1/2" CEMENT BOARD IN ALL TUB AND SHOWER LOCATIONS.



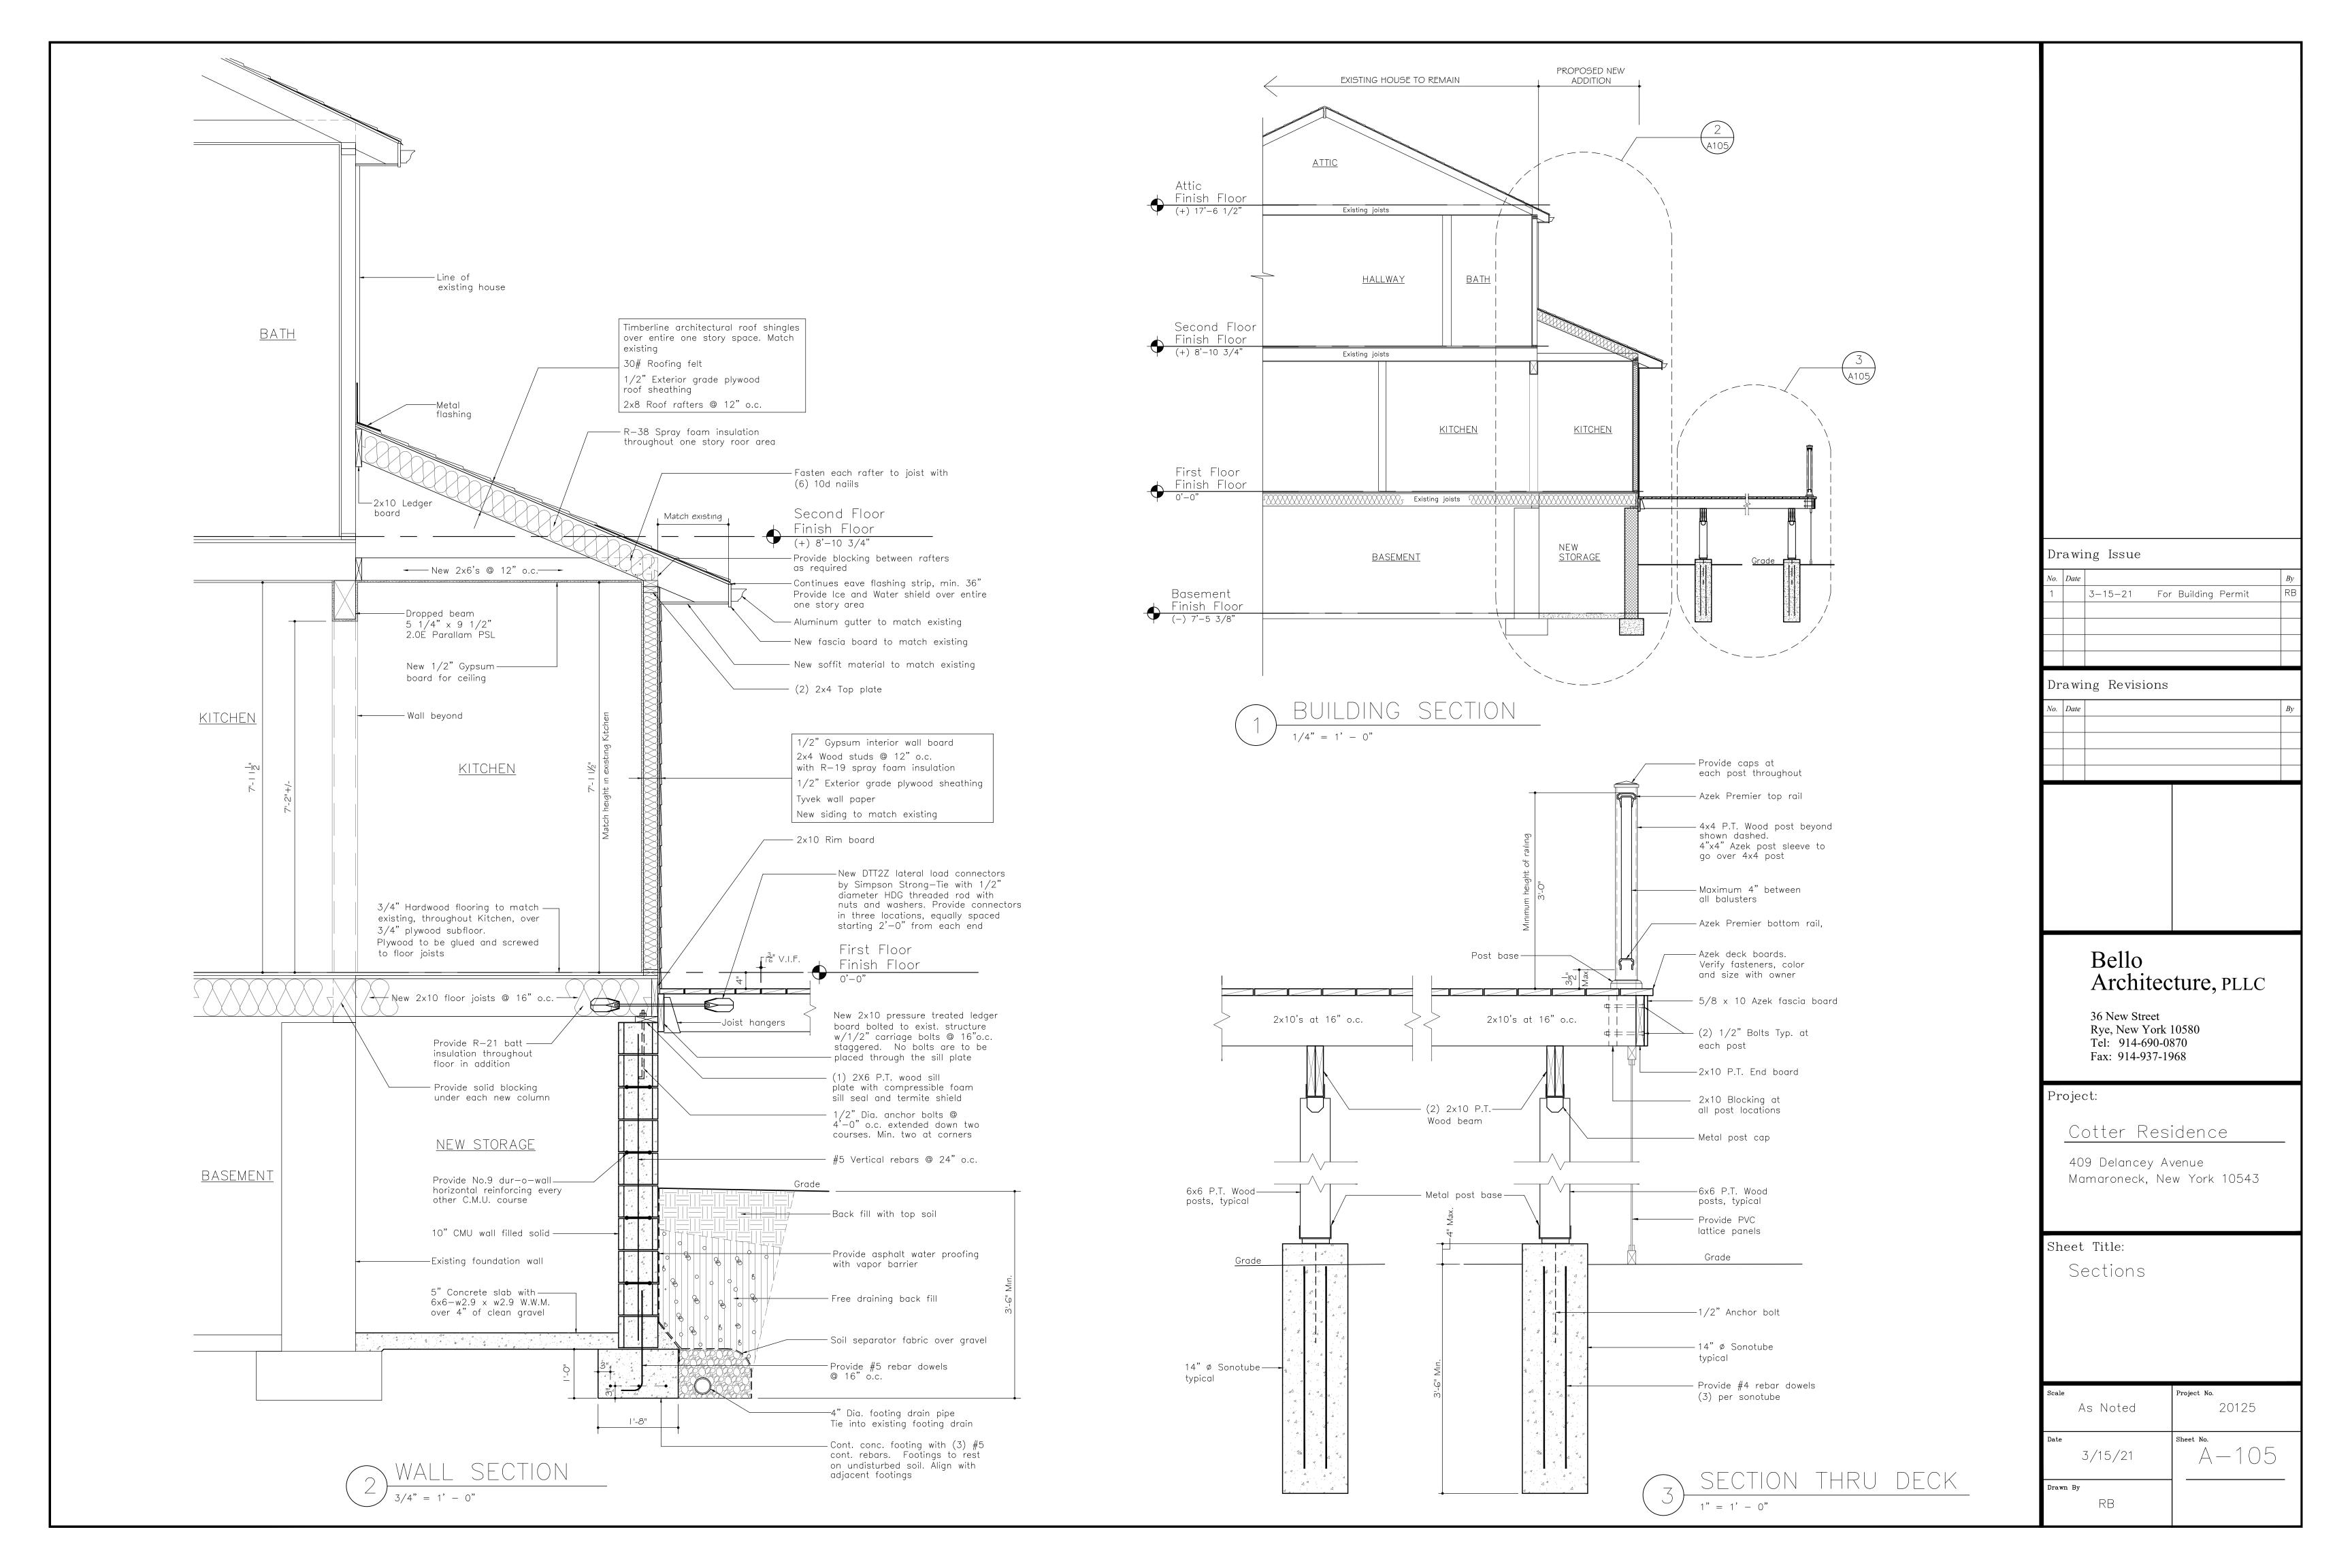


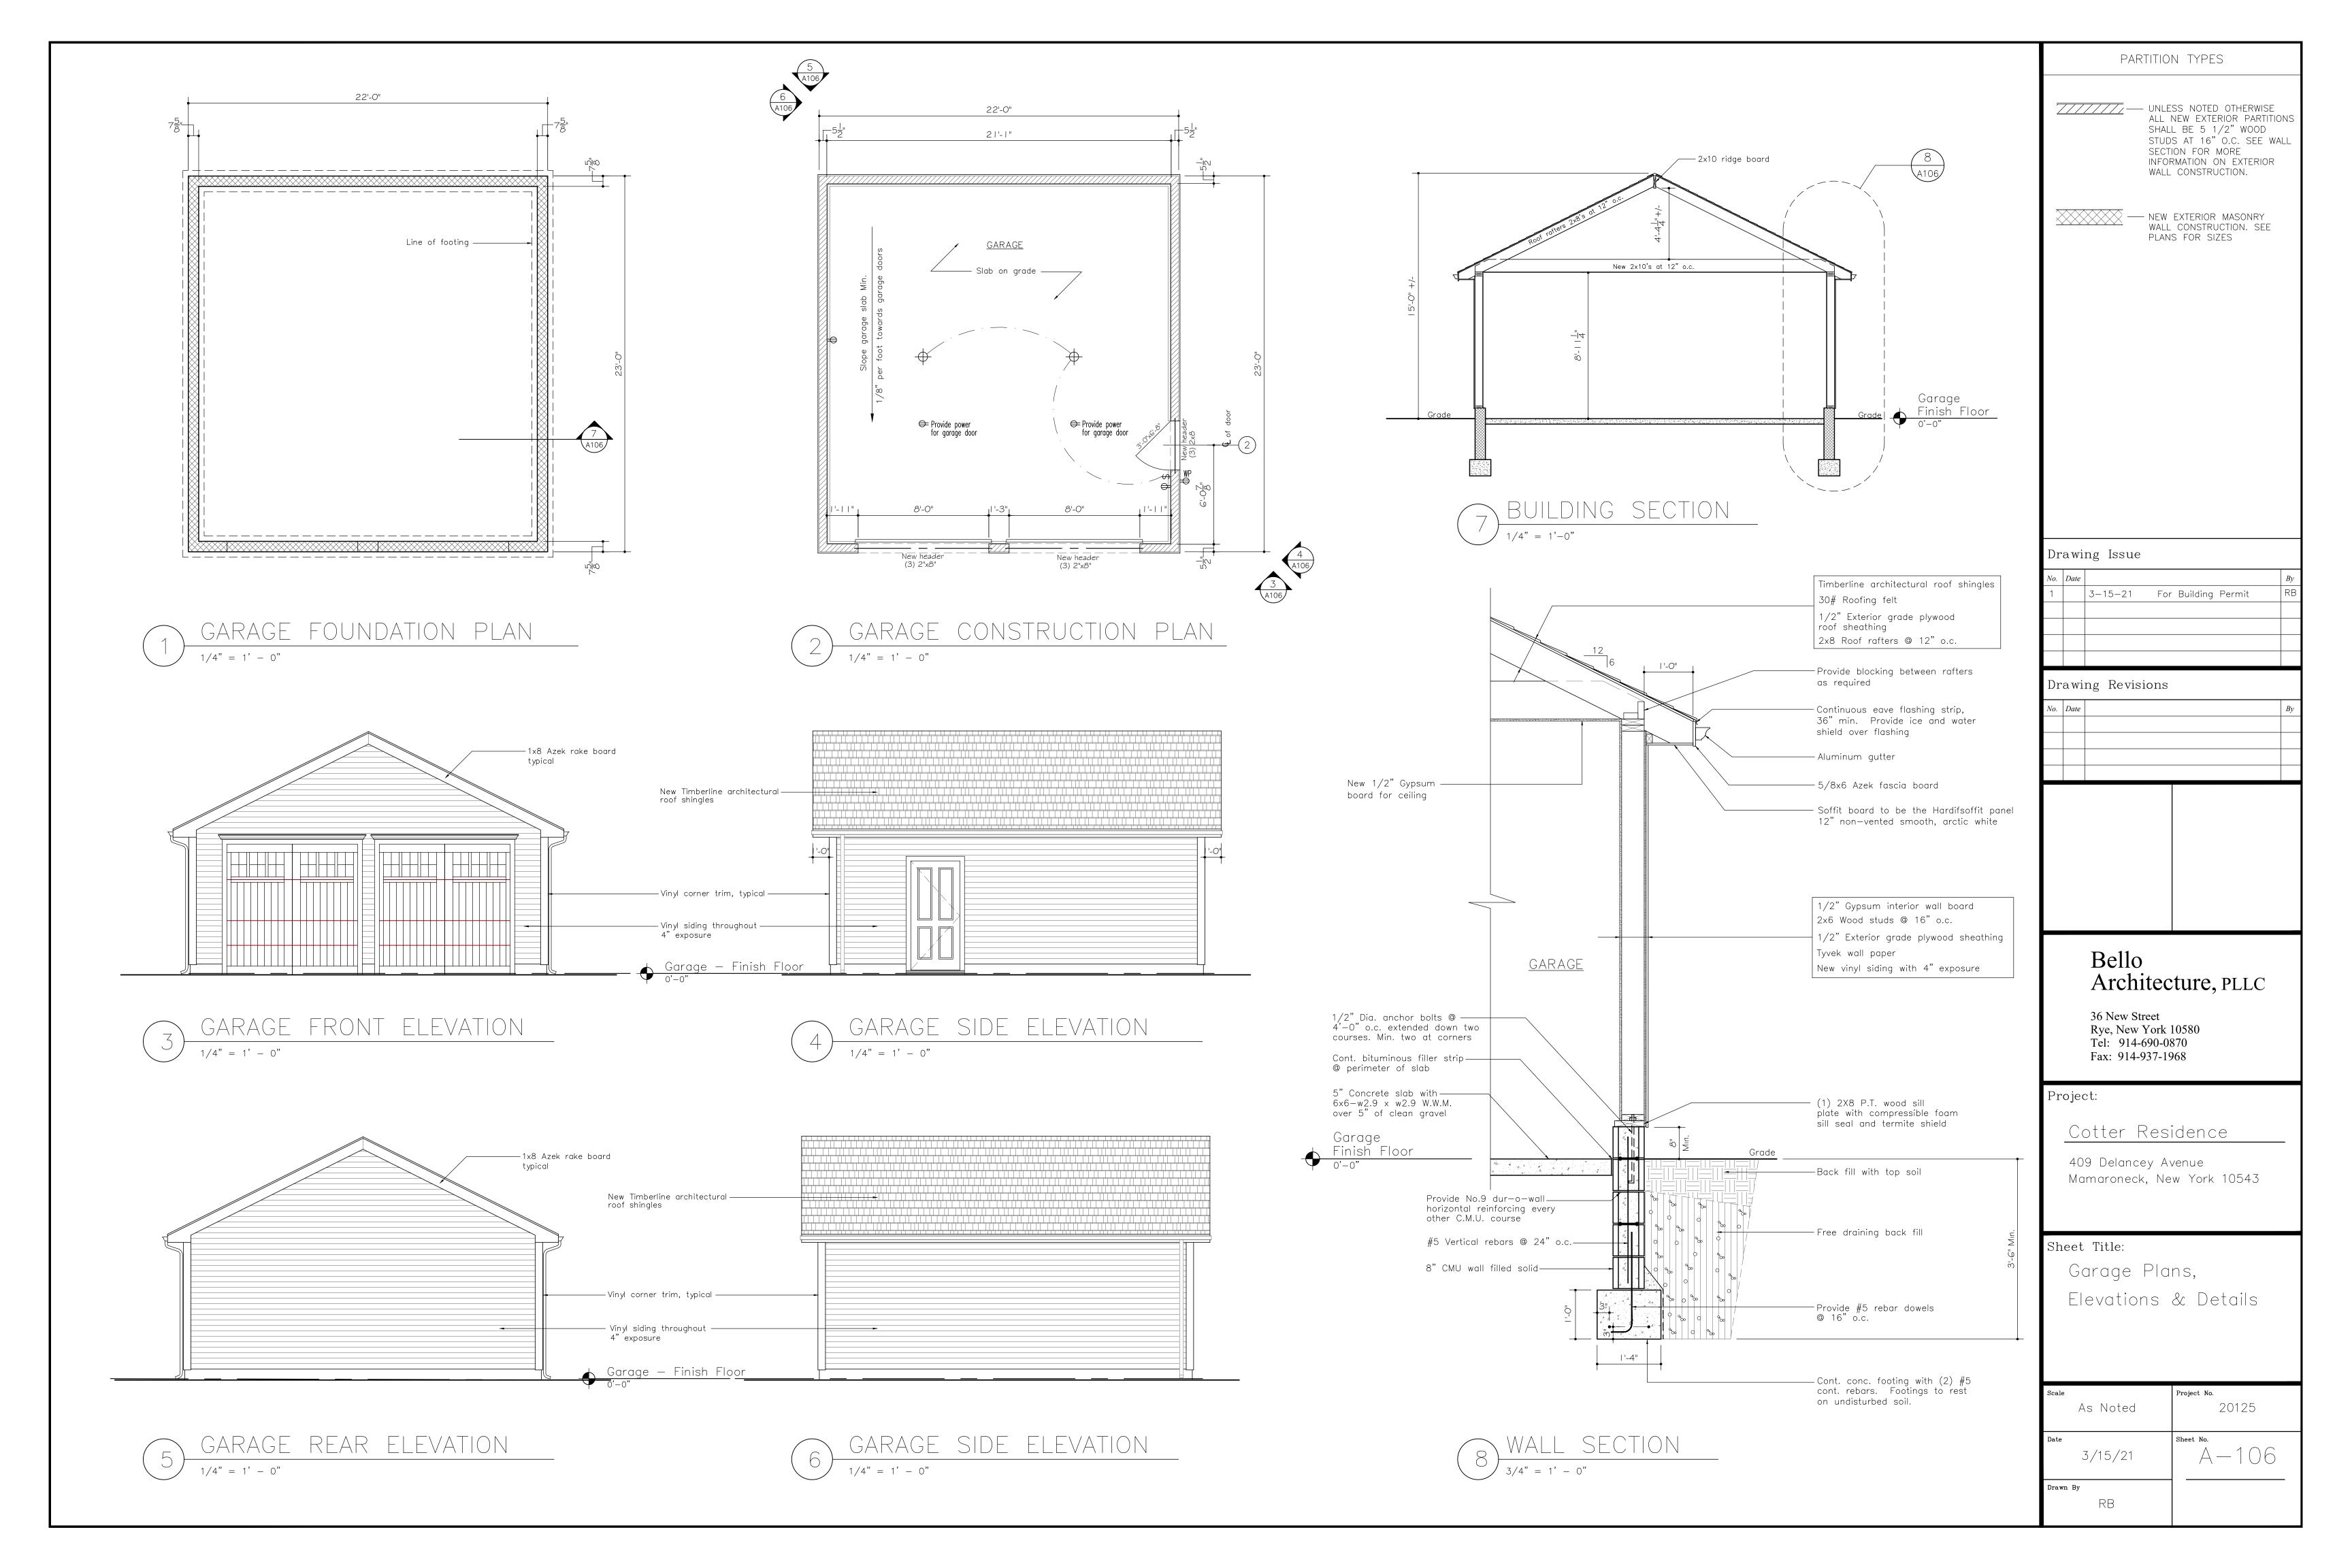

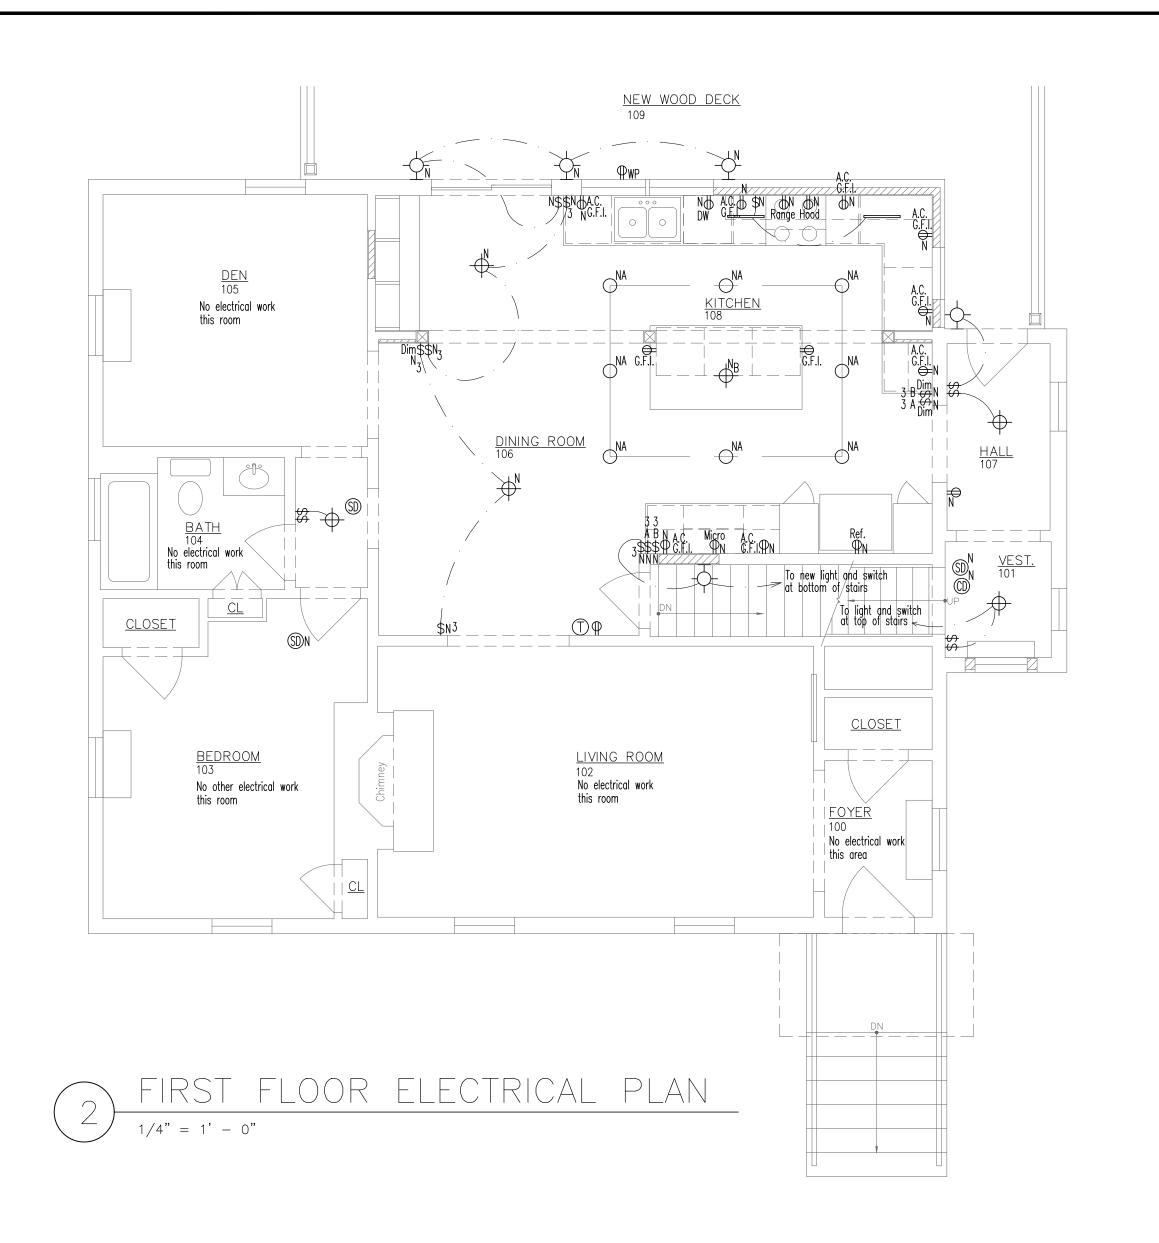

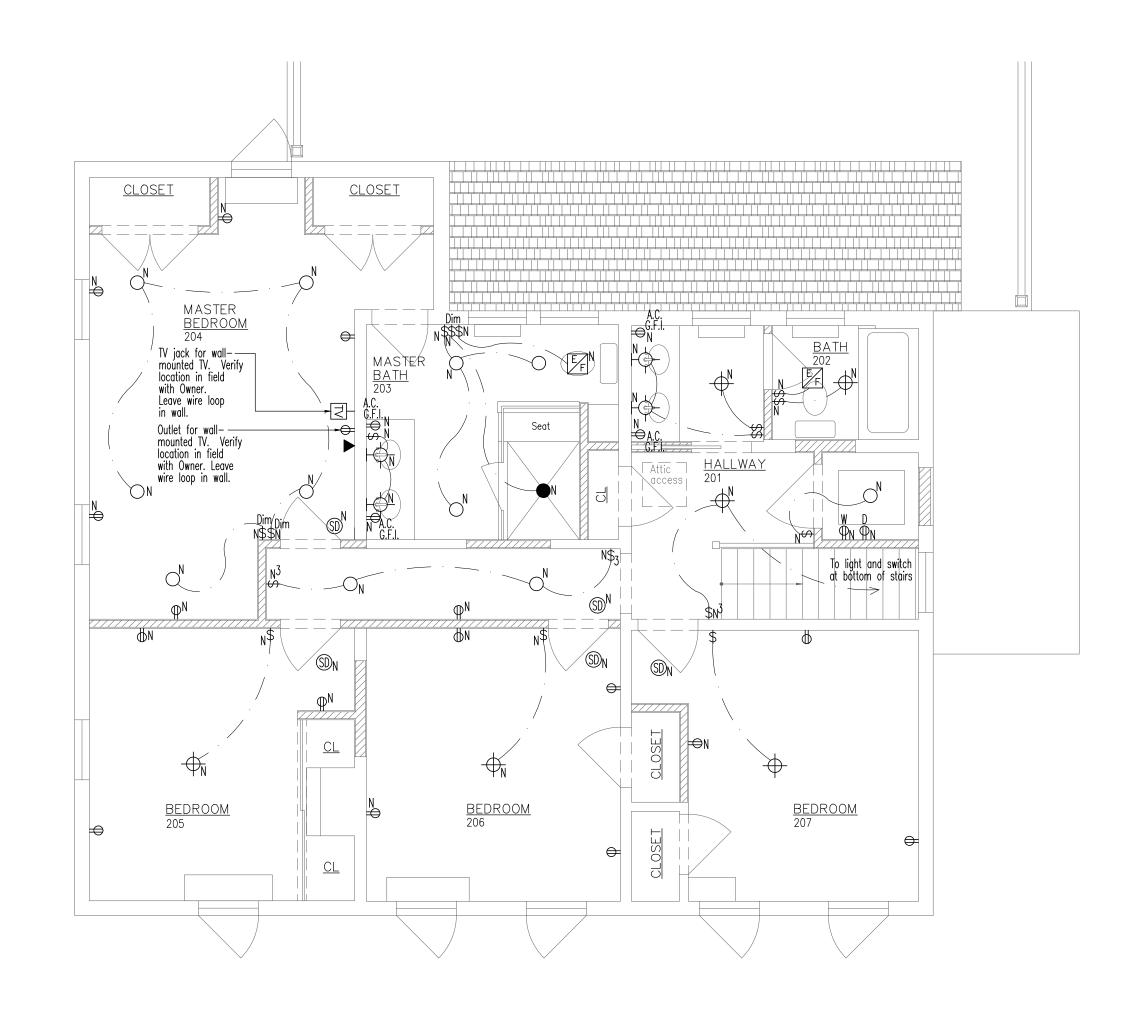

SECOND FLOOR ELECTRICAL PLAN

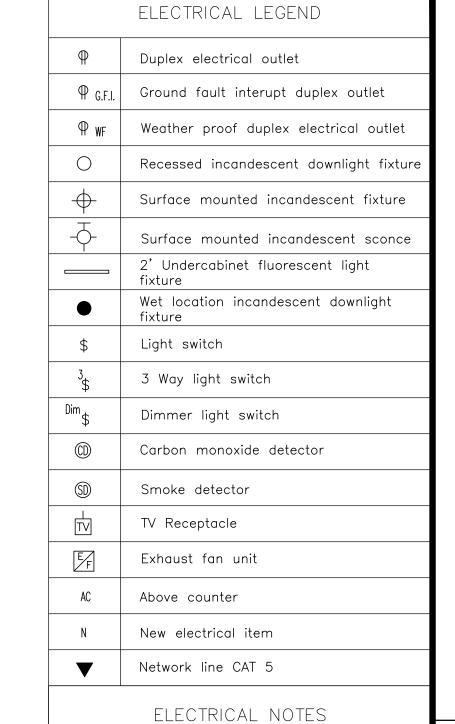

1. OUTLETS SHOWN ON PLANS ARE MINIMUM, G.C. TO PROVIDE NUMBER AS REQUIRED BY CODE. OUTLET LOCATIONS INCLUDING ELECTRICAL, T.V., PHONE, ETC. TO BE REVIEWED IN FIELD WITH OWNER.

- 2. ELECTRICAL CONTRACTOR TO PROVIDE AND COORDINATE AL ELECTRICAL OUTLETS AS REQUIRED FOR ALL APPLIANCES AS REQUIRED.
- 3. PROVIDE SMOKE ALARM SYSTEM AS REQUIRED BY CODE. 4. ALL ELECTRICAL LIGHT FIXTURES, SWITCHES AND OUTLETS SHALL BE SELECTED BY OWNER AND INSTALLED BY THE ELECTRICAL CONTRACTOR.
- 5. PROVIDE CARBON MONOXIDE DETECTORS AS PER CODE. REVIEW LOCATIONS WITH OWNER.
- 6. ALL ELECTRICAL LIGHT FIXTURES, SWITCHES AND OUTLETS SHOWN ON PLANS ARE EXISTING UNLESS SHOWN N FOR NEW ITEMS.

Drawing Issue

3-15-21 For Building Permit

Drawing Revisions

## Bello Architecture, PLLC

36 New Street Rye, New York 10580 Tel: 914-690-0870 Fax: 914-937-1968

## Project:


## Cotter Residence

409 Delancey Avenue Mamaroneck, New York 10543

Sheet Title:

Electrical Plans

Scale $1/4$ " = $1'-0$ "	Project No. 20125
Date 3/15/21	Sheet No.
Drawn By	

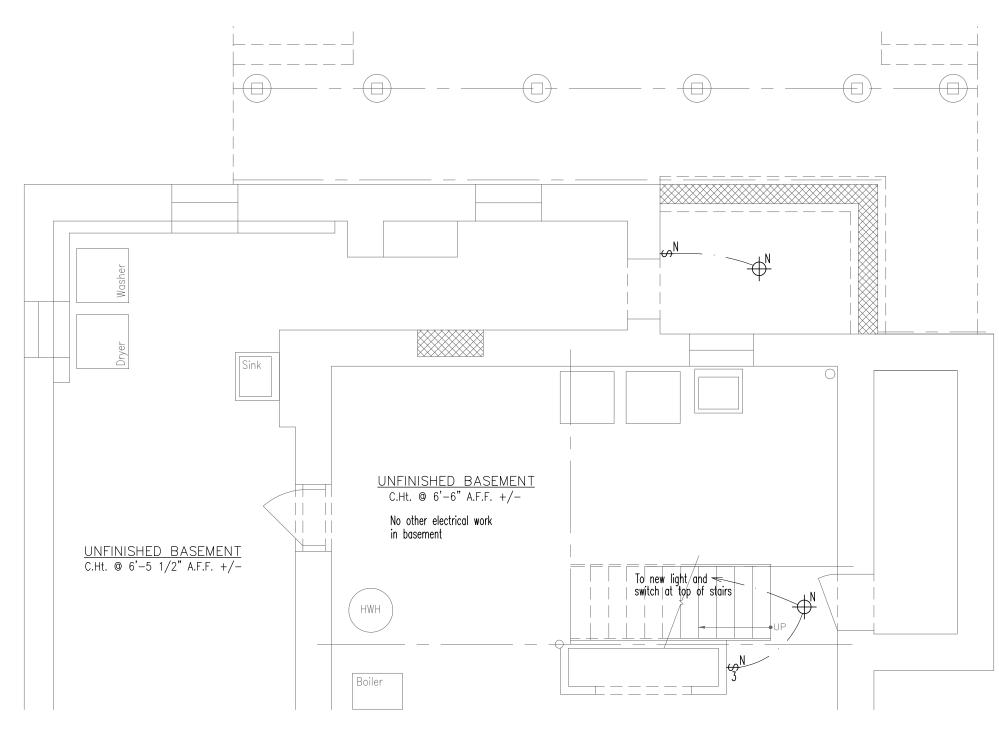

PARTIAL BASEMENT ELECTRICAL PLAN