



LEGEND

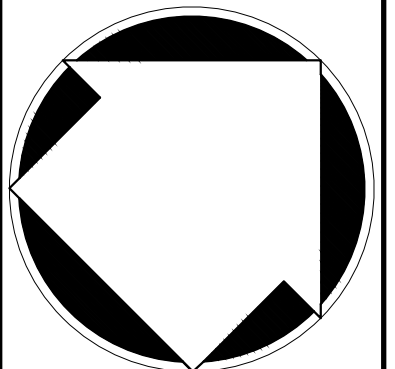
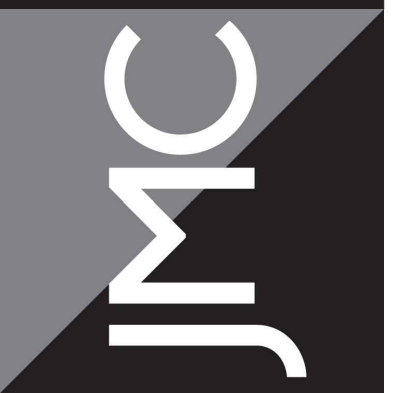
- EXISTING PROPERTY LINE
- ADJACENT PROPERTY LINE
- EXISTING EASEMENT LINE
- EXISTING BUILDING LINE
- EXISTING PAVEMENT EDGE
- EXISTING CONTOUR
- EXISTING INDEX CONTOUR
- EXISTING FENCE
- EXISTING FLAGGED WETLAND LINE
- EXISTING TREE AND DESIGNATION
- 10 FOOT CONTOUR FROM USGS MAPPING (NYSDEC LIMIT OF ADJACENT AREA)
- EXISTING WETLAND SETBACK
- EXISTING SANITARY LINE AND SIZE
- EXISTING WATER LINE
- EXISTING OVERHEAD WRES
- EXISTING MANHOLE
- EXISTING WATER VALVE
- EXISTING UTILITY POLE
- BORING LOCATION AND DESIGNATION

- NOTES:**
- EXISTING CONDITIONS DEPICTED ON THIS PLAN HAVE BEEN TAKEN FROM SURVEY PREPARED BY SPINELLI SURVEYING, DATED 02/22/2016, LAST REVISED 04/23/2020.
 - WETLANDS FLAGGED BY ECOLOGICAL SOLUTIONS L.L.C.
 - THE MEAN LOW WATER BOUNDARY IS BEYOND DRAWING LIMITS TOWARD THE DELANCEY COVE CHANNEL.
 - MEAN HIGH WATER: 3.39'
MEAN HIGHER HIGH WATER: 3.75'
MEAN LOW WATER: -3.90'
MEAN LOWER LOW WATER: -4.14'

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EXISTING CONDITIONS MAP

RESIDENTIAL DEVELOPMENT
1165 GREACEN POINT ROAD
MAMARONECK, NY, 10543

ANY ALTERATION OF PLANS, SPECIFICATIONS, PLATS AND REPORTS BEARING THE SEAL OF A LICENSED PROFESSIONAL ENGINEER OR LICENSED LAND SURVEYOR IS A VIOLATION OF SECTION 7209 OF THE NEW YORK STATE EDUCATION LAW, EXCEPT AS PROVIDED FOR BY SECTION 7209, SUBSECTION 2.

No.	Revision	Date	By
1.	REVISED BUILDING FOOTPRINT	04/11/2019	SPG
2.	UPDATED WETLAND LINES	02/28/2020	RC
3.	UPDATED SURVEY	05/11/2020	RAR
4.	REVISED PER VILLAGE COMMENTS	06/08/2020	RAR
5.	RESUBMIT TO VILLAGE HCZMC	07/01/2020	RAR
Previous Editions Obsolete			

Drawn: **SMN** Approved: **JAR**
Scale: **1" = 20'**
Date: **07/24/2018**
Project No: **18100**
1800-SITE EXIST EXIST.scr
Drawing No: **C-010**










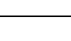

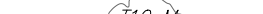


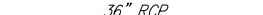
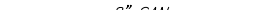





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NOTES:

- EXISTING CONDITIONS DEPICTED ON THIS PLAN HAVE BEEN TAKEN FROM SURVEY PREPARED BY SPINELLI SURVEYING, DATED 02/22/2018, LAST REVISED 04/23/2020.
2. THE CONTRACTOR SHALL VERIFY THE LOCATION OF EXISTING UTILITIES TO BE DEMOLISHED AND EXISTING UTILITIES TO BE PROTECTED. IF ANY DISCREPANCIES ARE IDENTIFIED, THE CONTRACTOR SHALL NOTIFY THE GENERAL CONTRACTOR AND JMC PRIOR TO THE START OF CONSTRUCTION.
3. PRIOR TO THE START OF ANY DEMOLITION THE CONTRACTOR SHALL OBTAIN ALL NECESSARY PERMITS AND/OR APPROVALS FROM THE VILLAGE OF MAMARONECK AND ALL OTHER AUTHORITIES HAVING JURISDICTION. CONTRACTOR SHALL PAY ALL OUTSTANDING FEES, CHARGES, AND DEPOSITS TO ACQUIRE SAID PERMITS. NO CONSTRUCTION SHALL COMMENCE UNTIL A PERMIT HAS BEEN OBTAINED FROM THE VILLAGE.
4. THE CONTRACTOR SHALL COORDINATE THE DISCONNECTION OF ALL UTILITIES WITH THE UTILITY COMPANY HAVING JURISDICTION PRIOR TO THE START OF DEMOLITION. CONFIRMATION OF DISCONNECTED UTILITIES SHALL BE PROVIDED TO THE VILLAGE OF MAMARONECK BUILDING DEPARTMENT IN ACCORDANCE WITH THE REQUIREMENTS. LETTERS FROM THE APPROPRIATE UTILITIES STATING THAT GAS AND ELECTRIC HAVE BEEN CUT OFF SHALL BE PROVIDED TO THE TOWN.
5. ANY UNSUITABLE MATERIAL FOUND ON-SITE DURING DEMOLITION/CONSTRUCTION, AS DETERMINED BY THE PROJECT'S GEOTECHNICAL ENGINEER, SHALL BE PROPERLY DISPOSED OF OFF-SITE IN A MANNER APPROVED BY ALL AUTHORITIES HAVING JURISDICTION AND REPLACED WITH SUITABLE MATERIAL AS REQUIRED.
6. ANY UNSUITABLE MATERIAL FOUND ON-SITE DURING CONSTRUCTION SHALL BE DISPOSED OF OFF-SITE IN A MANNER APPROVED BY ALL AUTHORITIES HAVING JURISDICTION AND REPLACED WITH SUITABLE MATERIAL AS REQUIRED. ALL REMOVAL AND REPLACEMENT OF UNSUITABLE MATERIAL SHALL BE COMPLETED UNDER THE DIRECT SUPERVISION OF A GEOTECHNICAL ENGINEER.
7. ALL DEMOLITION AND/OR CONSTRUCTION WITHIN THE RIGHT-OF-WAY, INCLUDING STREETS AND SIDEWALKS, SHALL BE PERFORMED IN ACCORDANCE WITH THE TOWN.
8. ALL CONSTRUCTION/DEMOLITION DEBRIS NOT PROPOSED TO BE RECYCLED SHALL BE REMOVED AND LEGALLY DISPOSED OF OFF-SITE IN ACCORDANCE WITH THE REGULATIONS OF ALL LOCAL, STATE AND FEDERAL AGENCIES HAVING JURISDICTION.
9. EXISTING CONCRETE MAY BE STORED ON SITE, AND RECYCLED FOR USE AS COMPACTED FILL. ALL MATERIAL TO BE USED AS FILL SHALL BE APPROVED BY THE PROJECT GEOTECHNICAL ENGINEER.
10. PRIOR TO THE START OF SITE DEMOLITION, EROSION AND SEDIMENT CONTROL MEASURES SHALL BE INSTALLED IN ACCORDANCE WITH THIS PLAN, AS REQUIRED AND/OR DIRECTED BY THE VILLAGE OF MAMARONECK OR JMC.
11. EXISTING DRAINAGE PATTERNS ON SITE SHALL BE MAINTAINED TO THE MAXIMUM EXTENT PRACTICABLE.
12. ALL EXISTING SIDEWALKS, CURBS, PAVEMENT, ETC. TO REMAIN, WHICH ARE DISTURBED OR DAMAGED DUE TO THE NEW CONSTRUCTION, ARE TO BE REPLACED WITH MATERIALS CONSISTENT WITH EXISTING CONDITIONS.
13. THESE PLANS ARE TO BE PROVIDED TO BOTH THE VILLAGE OF MAMARONECK CONTRACTOR AND THE SITE CONTRACTOR FOR THEIR USE, INFORMATION AND COORDINATION. ANY QUESTIONS OF CONTRACTOR RESPONSIBILITY AND/OR SEPARATION OF WORK SHALL BE DIRECTED TO THE GENERAL CONTRACTOR IN WRITING PRIOR TO ISSUANCE OF BID.
14. THE OWNER SHALL RETAIN A LICENSED AND QUALIFIED PROFESSIONAL, CERTIFIED BY THE TOWN TO INSPECT AND SUPERVISE THE DEMOLITION OF ASBESTOS AND LEAD. THE OWNER SHALL RETAIN THE DEMOLITION CONTRACTOR TO THE PROJECT TO OBTAIN THE CERTIFICATION OF DEMOLITION. IF REMEDIATION IS REQUIRED, THE OWNER SHALL DO SO IN ACCORDANCE WITH THE COUNTY ASBESTOS RULES AND REGULATIONS AND/OR ANY OTHER AGENCIES HAVING JURISDICTION. THE CONTRACTOR SHALL PROVIDE ALL REQUIRED DOCUMENTATION TO THE TOWN PRIOR TO OBTAINING A DEMOLITION PERMIT.
15. PRIOR TO COMMENCEMENT OF DEMOLITION, THE CONTRACTOR MUST PROVIDE 24-HOUR NOTIFICATION TO THE TOWN.

LEGEND

- | | |
|---|------------------------------------|
|  | EXISTING PROPERTY LINE |
|  | ADJACENT PROPERTY LINE |
|  | EXISTING EASEMENT LINE |
|  | EXISTING BUILDING LINE |
|  | EXISTING PAVEMENT EDGE |
|  | EXISTING CURB LINE |
|  | EXISTING CONTOUR |
|  | EXISTING INDEX CONTOUR |
|  | EXISTING FENCE |
|  | EXISTING TREE AND DESIGNATION |
|  | EXISTING TREE TO BE REMOVED |
|  | EXISTING WETLAND SETBACK |
|  | EXISTING STORM DRAIN LINE AND SIZE |
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|  | EXISTING OVERHEAD WIRES |
|  | EXISTING MANHOLE |
|  | EXISTING WATER VALVE |
|  | EXISTING UTILITY POLE |
|  | BORING LOCATION AND DESIGNATION |
|  | EXISTING FEATURE TO BE REMOVED |

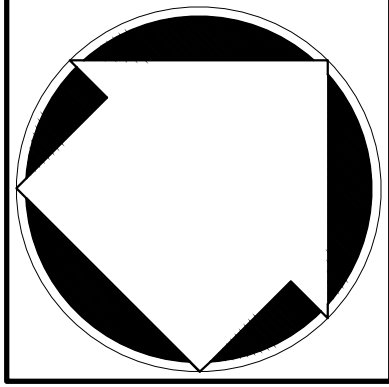
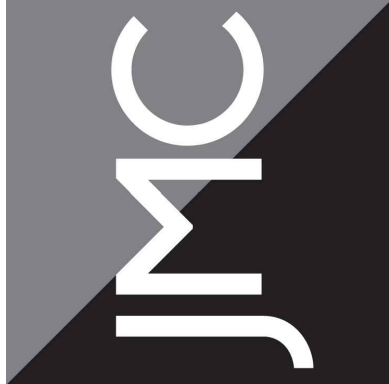
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5.	RESUBMIT TO VILLAGE HCZMC	07/01/2020	RAR
	<i>Previous Editions Obsolete</i>		

APPLICANT/OWNER: **MR. WILLIAM FEDYNA & ELISABETH FEDYNA**
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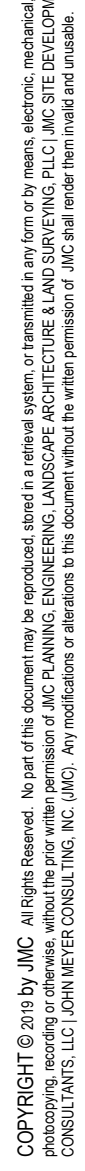
**JMC Planning, Engineering, Landscape
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20 BEDFORD ROAD • ARMONK, NY 10504
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DEMOLITION AND
TREE REMOVAL PLAN

RESIDENTIAL DEVELOPMENT
1165 GREACEN POINT ROAD
MAMARONECK, NY, 10543

Drawn:	SMN	Approved:	JAR
Scale:	1" = 20'		
Date:	07/24/2018		
Project No:	18100		
18100-SITE	DEMO	DEMO.scr	
Drawing No:			

C-020



NOTES:

1. EXISTING CONDITIONS DEPICTED ON THIS PLAN HAVE BEEN TAKEN FROM SURVEY PREPARED BY SPINELLI SURVEYING, DATED 02/22/2018, LAST REVISED 04/23/2020.

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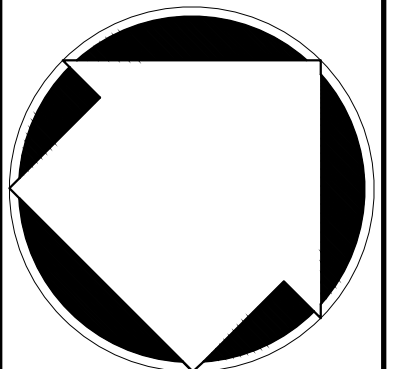
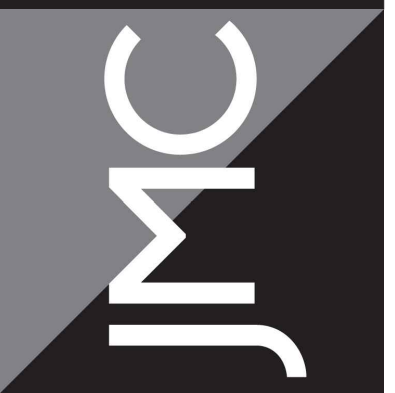
APPLICATION OWNER: MR. WILLIAM FEDYNA & ELISABETH FEDYNA 219 W 81ST STREET, APT. 9D NEW YORK, NY, 10024	ARCHITECT: ARCHI—TECTONICS 111 JOHN ST. #700 NEW YORK, NY 10038
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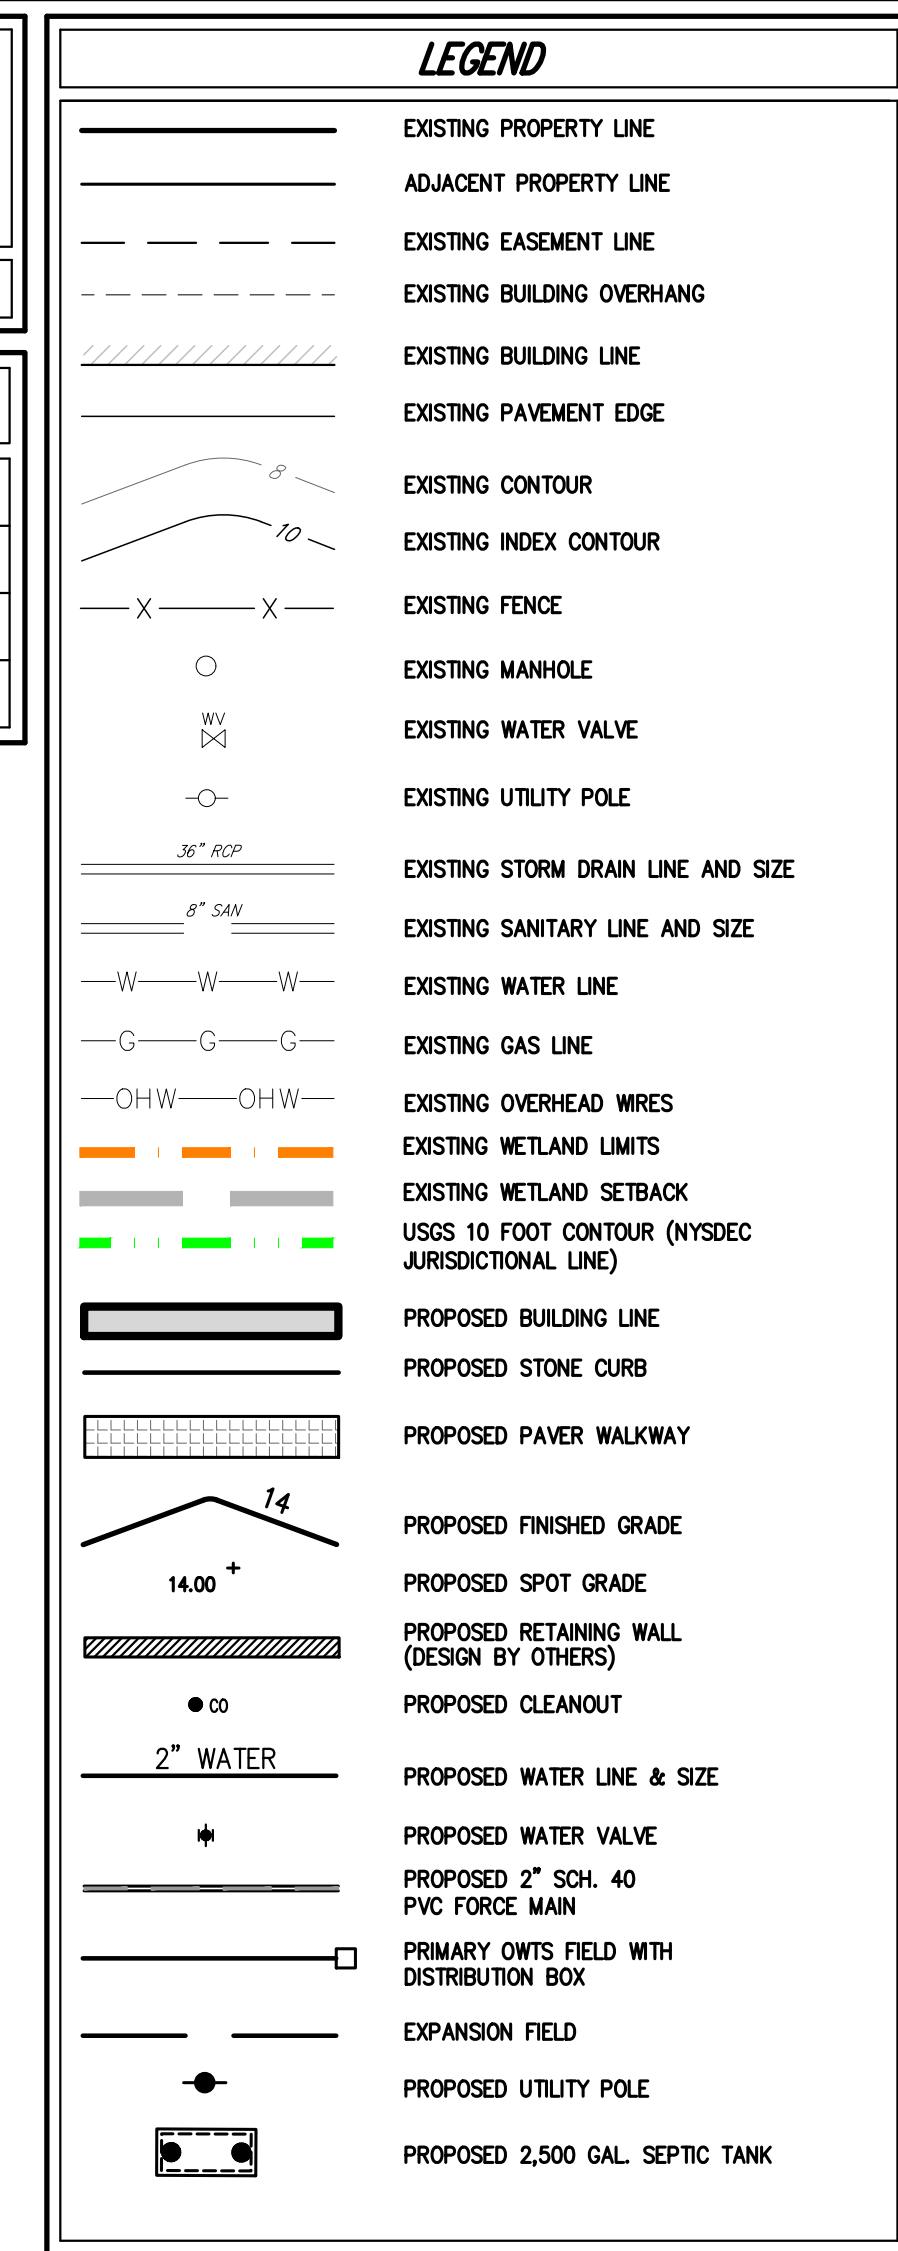
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LAYOUT PLAN	RESIDENTIAL DEVELOPMENT 1165 GREACEN POINT ROAD MAMARONECK, NY, 10543
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the 1990s, the number of people in the United States who are 65 years of age or older has increased by 50 percent. The number of people 75 years of age or older has increased by 100 percent. The number of people 85 years of age or older has increased by 200 percent. The number of people 95 years of age or older has increased by 400 percent. The number of people 100 years of age or older has increased by 1,000 percent. The number of people 105 years of age or older has increased by 2,000 percent. The number of people 110 years of age or older has increased by 4,000 percent. The number of people 115 years of age or older has increased by 8,000 percent. The number of people 120 years of age or older has increased by 16,000 percent. The number of people 125 years of age or older has increased by 32,000 percent. The number of people 130 years of age or older has increased by 64,000 percent. The number of people 135 years of age or older has increased by 128,000 percent. The number of people 140 years of age or older has increased by 256,000 percent. The number of people 145 years of age or older has increased by 512,000 percent. The number of people 150 years of age or older has increased by 1,024,000 percent. The number of people 155 years of age or older has increased by 2,048,000 percent. The number of people 160 years of age or older has increased by 4,096,000 percent. The number of people 165 years of age or older has increased by 8,192,000 percent. The number of people 170 years of age or older has increased by 16,384,000 percent. The number of people 175 years of age or older has increased by 32,768,000 percent. The number of people 180 years of age or older has increased by 65,536,000 percent. The number of people 185 years of age or older has increased by 131,072,000 percent. The number of people 190 years of age or older has increased by 262,144,000 percent. The number of people 195 years of age or older has increased by 524,288,000 percent. The number of people 200 years of age or older has increased by 1,048,576,000 percent. The number of people 205 years of age or older has increased by 2,097,152,000 percent. The number of people 210 years of age or older has increased by 4,194,304,000 percent. The number of people 215 years of age or older has increased by 8,388,608,000 percent. The number of people 220 years of age or older has increased by 16,777,216,000 percent. The number of people 225 years of age or older has increased by 33,554,432,000 percent. The number of people 230 years of age or older has increased by 67,108,864,000 percent. The number of people 235 years of age or older has increased by 134,217,728,000 percent. The number of people 240 years of age or older has increased by 268,435,456,000 percent. The number of people 245 years of age or older has increased by 536,870,912,000 percent. The number of people 250 years of age or older has increased by 1,073,741,824,000 percent. The number of people 255 years of age or older has increased by 2,147,483,648,000 percent. The number of people 260 years of age or older has increased by 4,294,967,296,000 percent. The number of people 265 years of age or older has increased by 8,589,934,592,000 percent. The number of people 270 years of age or older has increased by 17,179,869,184,000 percent. The number of people 275 years of age or older has increased by 34,359,738,368,000 percent. The number of people 280 years of age or older has increased by 68,719,476,736,000 percent. The number of people 285 years of age or older has increased by 137,438,953,472,000 percent. The number of people 290 years of age or older has increased by 274,877,906,944,000 percent. The number of people 295 years of age or older has increased by 549,755,813,888,000 percent. The number of people 300 years of age or older has increased by 1,099,511,627,776,000 percent. The number of people 305 years of age or older has increased by 2,199,023,255,552,000 percent. The number of people 310 years of age or older has increased by 4,398,046,511,104,000 percent. The number of people 315 years of age or older has increased by 8,796,093,022,208,000 percent. The number of people 320 years of age or older has increased by 17,592,186,044,416,000 percent. The number of people 325 years of age or older has increased by 35,184,372,088,832,000 percent. The number of people 330 years of age or older has increased by 70,368,744,177,664,000 percent. The number of people 335 years of age or older has increased by 140,737,488,355,328,000 percent. The number of people 340 years of age or older has increased by 281,474,976,710,656,000 percent. The number of people 345 years of age or older has increased by 562,949,953,421,312,000 percent. The number of people 350 years of age or older has increased by 1,125,899,906,842,624,000 percent. The number of people 355 years of age or older has increased by 2,251,799,813,685,248,000 percent. The number of people 360 years of age or older has increased by 4,503,599,627,370,496,000 percent. The number of people 365 years of age or older has increased by 9,007,199,254,740,992,000 percent. The number of people 370 years of age or older has increased by 18,014,398,509,481,984,000 percent. The number of people 375 years of age or older has increased by 36,028,797,018,963,968,000 percent. The number of people 380 years of age or older has increased by 72,057,594,037,927,936,000 percent. The number of people 385 years of age or older has increased by 144,115,188,075,855,872,000 percent. The number of people 390 years of age or older has increased by 288,230,376,151,711,744,000 percent. The number of people 395 years of age or older has increased by 576,460,752,303,423,488,000 percent. The number of people 400 years of age or older has increased by 1,152,921,504,606,846,976,000 percent. The number of people 405 years of age or older has increased by 2,305,843,009,213,693,952,000 percent. The number of people 410 years of age or older has increased by 4,611,686,018,427,387,904,000 percent. The number of people 415 years of age or older has increased by 9,223,372,036,854,775,808,000 percent. The number of people 420 years of age or older has increased by 18,446,744,073,709,551,616,000 percent. The number of people 425 years of age or older has increased by 36,893,488,147,419,103,232,000 percent. The number of people 430 years of age or older has increased by 73,786,976,294,838,206,464,000 percent. The number of people 435 years of age or older has increased by 147,573,952,589,676,412,928,000 percent. The number of people 440 years of age or older has increased by 295,147,905,179,352,825,856,000 percent. The number of people 445 years of age or older has increased by 590,295,810,358,705,651,712,000 percent. The number of people 450 years of age or older has increased by 1,180,591,620,717,411,303,424,000 percent. The number of people 455 years of age or older has increased by 2,361,183,241,434,822,606,848,000 percent. The number of people 460 years of age or older has increased by 4,722,366,482,869,645,213,696,000 percent. The number of people 465 years of age or older has increased by 9,444,732,965,739,290,427,392,000 percent. The number of people 470 years of age or older has increased by 18,889,465,931,478,580,854,784,000 percent. The number of people 475 years of age or older has increased by 37,778,931,862,957,161,709,568,000 percent. The number of people 480 years of age or older has increased by 75,557,863,725,914,323,419,136,000 percent. The number of people 485 years of age or older has increased by 151,115,727,451,828,646,838,272,000 percent. The number of people 490 years of age or older has increased by 302,231,454,903,657,293,676,544,000 percent. The number of people 495 years of age or older has increased by 604,462,909,807,314,587,353,088,000 percent. The number of people 500 years of age or older has increased by 1,208,925,819,614,629,174,706,176,000 percent. The number of people 505 years of age or older has increased by 2,417,851,639,229,258,349,412,352,000 percent. The number of people 510 years of age or older has increased by 4,835,703,278,458,516,698,824,704,000 percent. The number of people 515 years of age or older has increased by 9,671,406,556,917,033,397,649,408,000 percent. The number of people 520 years of age or older has increased by 19,342,813,113,834,066,795,298,816,000 percent. The number of people 525 years of age or older has increased by 38,685,626,227,668,133,590,597,632,000 percent. The number of people 530 years of age or older has increased by 77,371,252,455,336,267,181,195,264,000 percent. The number of people 535 years of age or older has increased by 154,742,504,910,672,534,362,390,528,000 percent. The number of people 540 years of age or older has increased by 309,485,009,821,345,068,724,781,056,000 percent. The number of people 545 years of age or older has increased by 618,970,019,642,690,137,449,562,112,000 percent. The number of people 550 years of age or older has increased by 1,237,940,039,285,380,274,899,124,224,000 percent. The number of people 555 years of age or older has increased by 2,475,880,078,570,760,549,798,248,448,000 percent. The number of people 560 years of age or older has increased by 4,951,760,157,141,521,099,596,496,896,000 percent. The number of people 565 years of age or older has increased by 9,903,520,314,283,042,199,193,993,792,000 percent. The number of people 570 years of age or older has increased by 19,807,040,628,566,084,398,387,9

Drawn:	SMN	Approved:	JAR
Scale:	1" = 20'		
Date:	07/24/2018		
Project No:	18100		
18100-SITE	LAYOUT	LAY.scr	
Drawing No:			
C-100			



- ANY ALTERATION OF PLANS, SPECIFICATIONS, PLATS AND REPORTS BEARING THE SEAL OF A LICENSED PROFESSIONAL ENGINEER OR LICENSED LAND SURVEYOR IS A VIOLATION OF SECTION 7209 OF THE NEW YORK STATE EDUCATION LAW, EXCEPT AS PROVIDED FOR BY SECTION 7209, SUBSECTION 2.

Drawn: SMN		Approved: JAR	
Scale: 1" = 20'			
Date: 07/24/2018			
Project No: 18100			
18100-SITE	GRAD UTIL	GRADUTIL.scr	
Drawing No:			
C-200			

**1165 GREACEN POINT RD.
FILED MAP PLOT 10
SBL: 9-50-373
47,560.5 S.F.**

**LOCATION OF FLAGGED WETLAND
AS DELINEATED BY ECOLOGICAL
SOLUTIONS, LLC**

**10 FOOT CONTOUR (LIMIT OF NYSDEC
JURISDICTION)**

**PROPOSED LIMIT
OF DISTURBANCE
(TYP. - 27,372± S.F.)**

**PROPOSED RESIDENCE
FFE 16.00**

**PROPOSED THREE-CAR
GARAGE
FFE 13.00**

**PROPOSED SANITARY
CLEAN OUT**

**1,250 GAL. SEPTIC TANK
TOP 13.5'
INV. IN 12.0'
INV. OUT 11.75'**

**4" SDR-35 PVC
FUJI CLEAN MODEL CE10
ENHANCED TREATMENT UNIT
(900 GPD RATING)
TOP 13.25
INV. 11.50 (IN)
INV. 11.34 (OUT)**

**PROPOSED 4" SDR-35
PVC @ 1.00%**

**LIMITS OF BANK SAND AND
GRAVEL FILL MATERIAL**

**PROPOSED PRIMARY OWTS
(500 LF PROVIDED) PROVIDE
MINIMUM 2' RUN OF BANK SAND
AND GRAVEL FILL MATERIAL**

DISTRIBUTION BOX (TYP.)

**LIMITS OF IMPERVIOUS
CLAY FILL**

**PROPOSED 100% EXPANSION AREA
(500 LF OF ABSORPTION TRENCH)
APPLICANT IS REQUESTING A FILL
WAIVER FOR THE EXPANSION AREA**

**PROPOSED TREE WELL,
CONSTRUCTED FROM ON
SITE BOULDERS (TYPICAL)**

PROPOSED GAS SERVICE RELOCATION

**CONNECT TO EXISTING UTILITY POLE IN
ACCORDANCE WITH CONSOLIDATED EDISON
COMPANY OF NEW YORK (CON ED)
REQUIREMENTS**

**EXISTING WATER TO BE ABANDONED IN
ACCORDANCE WITH WESTCHESTER JOINT
WATER WORKS REGULATIONS**

**APPROXIMATE LOCATION OF
EXISTING DOCK TO REMAIN**

**END SECTION
INV. 7.75 (12")**

27 L.F. 12" HDPE @ 0.62%

46 L.F. 6" HDPE @ 0.54%

**OCS
TOP 12.50
INV. 8.80 (12" IN)
INV. 8.80 (3" ORIFICE)
INV. 10.60 (4' WEIR)
INV. 7.92 (12" OUT)**

5 L.F. 6" HDPE @ 2.00%

5 L.F. 6" HDPE @ 2.00%

**TW 7.00
BW 7.00
PROPOSED 5,700 GALLON
RAINFALL HARVESTING TANK
INV. 9.00 (12")**

6 L.F. 12" HDPE @ 0.56%

**TW 11.00
BW 7.00**

**DI-2
TOP 12.20
INV. 9.10**

**TW 12.25
BW 7.00**

**PROPOSED SUBSURFACE DETEN
SYSTEM WITH IMPERVIOUS LINE
BOTTOM OF SYSTEM @ ELEV. 8.0
(1,260 PERMAVOID PV-150 UN
21 UNITS WIDE X 15 UNITS LO**

**TW 12.25
BW 8.00**

**DI-2
TOP 12.25
INV. 9.27**

**TW 12.25
BW 8.50**

32 L.F. 12" HDPE @ 0.50%

**TW 11.25
BW 9.50**

**PROPOSED RETAINING WALL
(DESIGN BY OTHERS)**

**DI-1
TOP 11.40
INV. 9.43**

**TW 10.50
BW 10.00**

**PROPOSED ELECTRIC, TELEPHONE,
AND CABLE SERVICE**

2" METER PIT

**PROPOSED 2" WATER
SERVICE**

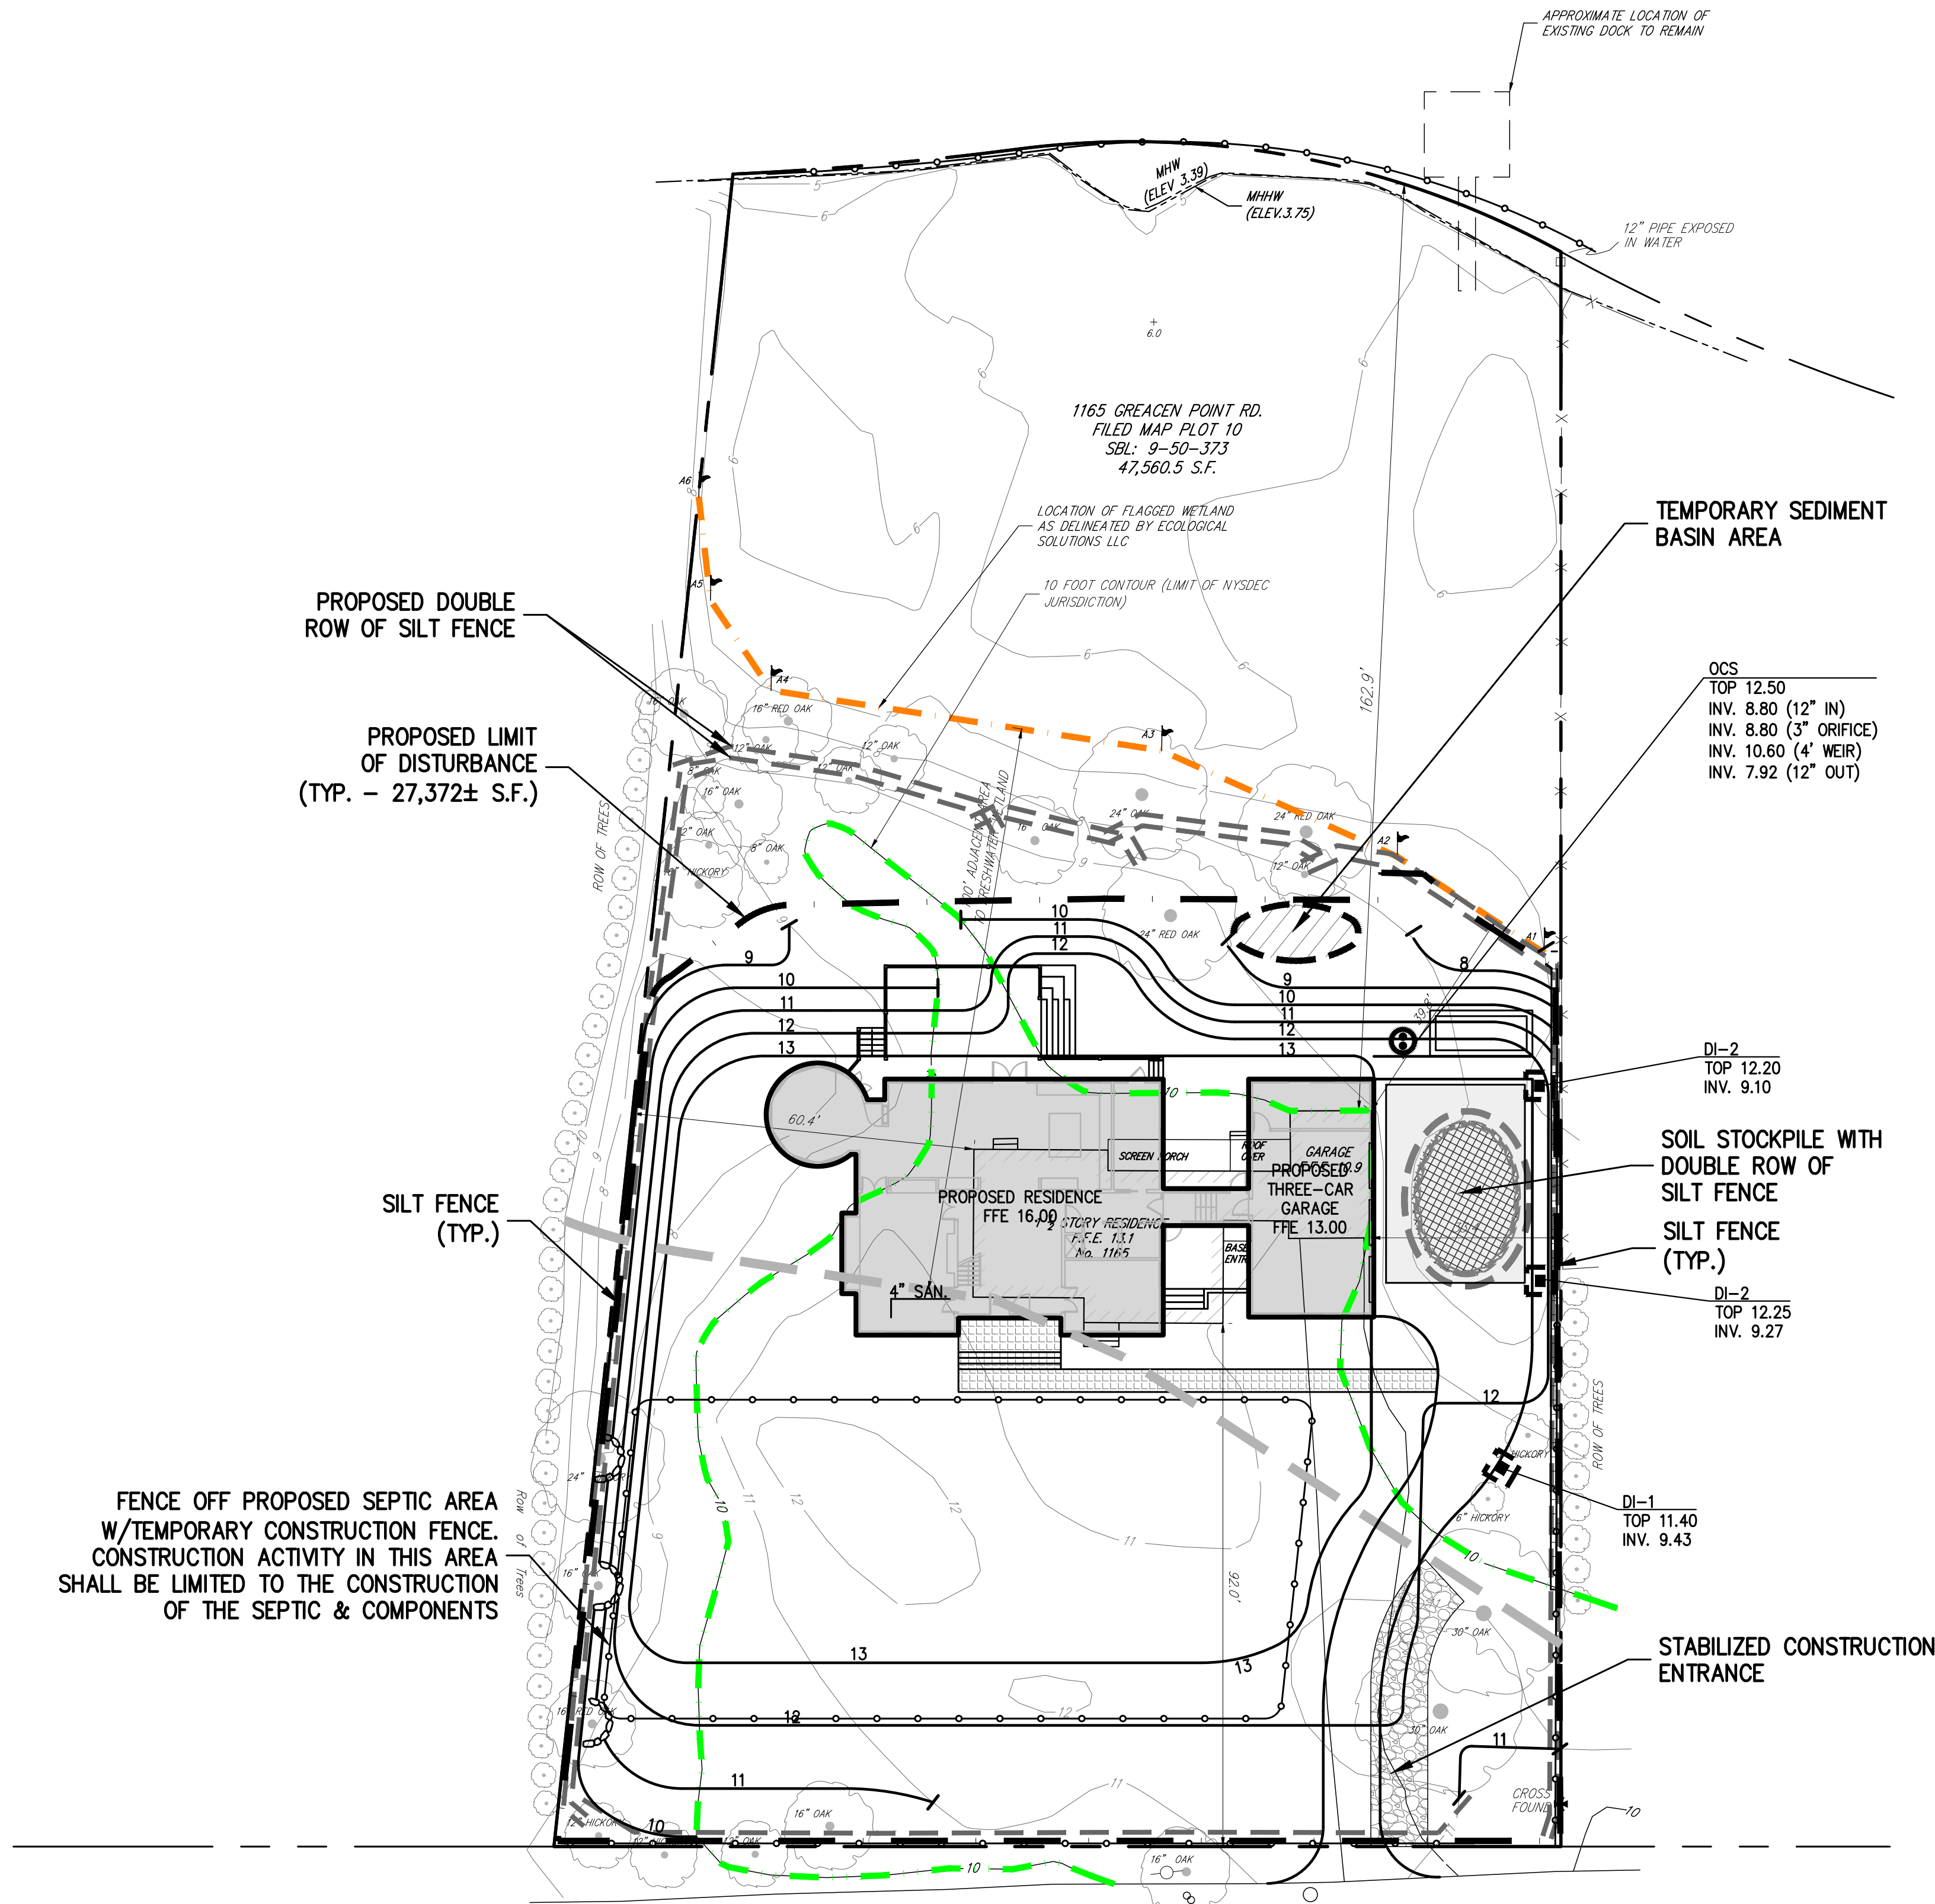
CROSS FOUND

Private Sewer Line

FEMA ZONE AE13

FEMA ZONE VE14

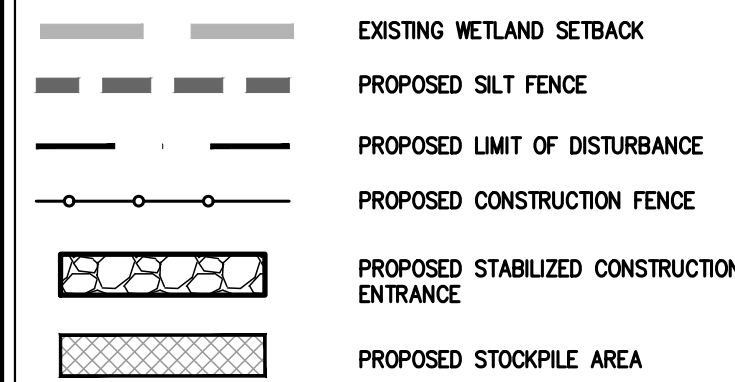
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NOTES:

- EXISTING CONDITIONS DEPICTED ON THIS PLAN HAVE BEEN TAKEN FROM SURVEY PREPARED BY SPINELLI SURVEYING, DATED 02/22/2018, LAST REVISED 04/23/2020.
- THIS PLAN IS FOR TEMPORARY EROSION AND SEDIMENT CONTROL INFORMATION ONLY.
- PRIOR TO BEGINNING ANY CLEARING, GRUBBING OR EXCAVATION, ALL EROSION AND SEDIMENT CONTROL MEASURES SHALL BE INSTALLED IN ACCORDANCE WITH ALL THE PLANS AND SPECIFICATIONS. EROSION AND SEDIMENT CONTROL MEASURES SHALL BE MAINTAINED UNTIL THE SITE IS STABILIZED. FINAL STABILIZATION OF LANDSCAPED AREAS SHALL BE IN ACCORDANCE WITH THE LANDSCAPE PLAN.
- THE CONTRACTOR SHALL INSPECT AND MAINTAIN ON-SITE EROSION AND SEDIMENT CONTROL MEASURES ON A DAILY BASIS. ALL COLLECTED SEDIMENT WITHIN SEDIMENT BARRIERS SHALL BE REMOVED PERIODICALLY AS REQUIRED TO MAINTAIN THE FUNCTION OF THE SEDIMENT BARRIERS. ALL SEDIMENT COLLECTED SHALL BE RESPAID ON-SITE WITHIN STABILIZED AREAS AS DIRECTED BY THE OWNERS REPRESENTATIVE.
- THE CONTRACTOR SHALL INSPECT DOWNSTREAM CONDITIONS FOR EVIDENCE OF SEDIMENTATION ON A WEEKLY BASIS, AFTER EACH RAINSTORM, AND AS MAY BE REQUIRED OR DIRECTED BY ALL APPLICABLE APPROVALS AND PERMITS. THE CONTRACTOR SHALL IMMEDIATELY PROVIDE A WRITTEN REPORT ON FINDINGS OF SEDIMENT IN DOWNSTREAM AREAS TO ALL AUTHORITIES HAVING JURISDICTION AND MAKE REPAIRS AS REQUIRED OR DIRECTED.
- ADDITIONAL EROSION AND SEDIMENT CONTROL MEASURES SHALL BE INSTALLED BY THE CONTRACTOR AS REQUIRED/WARRANTED BY FIELD CONDITIONS AND AS DIRECTED BY THE OWNERS REPRESENTATIVE, JMC, AND/OR ANY AUTHORITY HAVING JURISDICTION.
- STOCKPILING OF CONSTRUCTION MATERIAL SHALL BE PLACED ON-SITE IN THE AREA DESIGNATED ON THIS PLAN OR AS APPROVED BY THE OWNERS REPRESENTATIVE. STOCKPILED EXCAVATED MATERIAL SHALL HAVE TWO ROWS OF SILT FENCE LOCATED AROUND ITS PERIMETER. ALL STOCKPILED MATERIAL SHALL BE MAINTAINED IN AN ORDERLY MANNER SO AS NOT TO IMPEDE ON PEDESTRIAN AND/OR VEHICULAR TRAFFIC CIRCULATION ROUTES.
- DUST SHALL BE CONTROLLED BY SPRINKLING OR OTHER APPROVED METHODS AS NECESSARY, OR AS DIRECTED BY THE OWNERS REPRESENTATIVE.
- ALL STORMWATER MANAGEMENT PRACTICES SHALL REMAIN UNDISTURBED AND BE PROTECTED FROM HEAVY MACHINERY TRAFFIC DURING CONSTRUCTION. HOWEVER DURING CONSTRUCTION OF THE PRACTICE THE CONTRACTOR SHALL MINIMIZE AND AVOID HEAVY MACHINERY TRAFFIC TO THE MAXIMUM EXTENT PRACTICABLE. THERE SHALL BE NO STORAGE OF MATERIALS WITHIN AREAS TO BE USED FOR STORMWATER MANAGEMENT PRACTICES. THE CONTRACTOR SHALL INSTALL CONSTRUCTION FENCE AROUND THE PRACTICE TO DISCOURAGE VEHICLE TRAFFIC.
- ALL EXPOSED SLOPES AND GRADED/DISTURBED AREAS, THAT WILL NOT BE FURTHER DISTURBED WITHIN 14 CALENDAR DAYS (7 DAYS FOR CONSTRUCTION SITES THAT EITHER DIRECTLY DISCHARGE TO ONE OF THE 303(d) SEGMENTS LISTED IN APPENDIX E OF THE GENERAL PERMIT OR ARE LOCATED WITHIN ONE OF THE WATERSHEDS LISTED IN APPENDIX C OF THE GENERAL PERMIT), SHALL BE TEMPORARILY SEEDED WITHIN 24 HOURS OF DISTURBANCE, IN ACCORDANCE WITH THE NEW YORK STATE DEPARTMENT OF ENVIRONMENTAL CONSERVATION (NYSDEC) "EROSION AND SEDIMENT CONTROL GUIDELINES" AND THE ANSI A300 "BEST MANAGEMENT PRACTICES FOR TREE AND SHRUB PLANTING, TRANSPLANTING, MAINTENANCE AND CARE," PREPARED BY THE INTERNATIONAL SOCIETY OF ARBORICULTURE (ISA), LATEST EDITIONS, AS FOLLOWS:
A. SEED MIXTURE AND RATE OF APPLICATION:
A.1. IN SPRING, SUMMER OR EARLY FALL, SEED THE AREA WITH RYEGRASS (ANNUAL OR PERENNIAL) AT 30 POUNDS PER ACRE (APPROXIMATELY 0.7 POUNDS/1000 SQUARE FEET OR USE 1 POUND/1000 SQUARE FEET).
A.2. IN LATE FALL OR EARLY WINTER, SEED THE AREA WITH CERTIFIED "AROSTOOK" WINTER RYE (CEREAL RYE) AT 100 POUNDS PER ACRE (2.5 POUNDS/1000 SQUARE FEET).
B. APPLICATION SHALL BE UNIFORM BY MECHANICAL OR HYDROSEED METHODS.
C. MULCH ALL SEEDED AREAS WITH STRAW AT A RATE OF 2 TONS PER ACRE (90 POUNDS PER 1,000 SQUARE FEET) SUCH THAT THE MULCH FORMS A CONTINUOUS BLANKET.
- ALL SEEDED AREAS SHALL BE FERTILIZED, RESEED, AND MULCHED AS NECESSARY TO MAINTAIN VIGOROUS, DENSE VEGETATIVE COVER.
- TEMPORARY SEED MIXTURES SHALL NOT BE PLACED ON AREAS WHERE FINAL GRADE HAS BEEN ESTABLISHED AND TOPSOIL HAS BEEN PLACED UNLESS OTHERWISE DIRECTED BY THE PROJECT LANDSCAPE ARCHITECT.

LEGEND

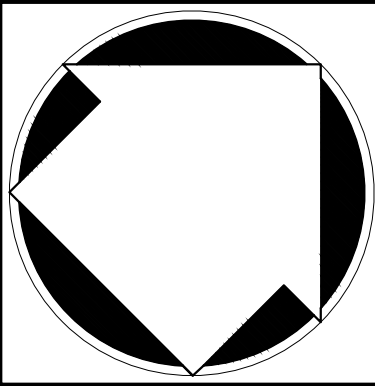
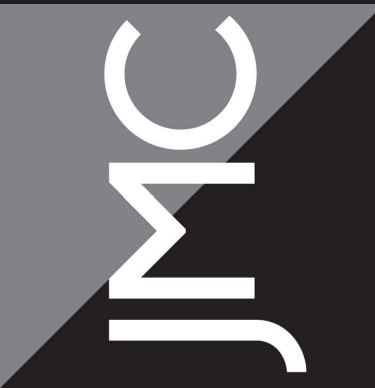


SEQUENCE OF CONSTRUCTION

- CONSTRUCTION SHALL BE SEQUENCED IN SUCH A MANNER THAT ANY AREA WHICH IS DISTURBED SHALL FIRST BE PROTECTED WITH SEDIMENT EROSION CONTROLS AS INDICATED ON THIS PLAN. PARTICULAR REQUIREMENTS ARE GIVEN AS FOLLOWS:
- DEMOLITION OF EXISTING BUILDINGS AS REQUIRED.
 - INSTALLATION OF SEDIMENT AND EROSION CONTROL MEASURES AS INDICATED ON THIS PLAN.
 - CLEAR UNDEVELOPED PORTION OF PROPERTY WHICH IS TO BE DEVELOPED.
 - STRIP AND STOCKPILE TOPSOIL.
 - BEGIN BUILDING AND PARKING LOT CONSTRUCTION, ROUGH GRADING.
 - INSTALL STORM DRAIN SYSTEM COMPLETE (IMMEDIATELY INSTALL HAYBALE FILTERS ON ALL INLETS).
 - INSTALL PUBLIC UTILITIES (GAS, ELECTRIC AND TELEPHONE) AS REQUIRED.
 - INSTALL CONCRETE AND ASPHALT CONCRETE PAVEMENT COMPLETE.
 - FINISH GRADING, REDISTRIBUTE TOPSOIL AND ESTABLISH VEGETATION AND/OR LANDSCAPING.
 - CLEAN PAVEMENTS AND STORM DRAIN SYSTEM OF ALL ACCUMULATED SEDIMENT IN CONJUNCTION WITH THE REMOVAL OF ALL TEMPORARY SEDIMENT AND EROSION CONTROL DEVICES.
 - COMPLETE SITE AND BUILDING CONSTRUCTION.

APPLICANT/OWNER: **MR. WILLIAM FEDYNA & ELISABETH FEDYNA**
219 W 81ST STREET, APT. 9D
NEW YORK, NY, 10024
ARCHITECT: **ARCHI-TECTONICS**
111 JOHN ST. #700
NEW YORK, NY 10038

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JMC Site Development Consultants, LLC
John Meyer Consulting, Inc.
120 BEDFORD ROAD - ARMONK, NY 10504
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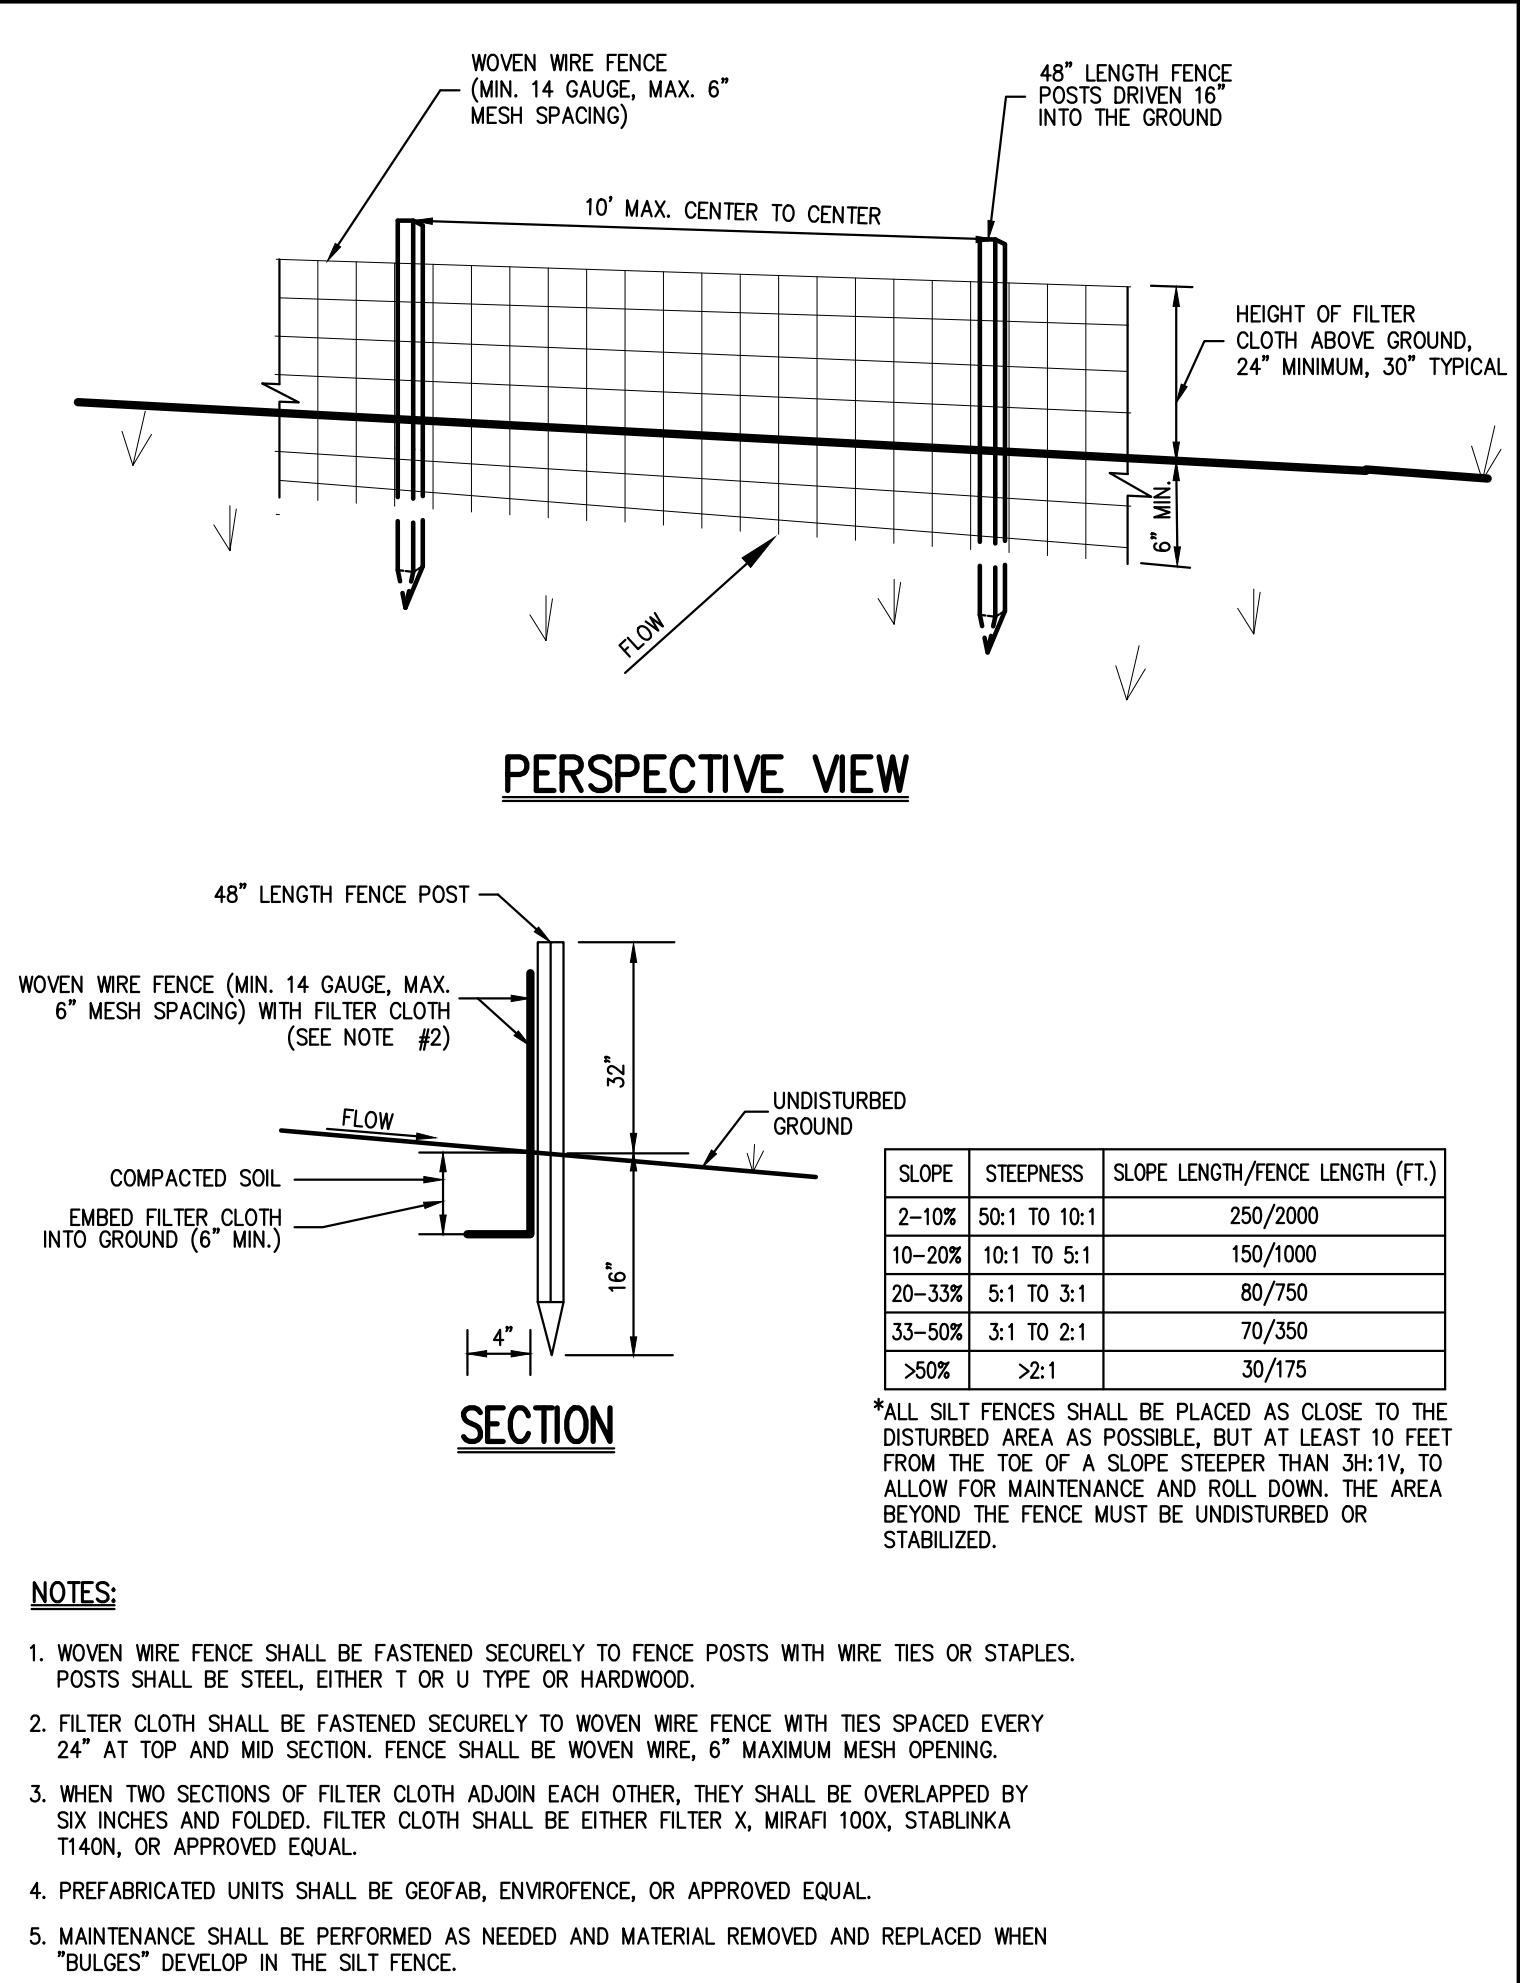
EROSION & SEDIMENT CONTROL PLAN
RESIDENTIAL DEVELOPMENT
1165 GREACEN POINT ROAD
MAMARONECK, NY, 10543

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No.	Revision	Date	By
1.	REVISED BUILDING FOOTPRINT	04/11/2019	SPG
2.	UPDATED WETLAND LINES	02/28/2020	RC
3.	UPDATED SURVEY	05/11/2020	RAR
4.	REVISED PER VILLAGE COMMENTS	06/08/2020	RAR
5.	RESUBMIT TO VILLAGE HCZMC	07/01/2020	RAR
Previous Editions Obsolete			

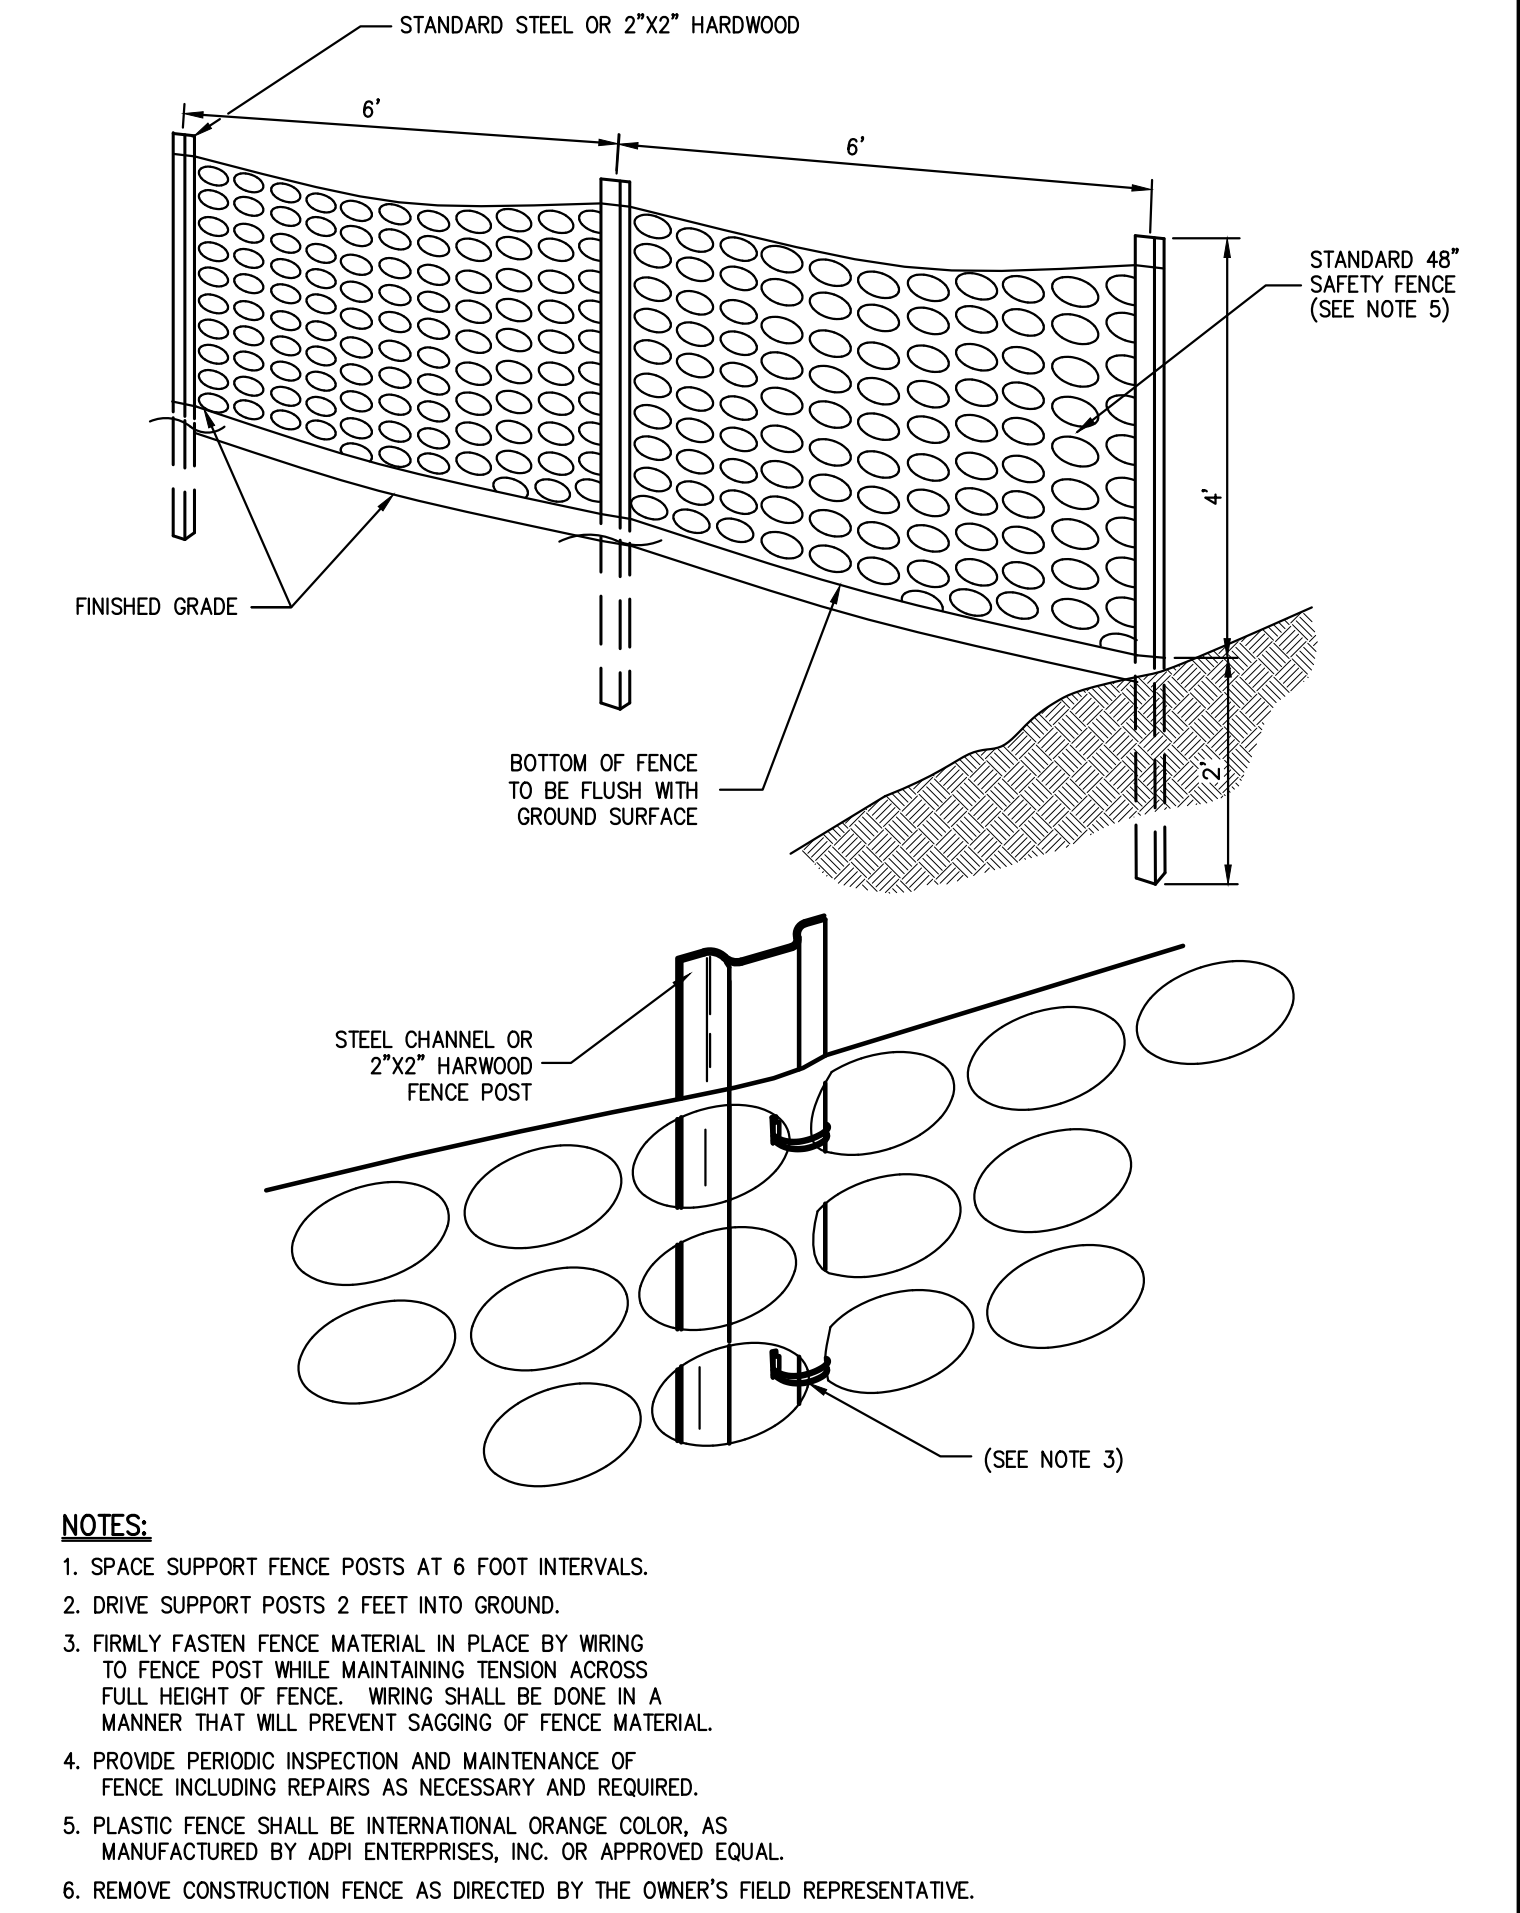
Drawn: **SMN** Approved: **JAR**
Scale: **1" = 20'**
Date: **07/24/2018**
Project No: **18100**
1800-SITE SE SE.scr
Drawing No: **C-300**

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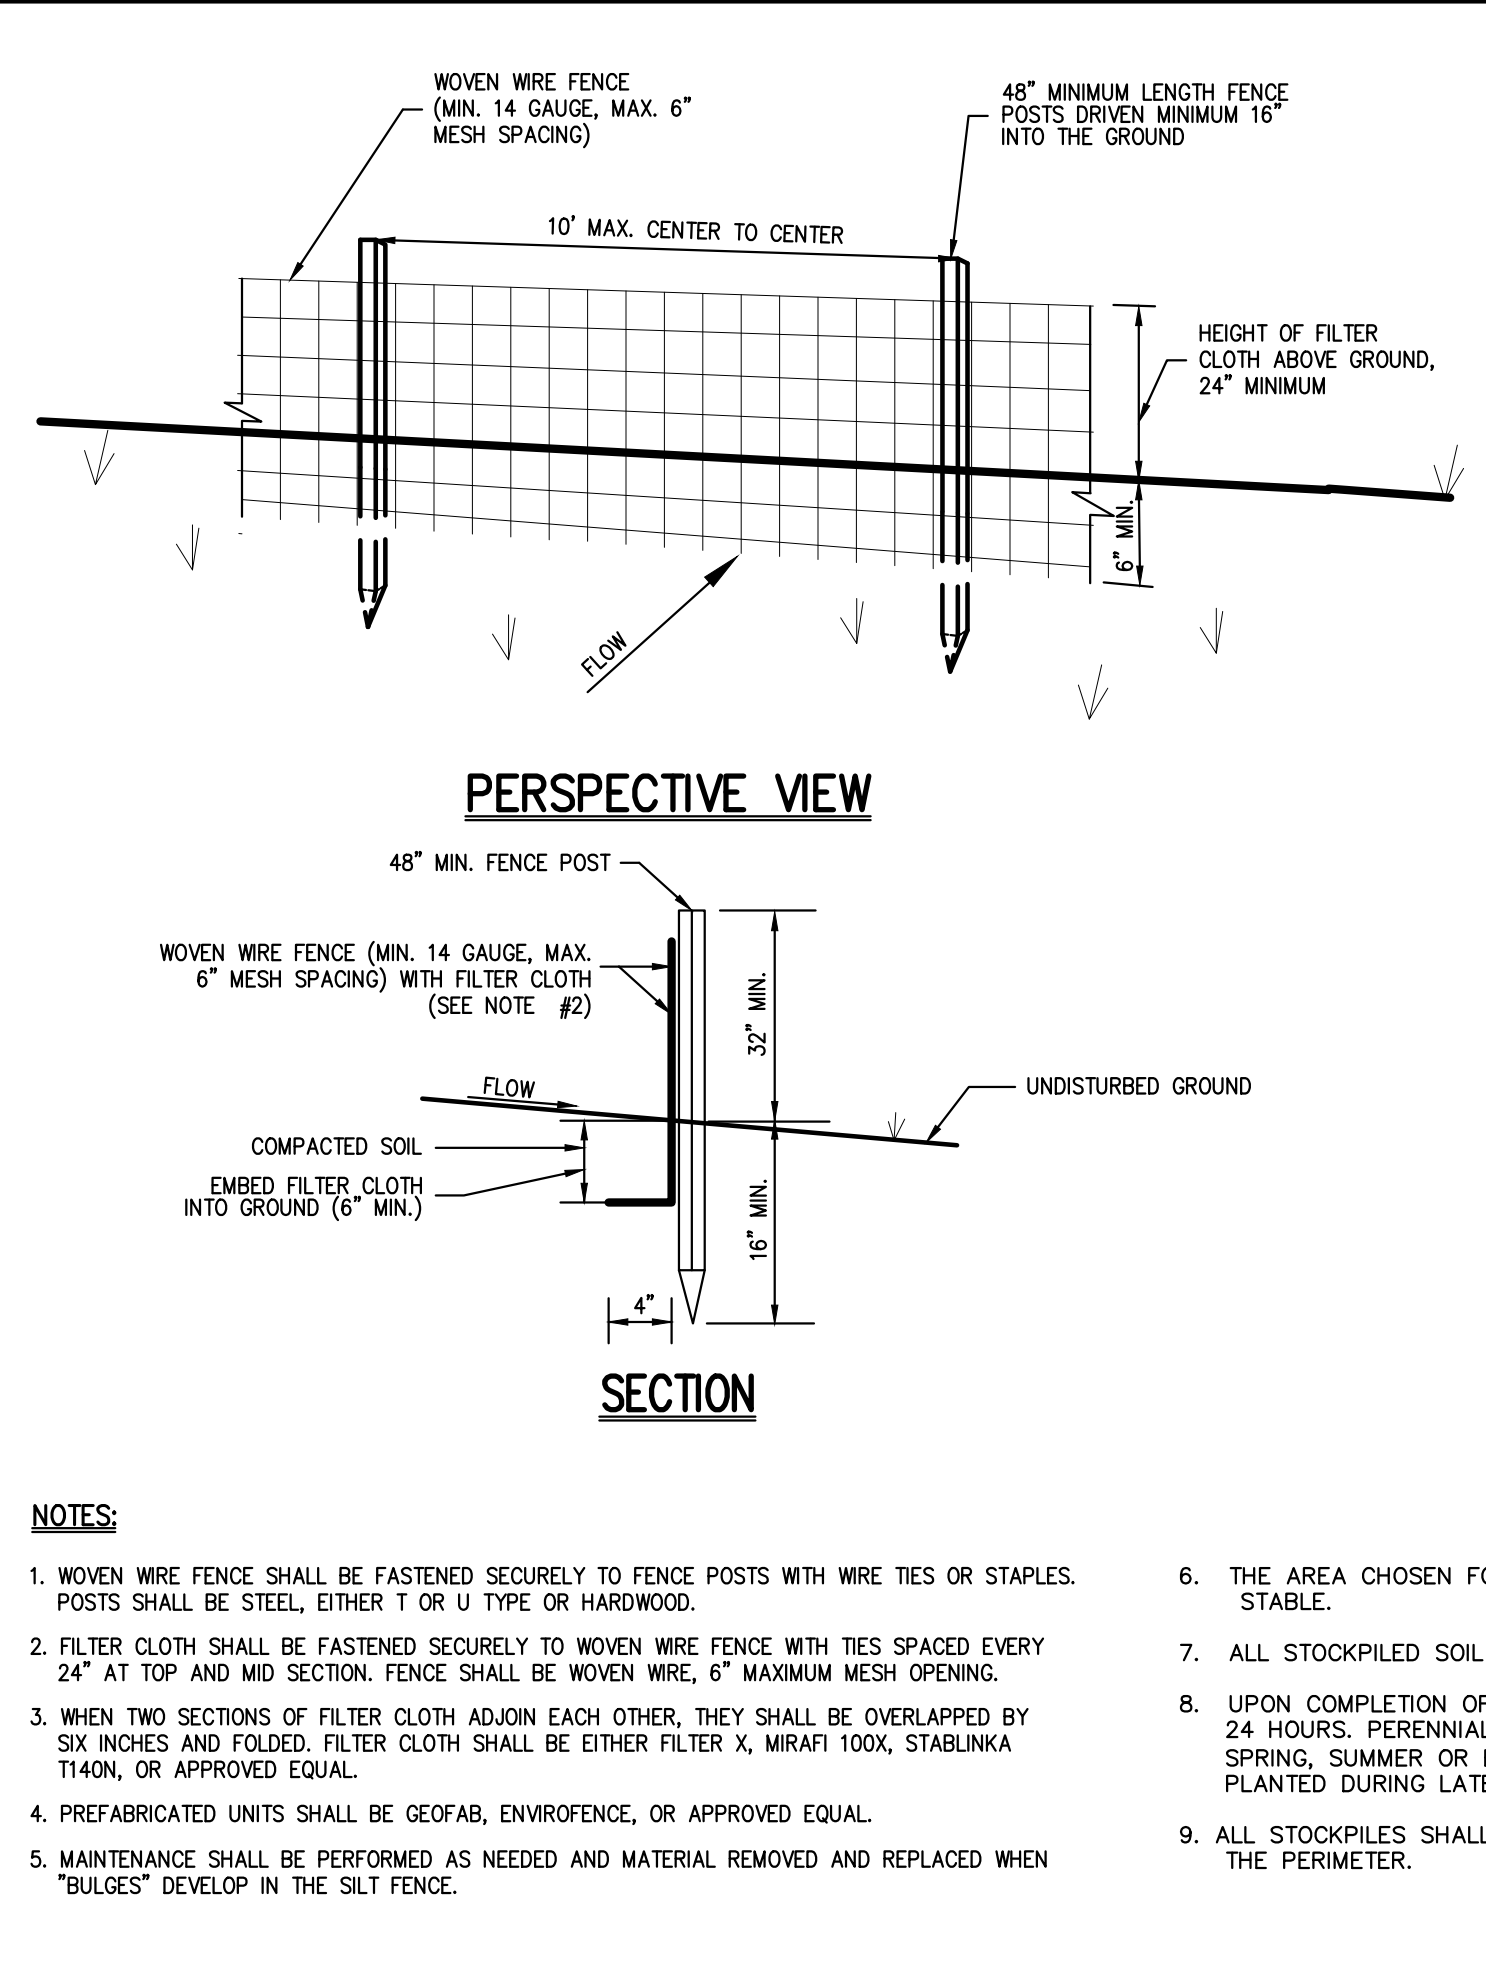
SILT FENCE

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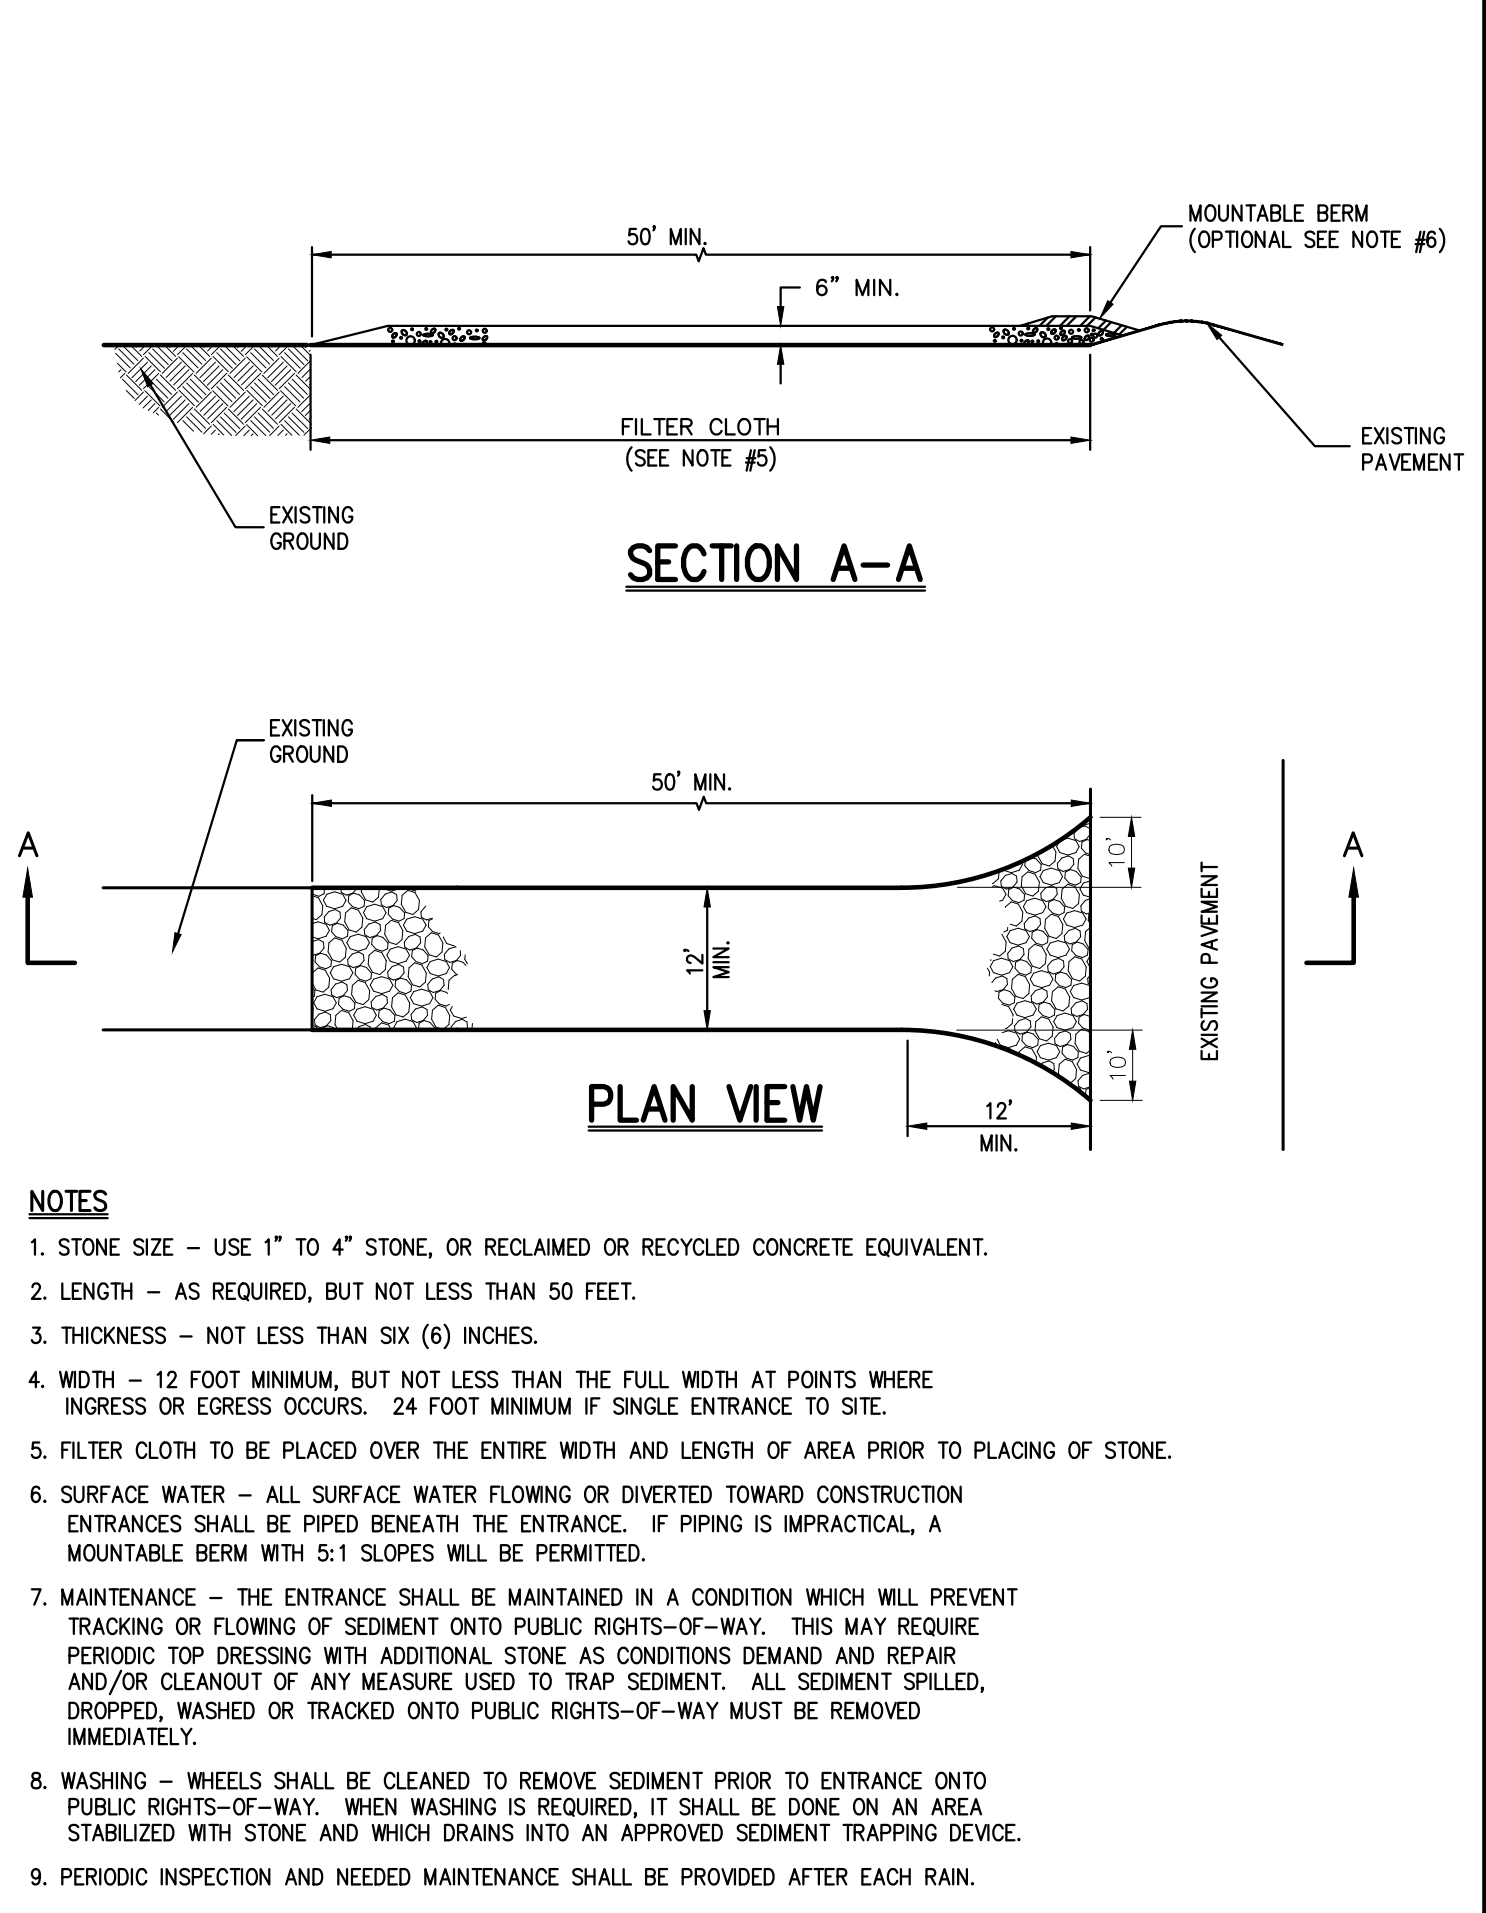
CONSTRUCTION FENCE

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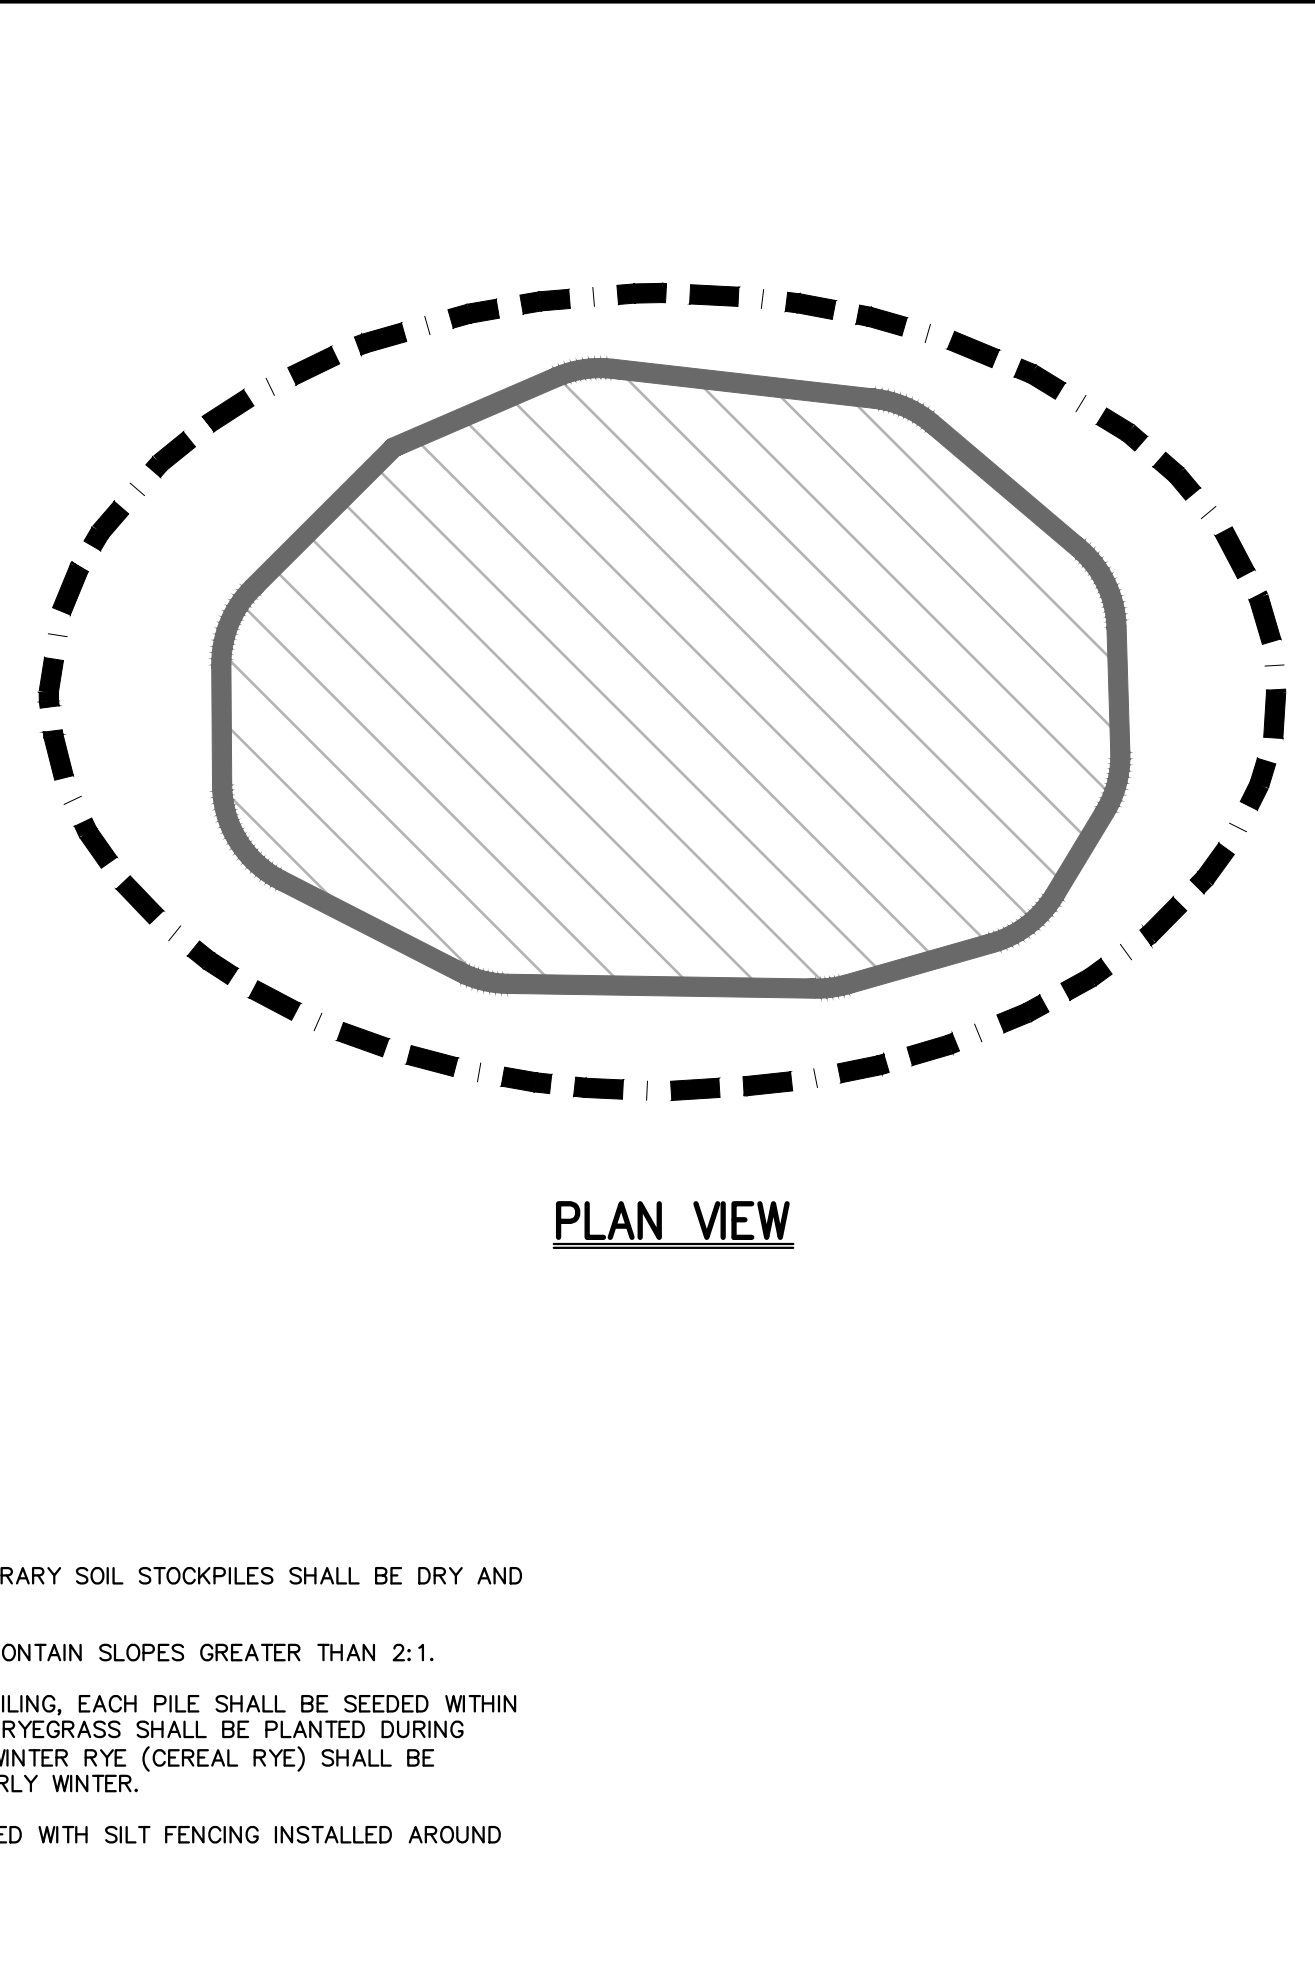
TEMPORARY SOIL STOCKPILE WITH SILT FENCE

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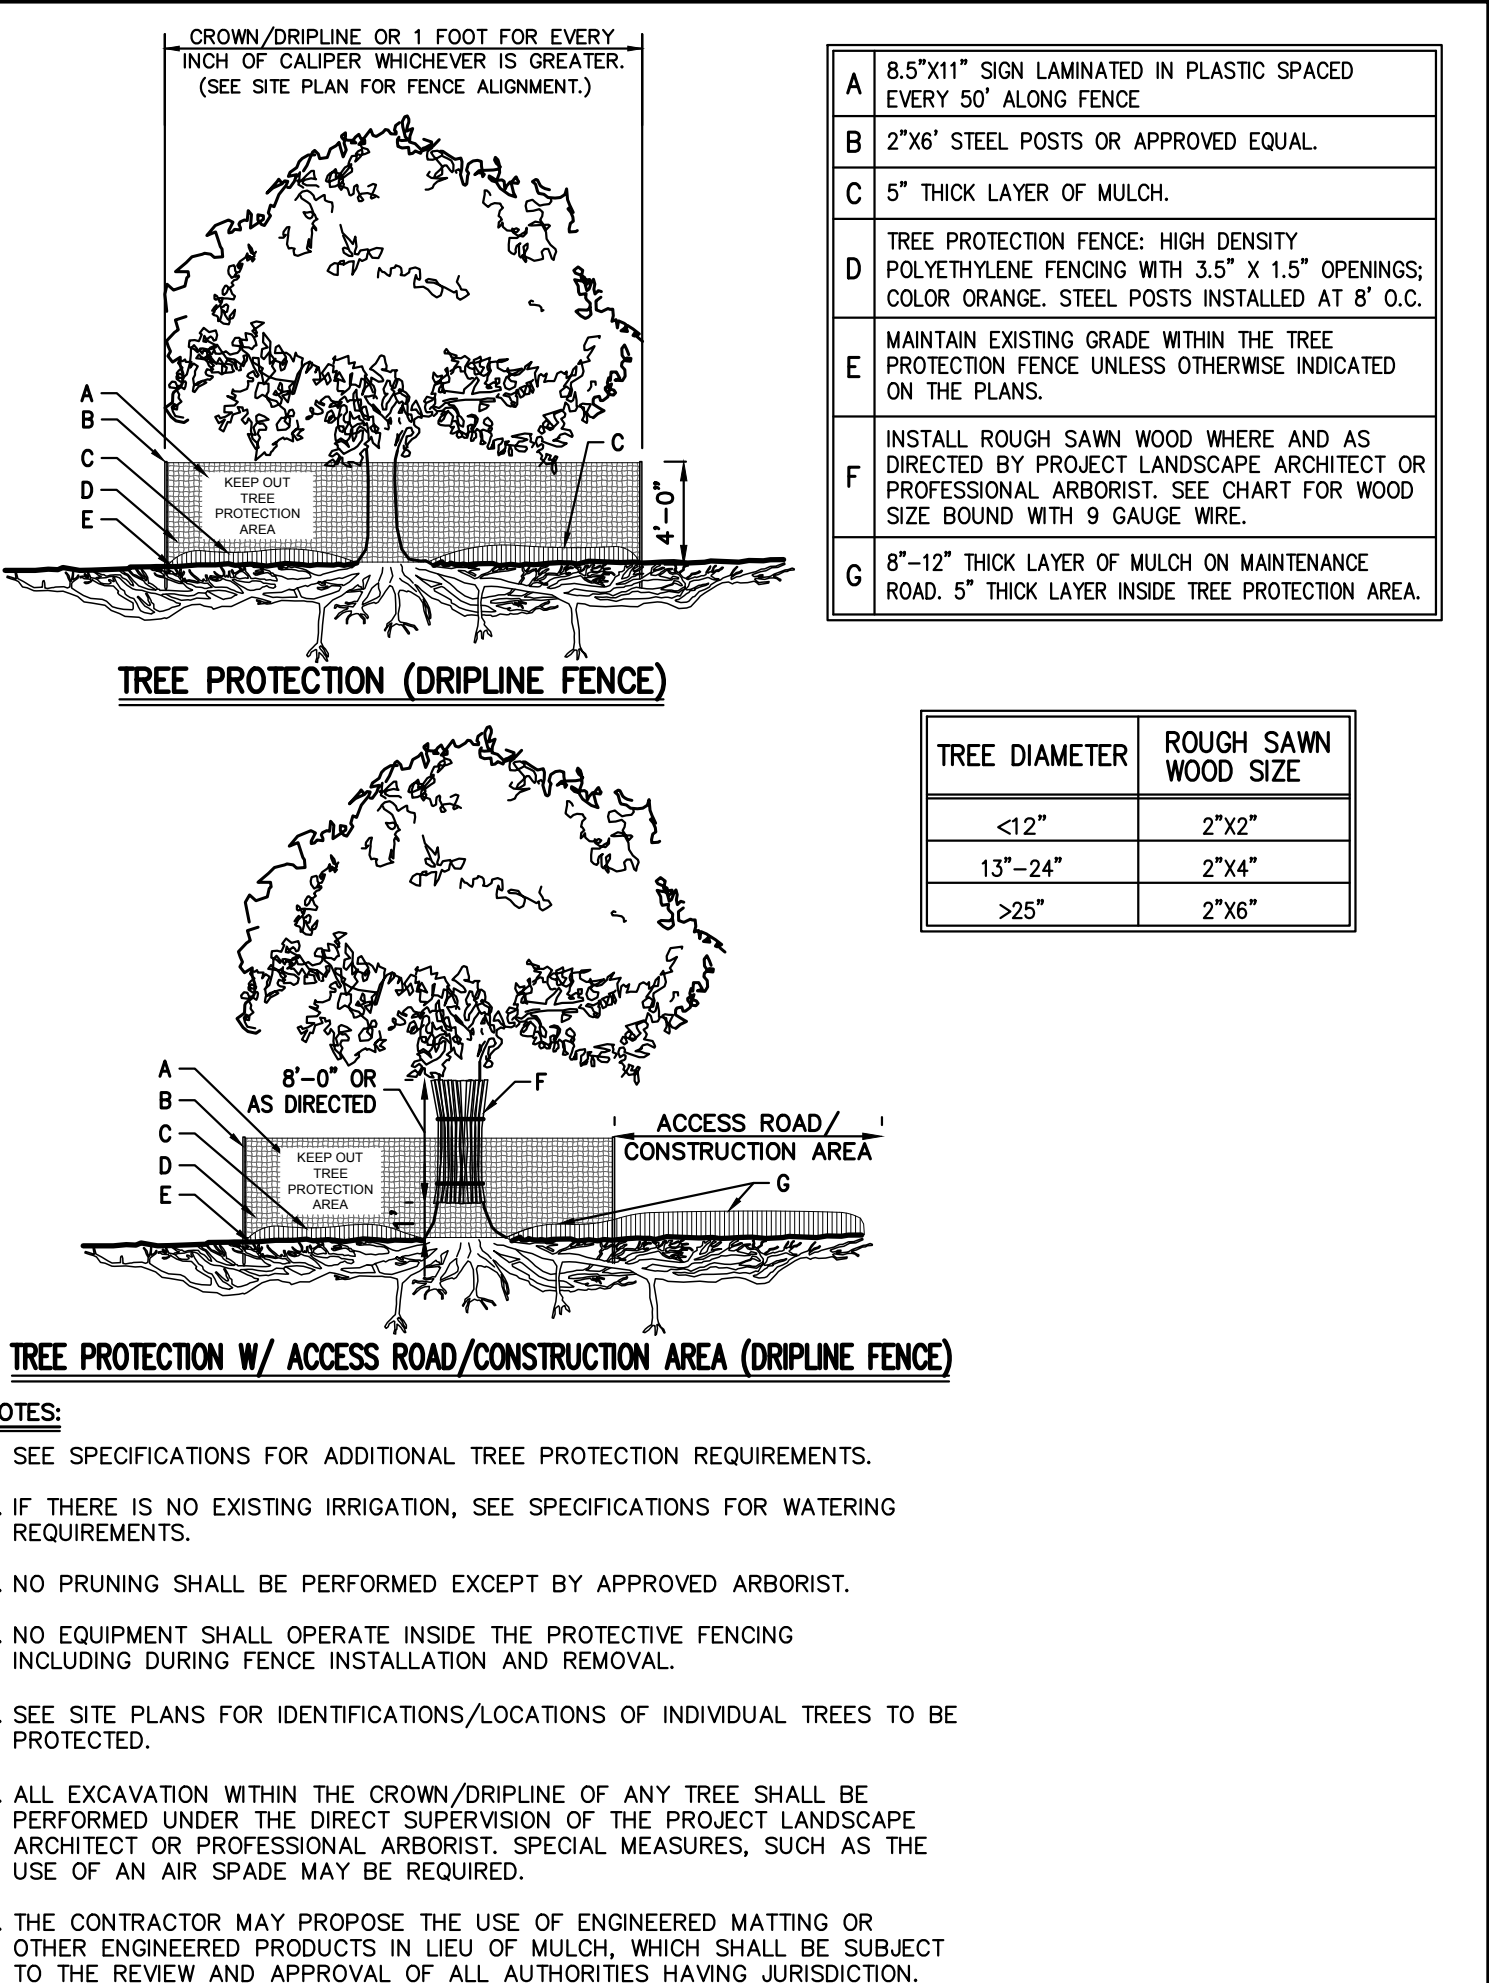
STABILIZED CONSTRUCTION ENTRANCE

5



TYPE II TRENCH

6



UTILITY TRENCH DETAIL

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Date

04/11/2019

Revision

1. REVISED BUILDING FOOTPRINT

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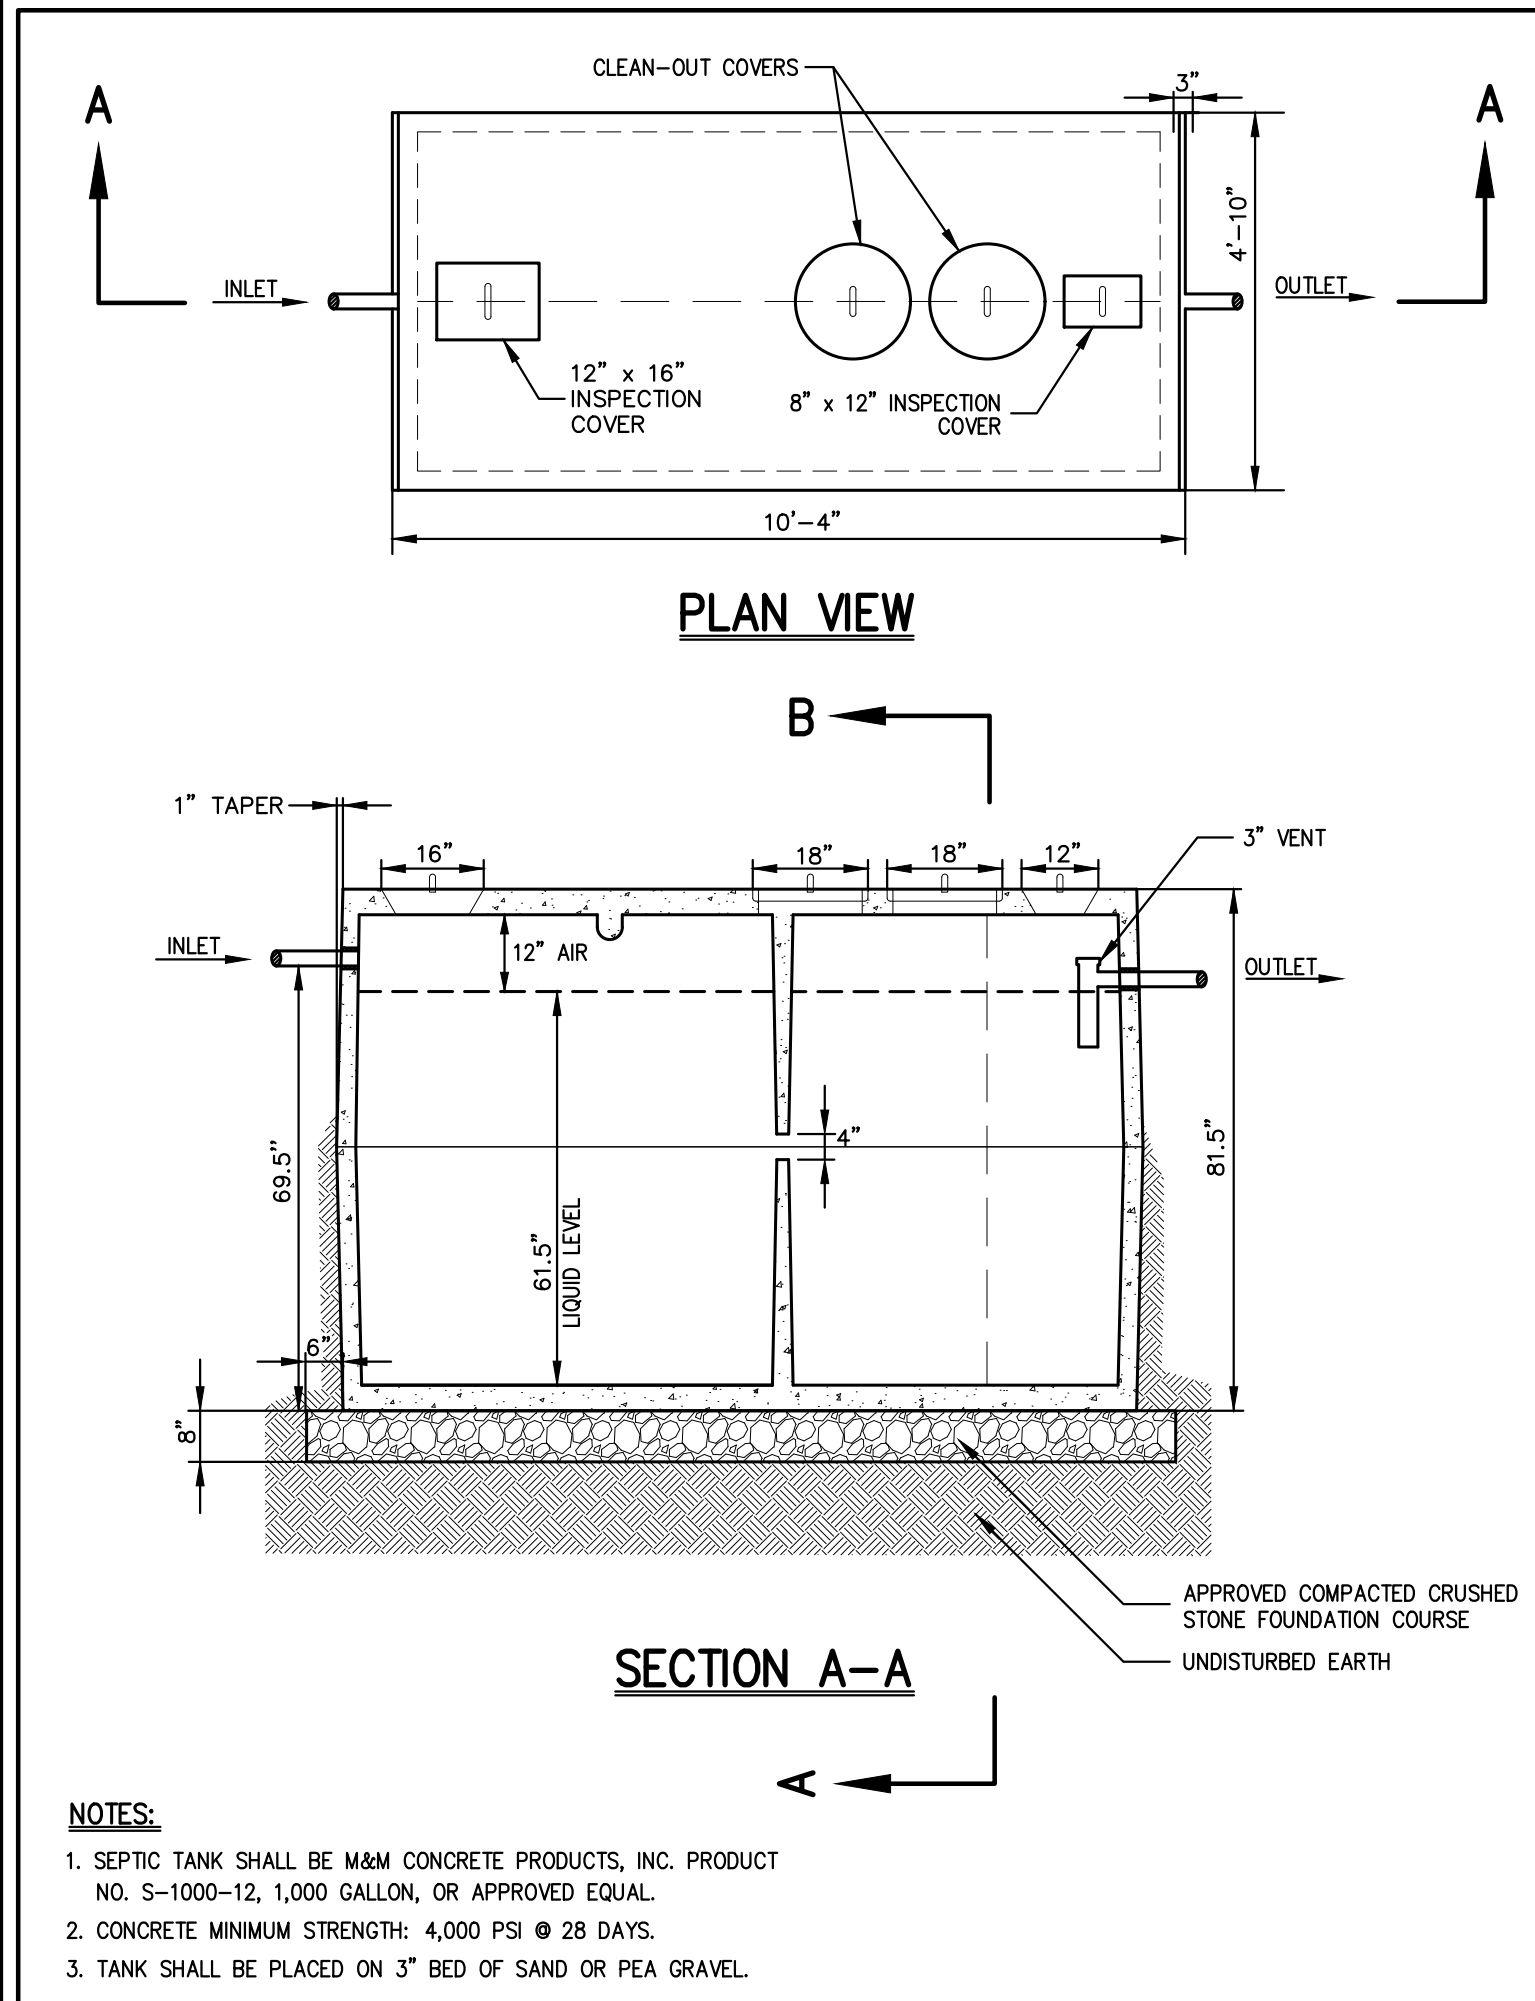
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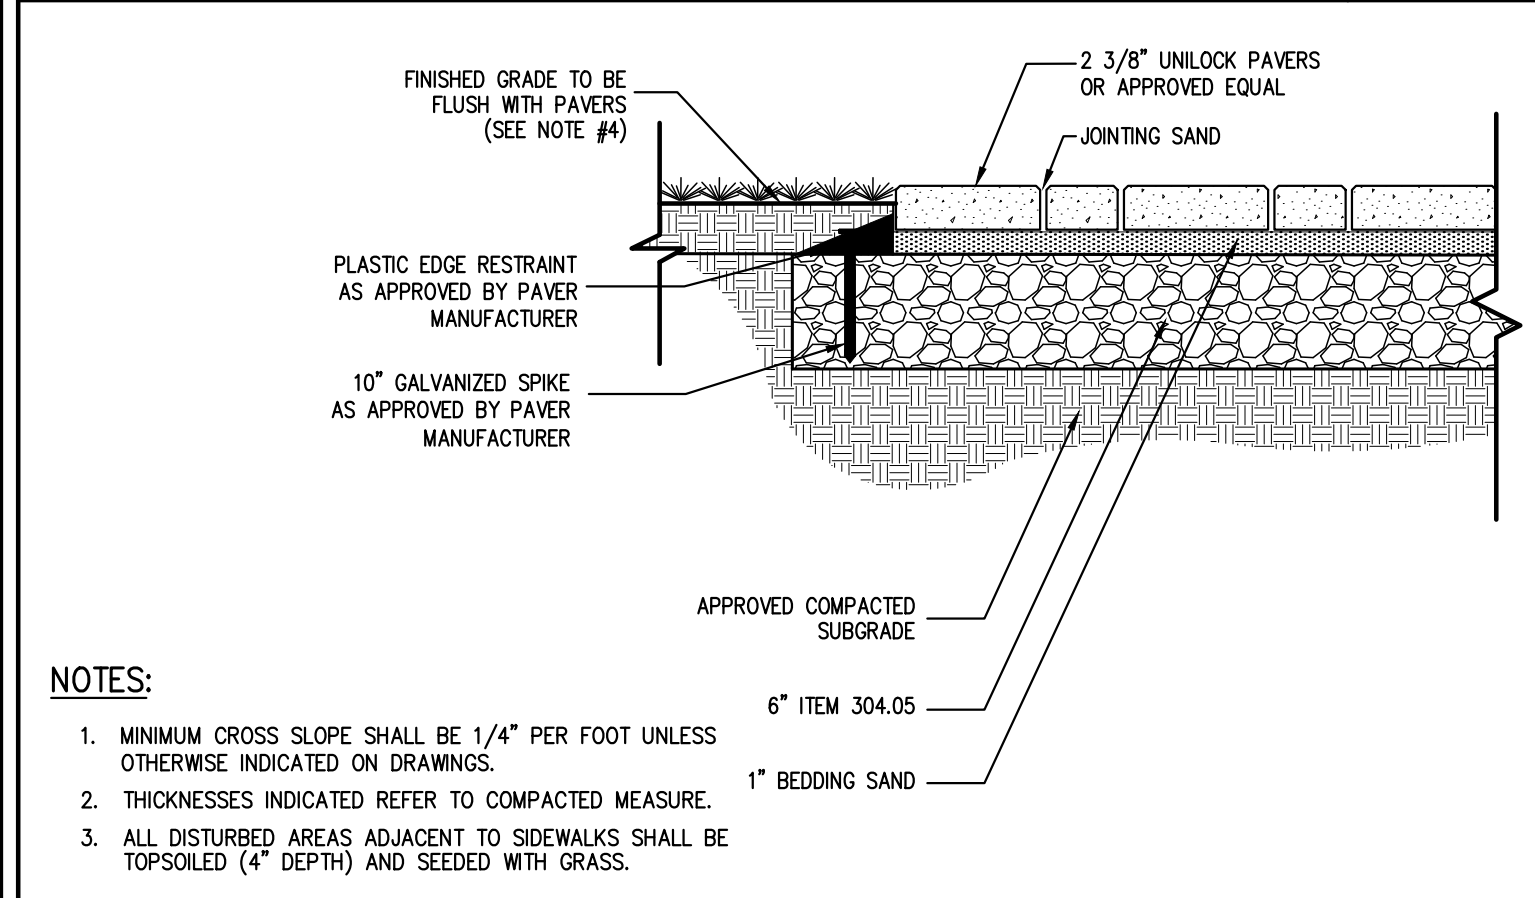
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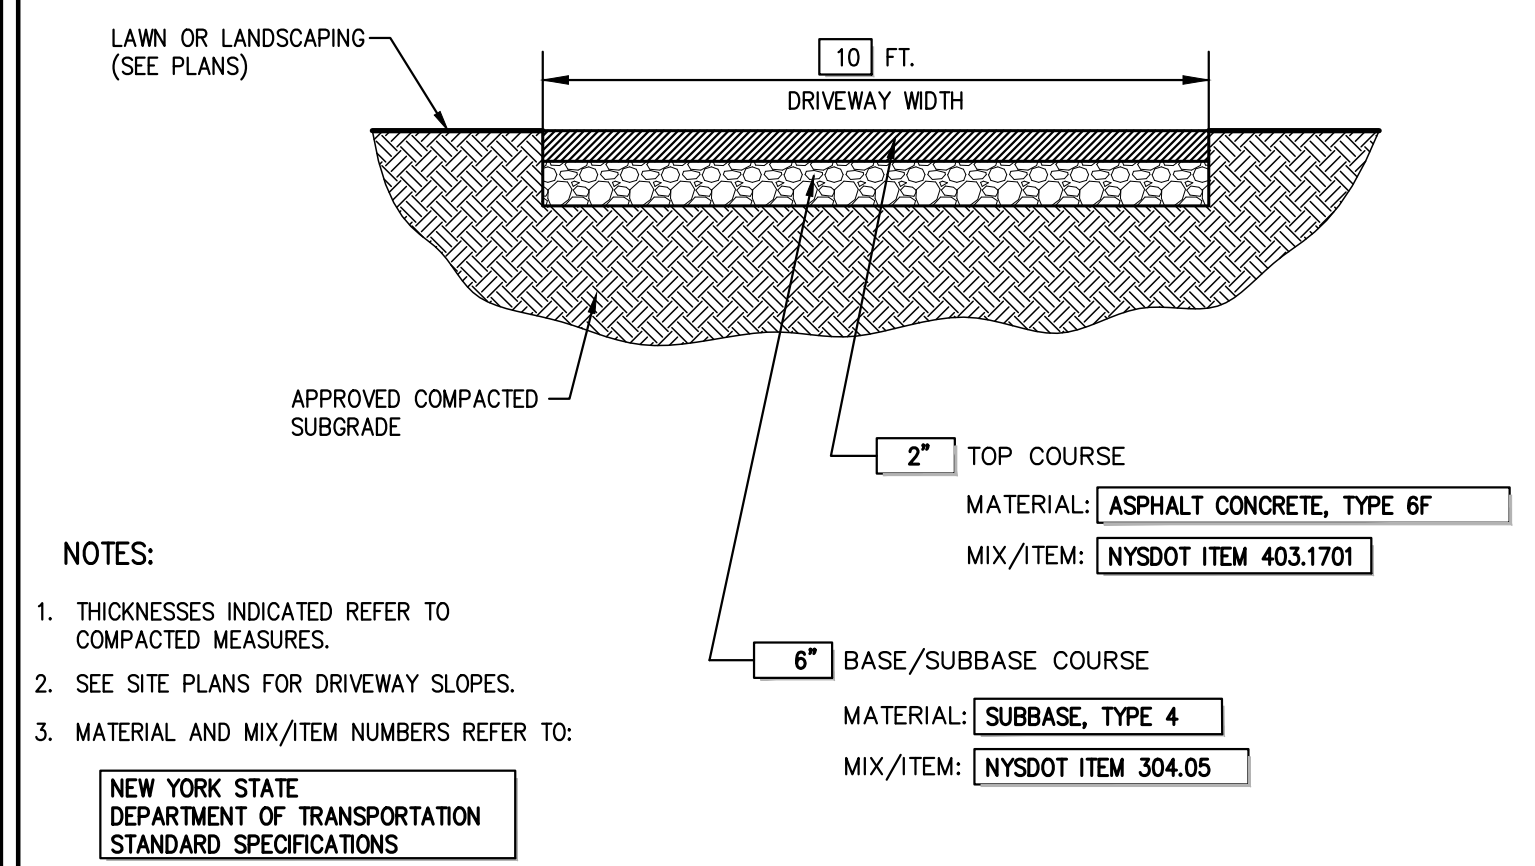
1,500 GALLON SEPTIC TANK

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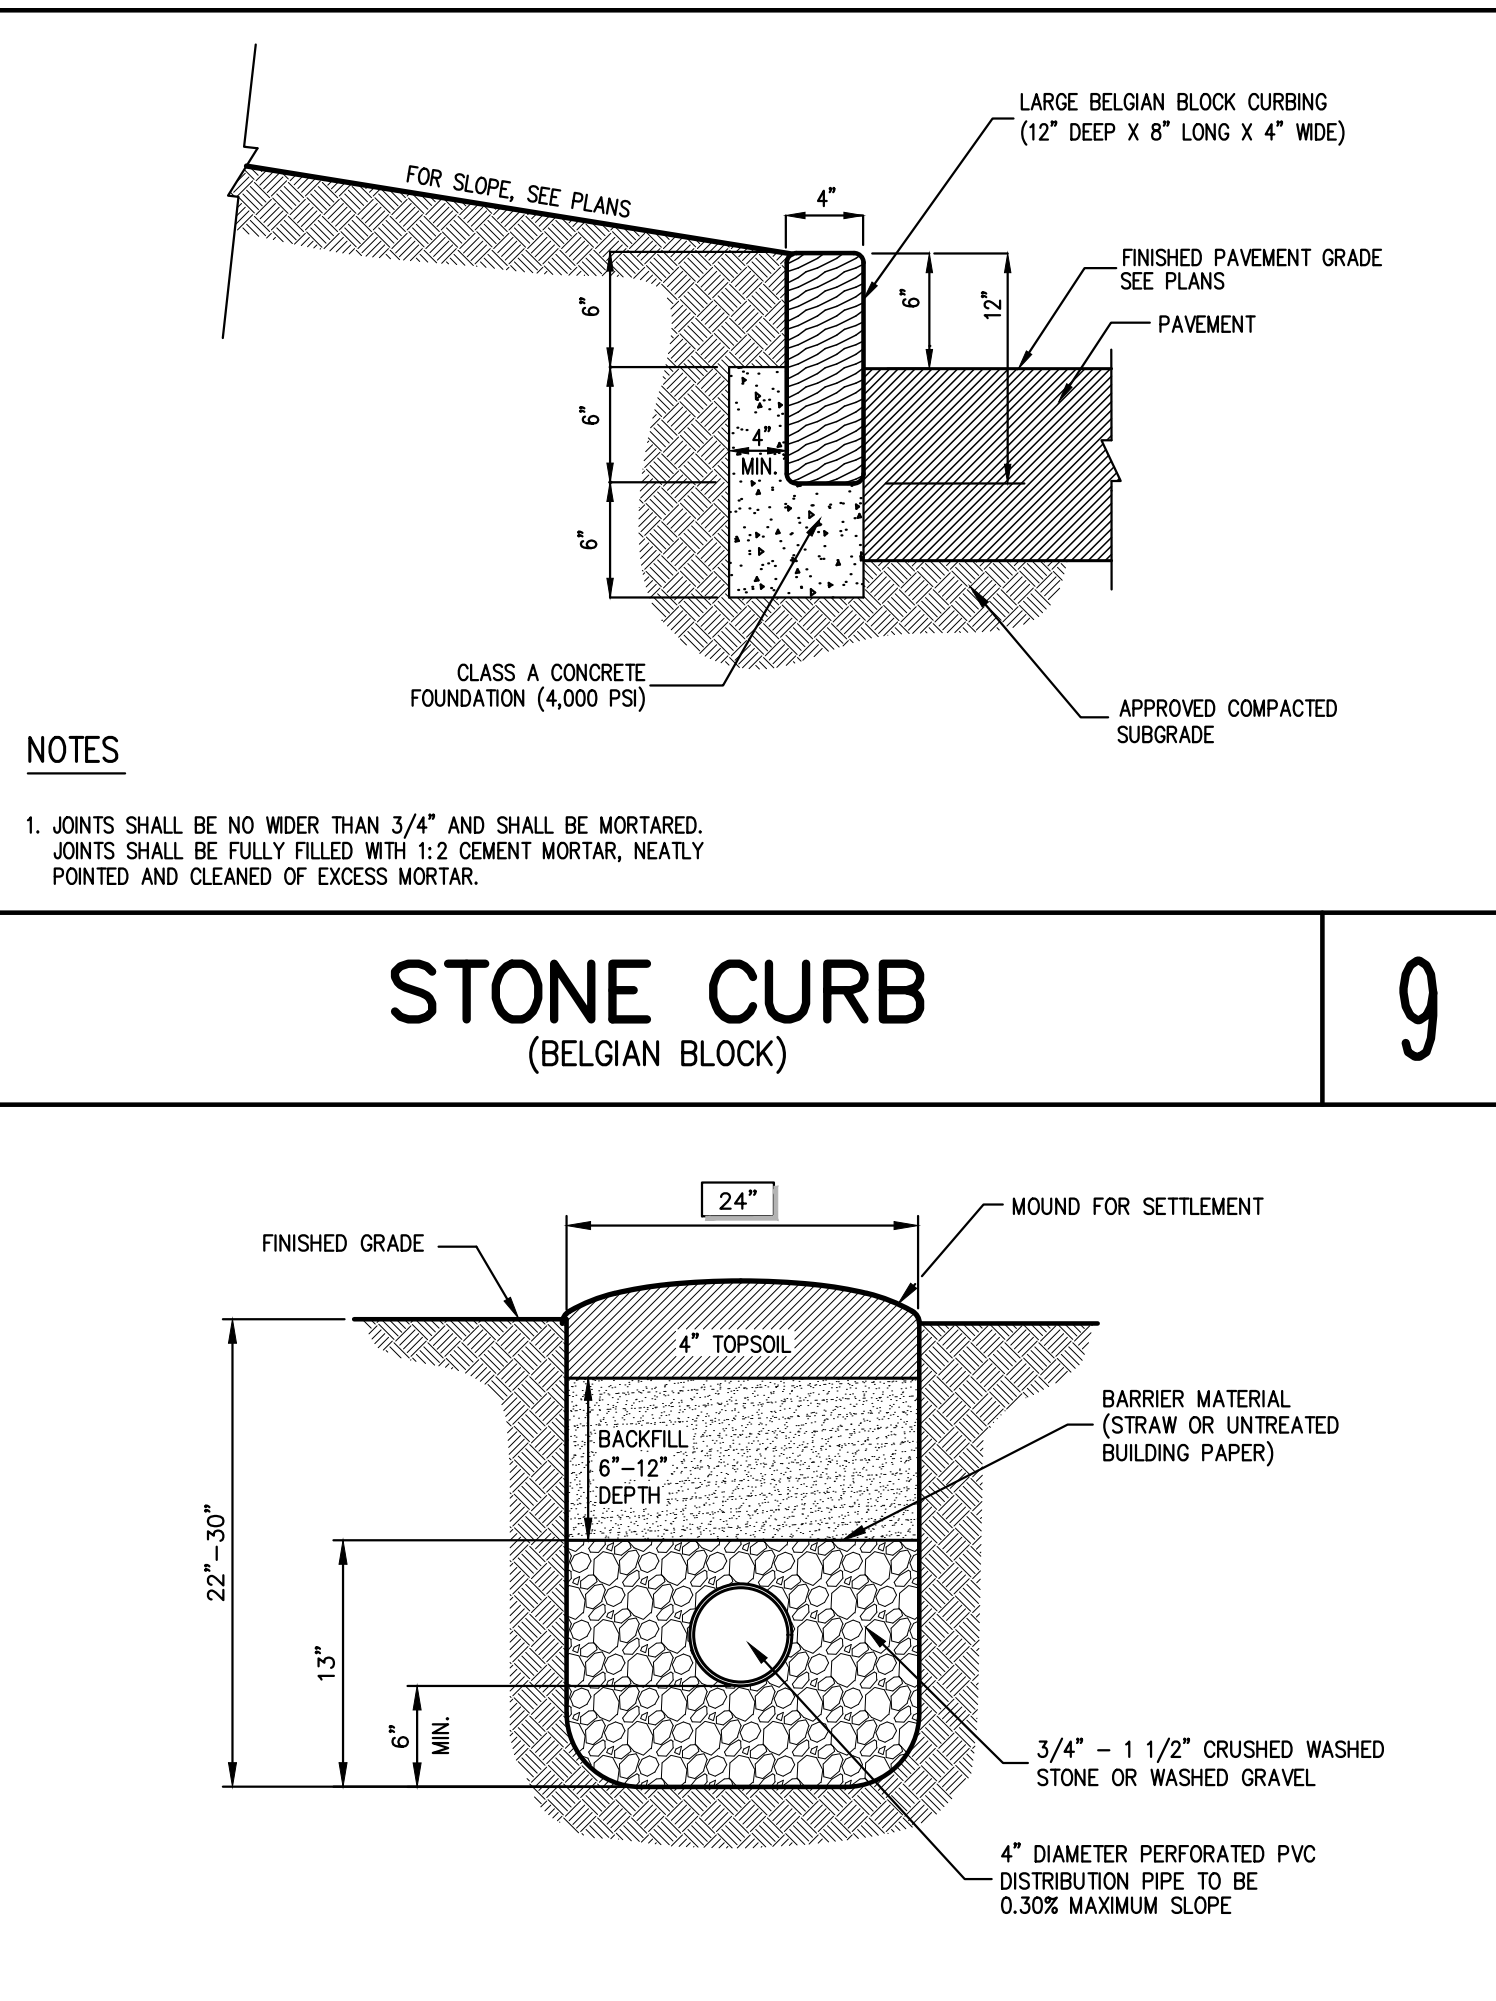
PAVER INSTALLATION (PROPOSED WALKWAY)

13



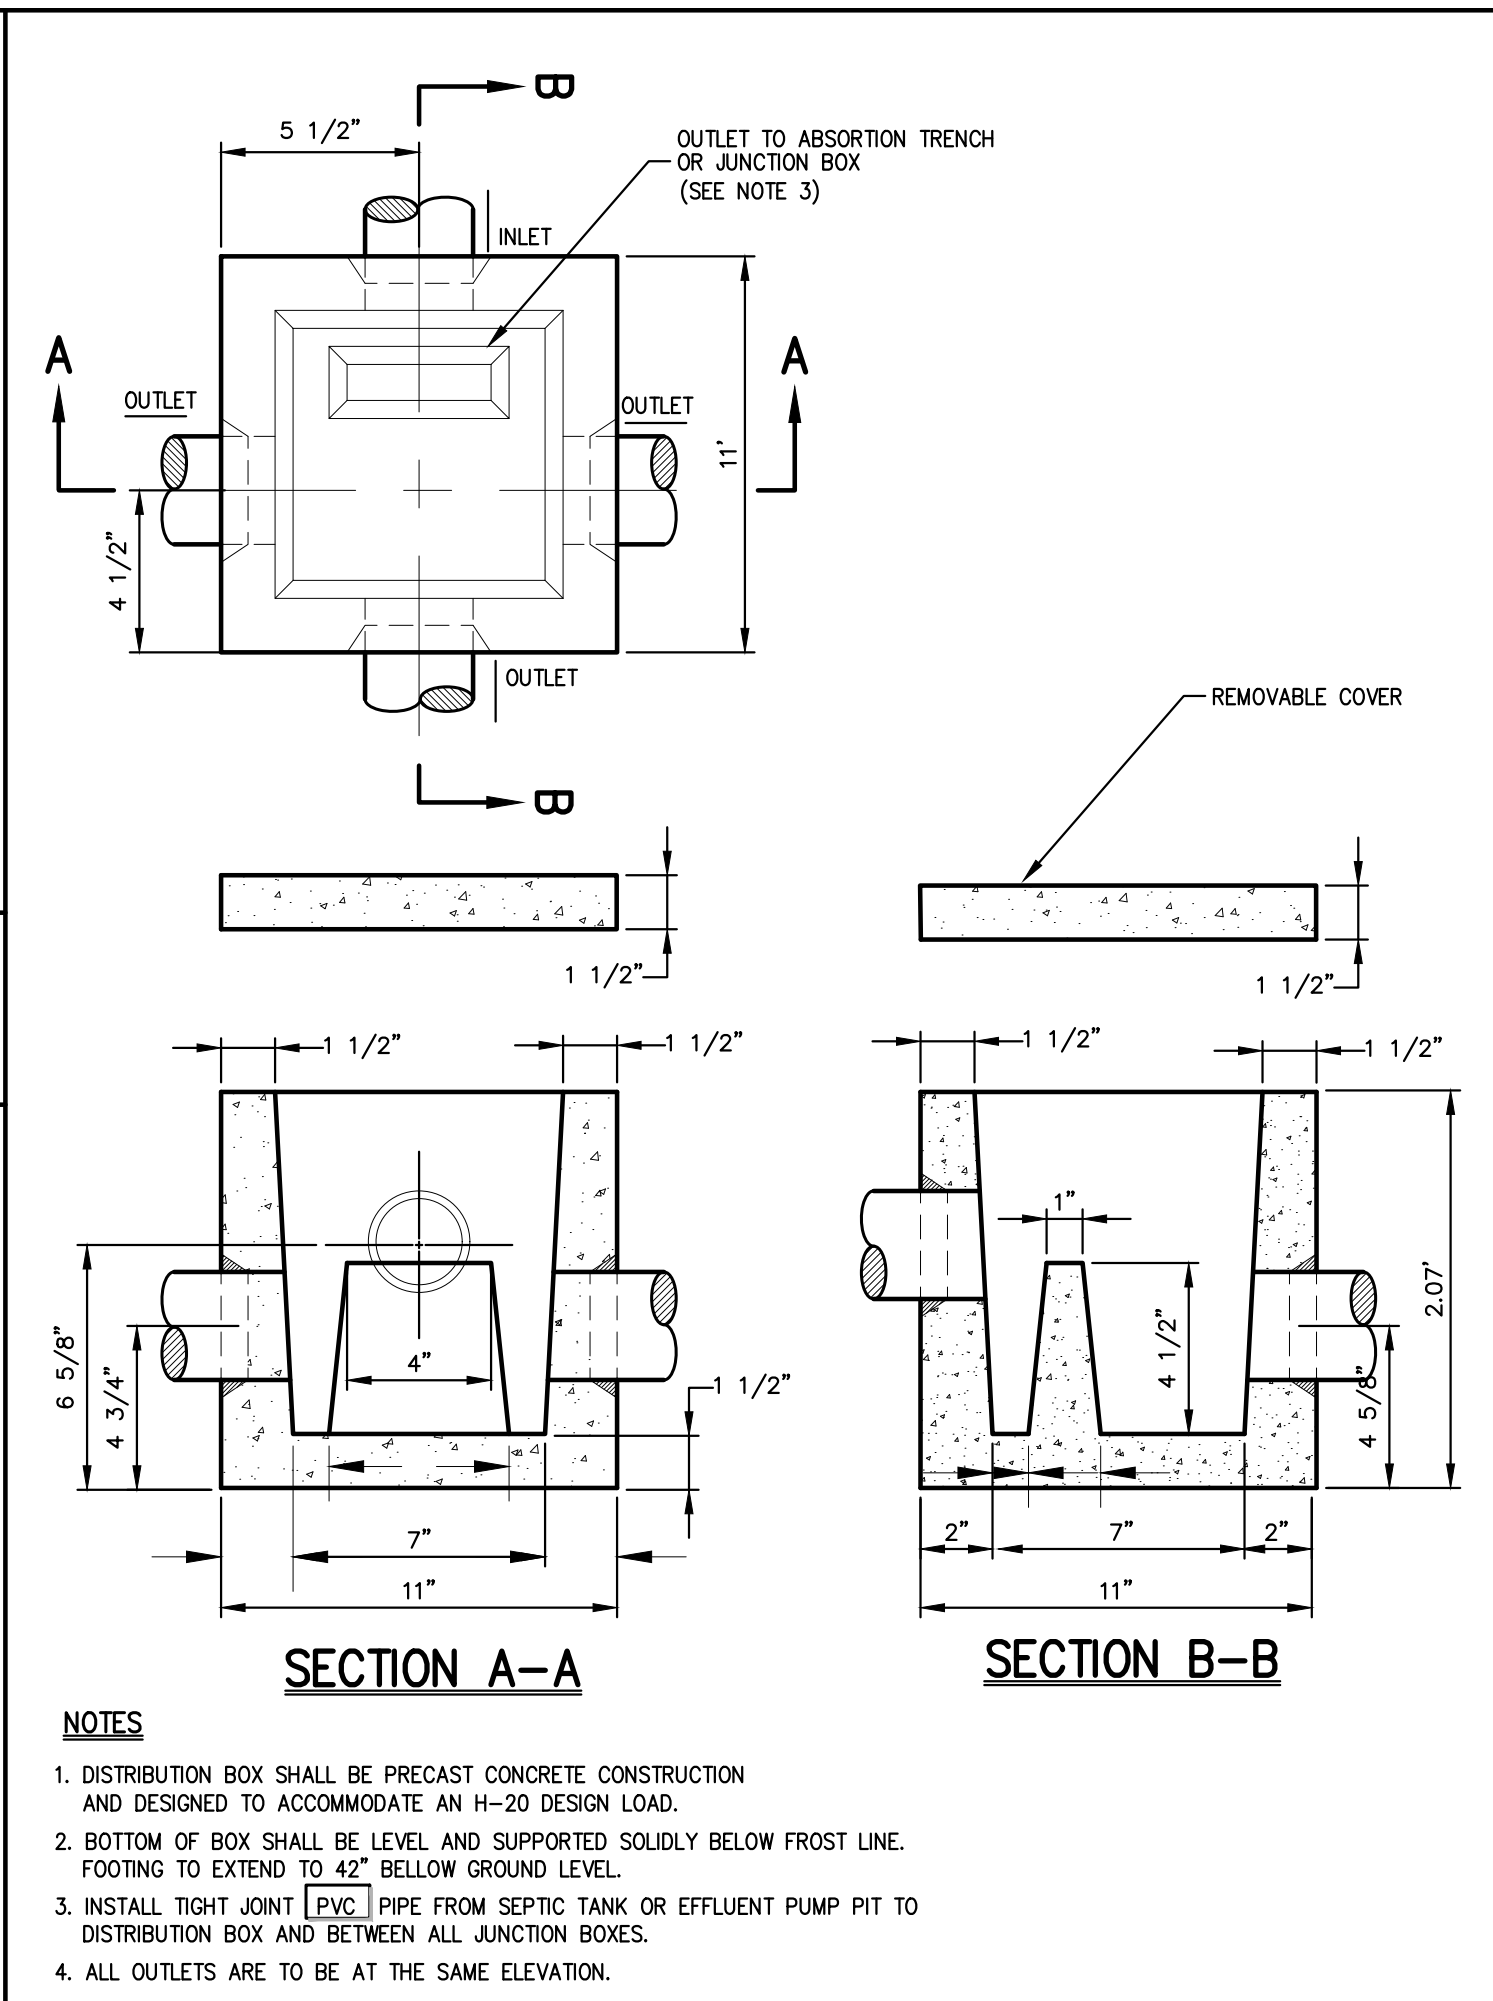
STANDARD DRIVEWAY

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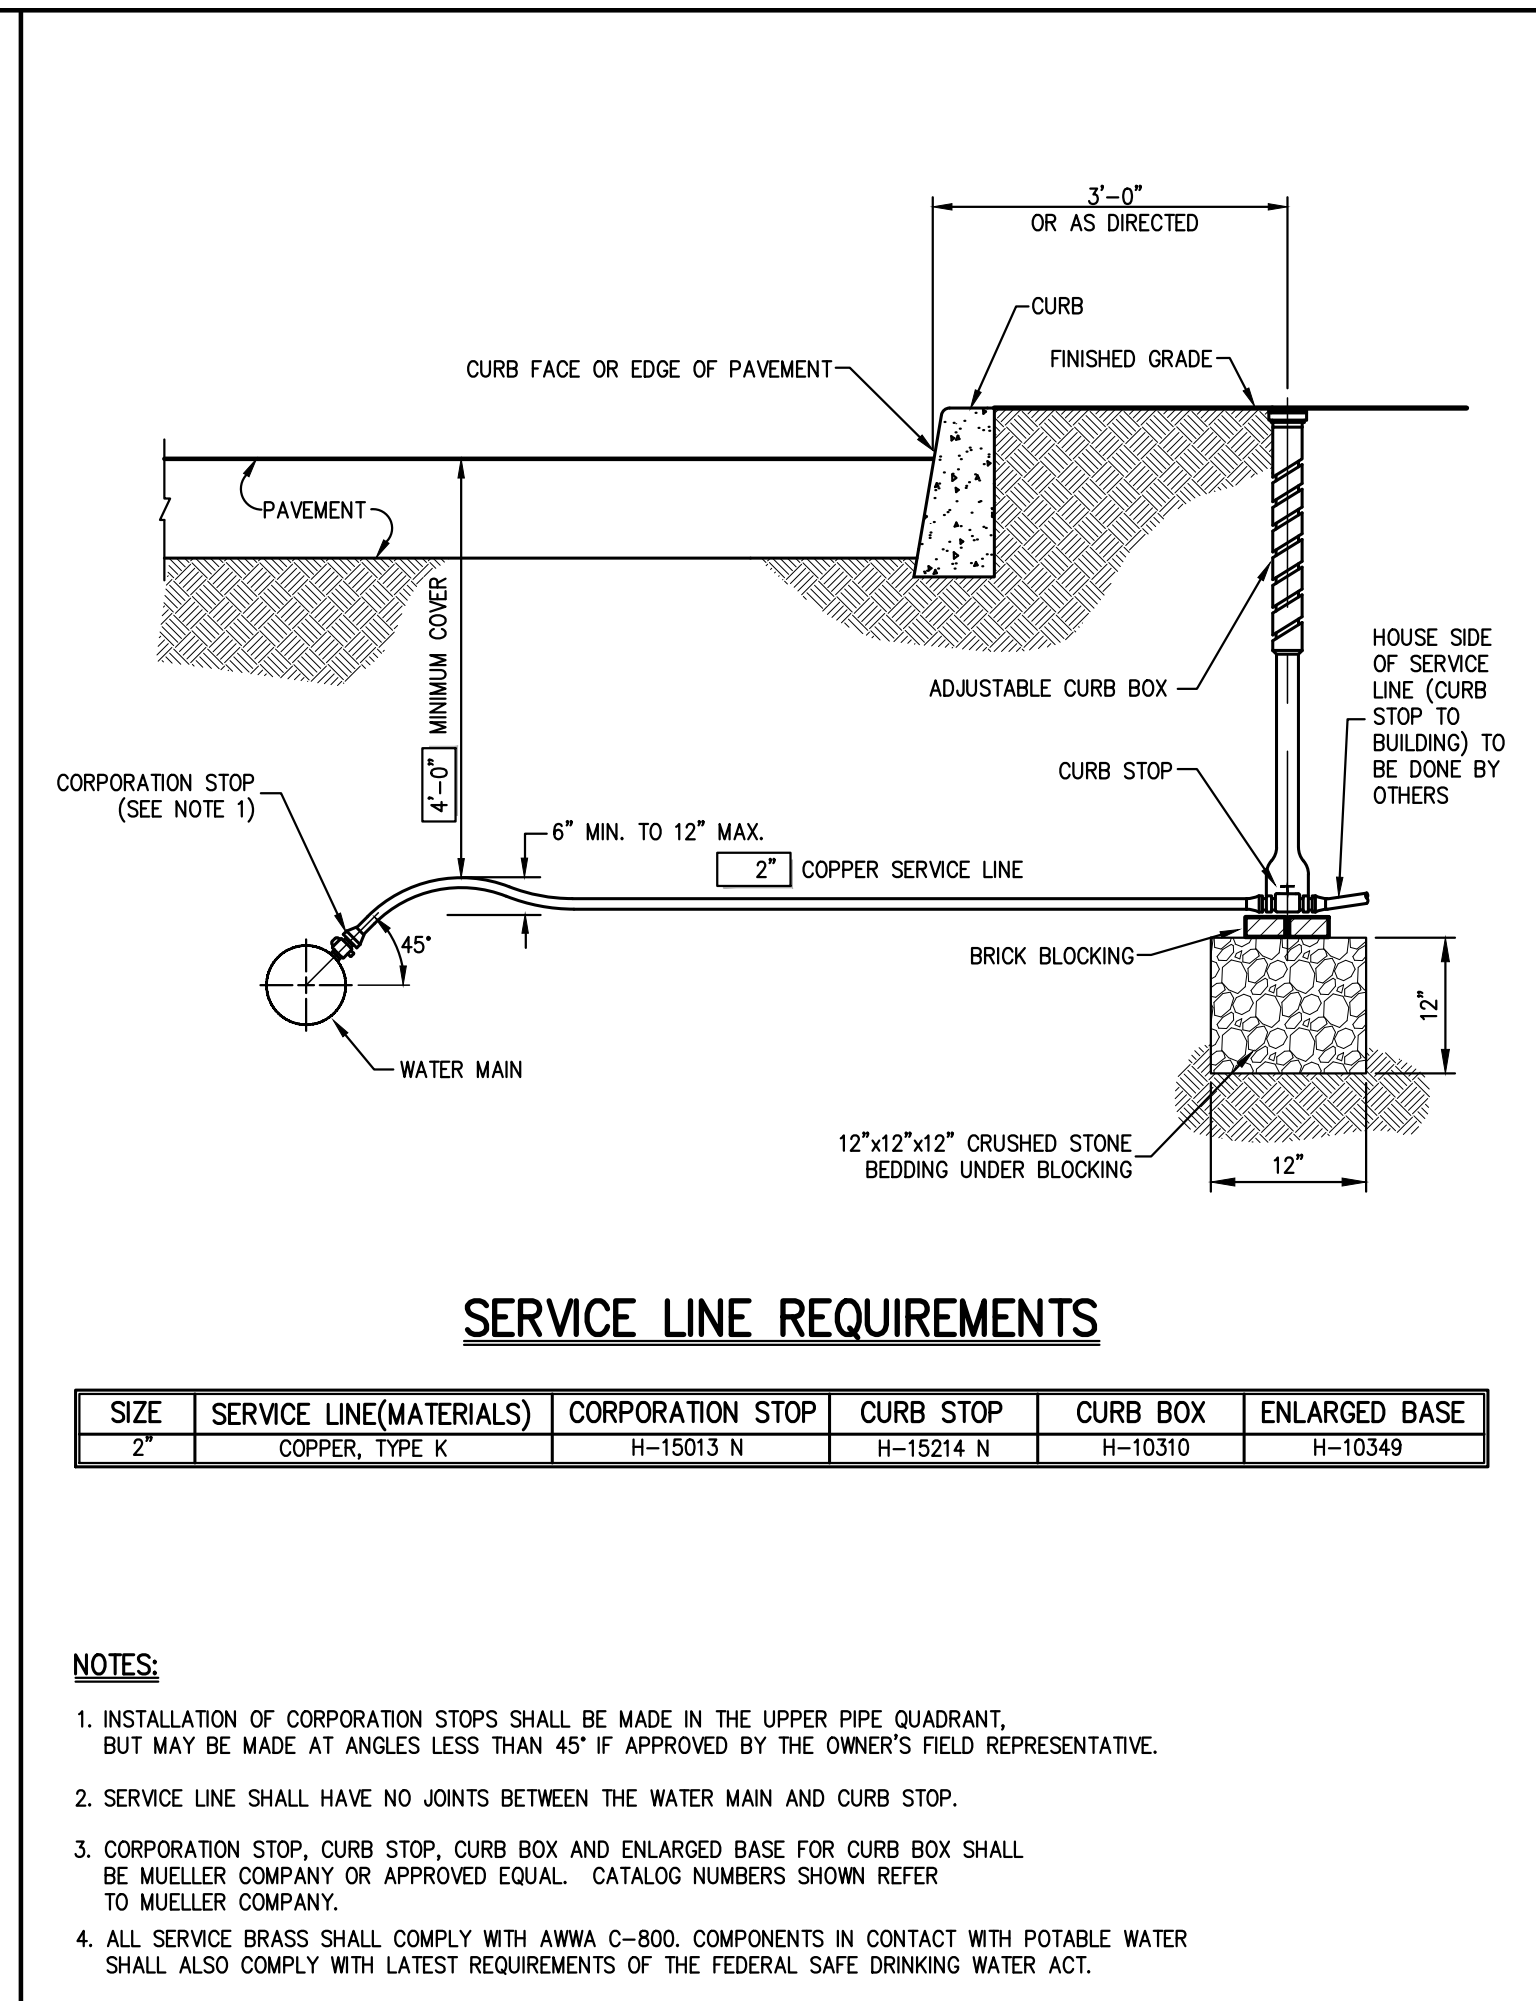
ABSORPTION TRENCH

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3-WAY DISTRIBUTION BOX

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WATER SERVICE CONNECTION (2" OR LESS)

12

No.

Revision

Date

1.

REVISED BUILDING FOOTPRINT

04/11/2019

2.

UPDATED WETLAND LINES

02/28/2020

3.

UPDATED SURVEY

05/11/2020

4.

REVISED PER VILLAGE COMMENTS

06/08/2020

5.

RESUBMIT TO VILLAGE NCZMC

07/01/2020

JMC Planning, Engineering, Landscape Architecture & Land Surveying, PLLC

JMC Site Development Consultants, LLC

John Meyer Consulting, Inc.

120 BEDFORD ROAD • ARMONK, NY 10504

voice 914.273.5225 • fax 914.273.2102

www.jmcpllc.com

CONSTRUCTION DETAILS

RESIDENTIAL DEVELOPMENT

1165 GREACEN POINT ROAD

MAMARONECK, NY, 10543

ANY ALTERATION OF PLANS, SPECIFICATIONS, PLATS AND REPORTS BEARING THE SEAL OF A LICENSED PROFESSIONAL ENGINEER OR LICENSED LAND SURVEYOR IS A VIOLATION OF SECTION 7209 OF THE NEW YORK STATE EDUCATION LAW, EXCEPT AS PROVIDED FOR BY SECTION 7209, SUBSECTION 2.

Drawn: SMN

Approved: JAR

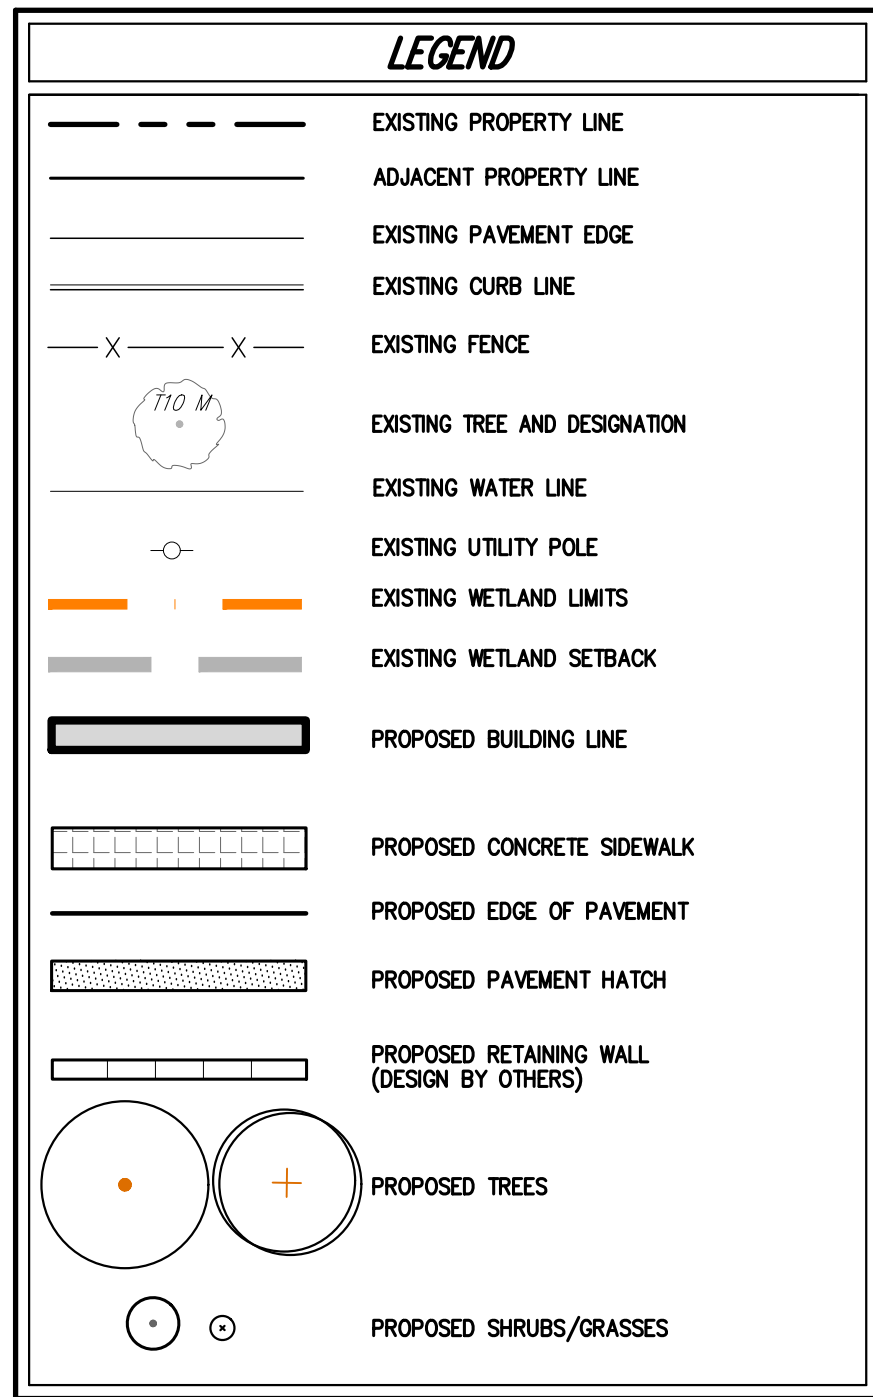
Scale: NOT TO SCALE

Date: 07/24/2018

Project No: 18100

1800-REIMS C-901

Drawing No: C-901



1. EXISTING CONDITIONS DEPICTED ON THIS PLAN HAVE BEEN TAKEN FROM SURVEY PREPARED BY SPINELLI SURVEYING, DATED 02/22/2018, LAST REVISED 04/23/2020.

ANY ALTERATION OF PLANS, SPECIFICATIONS, PLATS AND REPORTS BEARING THE SEAL OF A LICENSED PROFESSIONAL ENGINEER OR LICENSED LAND SURVEYOR IS A VIOLATION OF SECTION 7209 OF THE NEW YORK STATE EDUCATION LAW, EXCEPT AS PROVIDED FOR BY SECTION 7209, SUBSECTION 2.

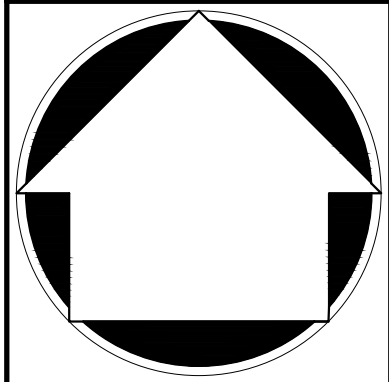
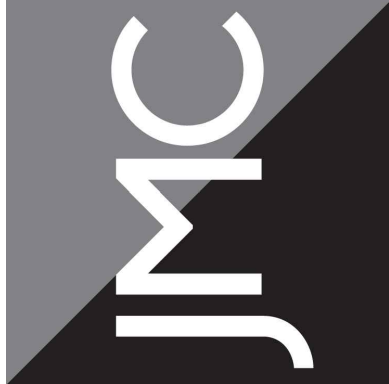
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Drawn:	RAR		Approved:	JAR	
Scale:	1" = 20'				
Date:	06/28/2020				
Project No:	18100				
18100-LAND	L-100		LAY.scr		
Drawing No:					
L-100					

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Architecture & Land Surveying, PLLC**
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LANDSCAPING PLAN

RESIDENTIAL DEVELOPMENT