SITE PLAN APPROVAL DRAWINGS

RESIDENTIAL DEVELOPMENT

TAX MAP SECTION 9 | BLOCK 50 | LOT 373 WESTCHESTER COUNTY 1165 GREACEN POINT ROAD MAMARONECK, NY, 10543

Applicant/Owner:

MR. WILLIAM FEDYNA & ELISABETH FEDYNA 219 W 81ST STREET, APT. 9D **NEW YORK. NY. 10024**

Architect:

ARCHI-TECTONICS

111 JOHN ST #700 **NEW YORK, NY 10038** (212)206-0920

Attorney:

CUDDY & FEDER LLP 445 HAMILTON AVENUE, 14TH FLOOR WHITE PLAINS, NY 10601 (914)761-1300


Surveyor:


SPINELLI SURVEYING


650 HALSTEAD AVENUE MAMARONECK, NY 10543 (914) 381-2357



Site Planner, Civil & Traffic Engineer, **Surveyor and Landscape Architect:** 120 BEDFORD ROAD **ARMONK, NY 10504** (914) 273-5225

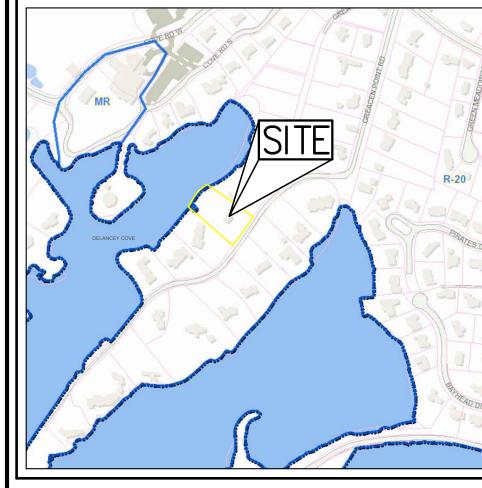

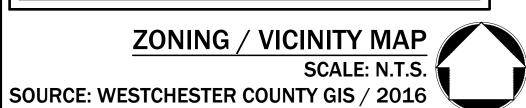

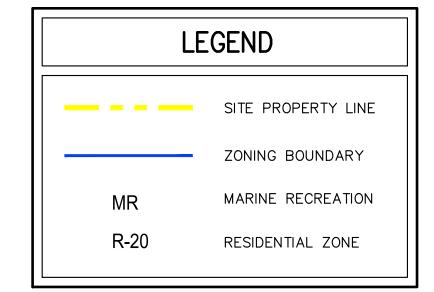

PROJECT AREA

GENERAL CONSTRUCTION NOTES APPLY TO ALL WORK HEREIN:

- 1. PRIOR TO CONSTRUCTION, THE CONTRACTOR SHALL CALL 811 "DIG SAFELY" (1-800-962-7962) TO HAVE UNDERGROUND UTILITIES LOCATED. EXPLORATORY EXCAVATIONS SHALL COMPLY WITH CODE 753 REQUIREMENTS. NO WORK SHALL COMMENCE UNTIL ALL THE OPERATORS HAVE NOTIFIED THE CONTRACTOR THAT THEIR UTILITIES HAVE BEEN LOCATED. THE CONTRACTOR SHALL BE RESPONSIBLE FOR THE PRESERVATION OF ALL PUBLIC AND PRIVATE UNDERGROUND AND SURFACE UTILITIES AND STRUCTURES AT OR ADJACENT TO THE SITE OF CONSTRUCTION, INSOFAR AS THEY MAY BE ENDANGERED BY THE CONTRACTOR'S OPERATIONS. THIS SHALL HOLD TRUE WHETHER OR NOT THEY ARE SHOWN ON THE CONTRACT DRAWINGS. IF THEY ARE SHOWN ON THE DRAWINGS, THEIR LOCATIONS ARE NOT GUARANTEED EVEN THOUGH THE INFORMATION WAS OBTAINED FROM THE BEST AVAILABLE SOURCES, AND IN ANY EVENT, OTHER UTILITIES ON THESE PLANS MAY BE ENCOUNTERED IN THE FIELD. THE CONTRACTOR SHALL. AT HIS OWN EXPENSE, IMMEDIATELY REPAIR OR REPLACE ANY STRUCTURES OR UTILITIES THAT HE DAMAGES, AND SHALL CONSTANTLY PROCEED WITH CAUTION TO PREVENT UNDUE INTERRUPTION OF UTILITY SERVICE.
- 2. CONTRACTOR SHALL HAND DIG TEST PITS TO VERIFY THE LOCATION OF ALL EXISTING UNDERGROUND UTILITIES PRIOR TO THE START OF CONSTRUCTION. CONTRACTOR SHALL VERIFY EXISTING UTILITIES DEPTHS AND ADVISE OF ANY CONFLICTS WITH PROPOSED UTILITIES. IF CONFLICTS ARE PRESENT. THE OWNER'S FIELD REPRESENTATIVE, JMC, PLLC AND THE APPLICABLE MUNICIPALITY OR AGENCY SHALL BE NOTIFIED IN WRITING. THE EXISTING/PROPOSED UTILITIES RELOCATION SHALL BE DESIGNED BY JMC, PLLC.
- 3. CONTRACTOR IS RESPONSIBLE FOR OBTAINING ANY AND ALL LOCAL PERMITS REQUIRED.
- AND REGULATIONS. ALL CONSTRUCTION WORK SHALL BE PERFORMED IN ACCORDANCE WITH ALL SAFETY CODES. APPLICABLE SAFETY CODES MEAN THE LATEST EDITION INCLUDING ANY AND ALL AMENDMENTS, REVISIONS, AND ADDITIONS THERETO, TO THE FEDERAL DEPARTMENT OF LABOR. OCCUPATIONAL SAFETY AND HEALTH ADMINISTRATION'S OCCUPATIONAL SAFETY AND HEALTH STANDARDS (OSHA); AND APPLICABLE SAFETY, HEALTH REGULATIONS AND BUILDING CODES FOR CONSTRUCTION IN THE STATE OF NEW YORK. THE CONTRACTOR SHALL BE RESPONSIBLE FOR GUARDING AND PROTECTING ALL OPEN EXCAVATIONS IN ACCORDANCE WITH THE PROVISION OF SECTION 107-05 (SAFETY AND HEALTH REQUIREMENTS) OF THE NYSDOT STANDARD SPECIFICATIONS. IF THE CONTRACTOR PERFORMS ANY HAZARDOUS CONSTRUCTION PRACTICES, ALL OPERATIONS IN THE AFFECTED AREA SHALL BE DISCONTINUED AND IMMEDIATE ACTION SHALL BE TAKEN TO CORRECT THE SITUATION TO THE SATISFACTION OF THE APPROVAL AUTHORITY HAVING JURISDICTION.
- 5. CONTRACTOR SHALL MAINTAIN ACCESS TO ALL PROPERTIES AFFECTED BY THE SCOPE OF WORK SHOWN HEREON AT ALL TIMES TO THE SATISFACTION OF THE OWNERS REPRESENTATIVE. RAMPING CONSTRUCTION TO PROVIDE ACCESS MAY BE CONSTRUCTED WITH SUBBASE MATERIAL EXCEPT THAT TEMPORARY ASPHALT CONCRETE SHALL BE PLACED AS DIRECTED BY THE ENGINEER. THE CONTRACTOR SHALL BE RESPONSIBLE FOR PROVIDING SAFE PEDESTRIAN ACCESS AT ALL TIMES.
- 6. CONTRACTOR SHALL MAINTAIN THE INTEGRITY OF EXISTING PAVEMENT TO REMAIN.

JMC Drawing List:

C-000 COVER SHEET

C-010 EXISTING CONDITIONS

C-020 DEMOLITION & TREE REMOVAL PLAN

C-100 LAYOUT PLAN

C-200 GRADING & UTILITIES PLAN

C-300 EROSION & SEDIMENT CONTROL PLAN

C-900 CONSTRUCTION DETAILS

C-901 CONSTRUCTION DETAILS

L-100 LANDSCAPING PLAN

TABLE OF LAND USE

SECTION 9, BLOCK 50, LOT 373

SEWER DISTRICT: PRIVATE ON	ISHE WASHEWAL	EK IKEAIMENI	SYSIEM	
DESCRIPTION		REQUIRED	EXISTING	PROPOSED
LOT AREA	(FEET)	20,000 MINIMUM	47,560 S.F.	47,560 S.F.
LOT WIDTH	(FEET)	100' MINIMUM	177'	177'
LOT FRONTAGE	(FEET)	100' MINIMUM	177'	177'
LOT DEPTH	(FEET)	100' MINIMUM	280'	280'
BUILDING HEIGHT	(STORIES/FEET)	2.5/35'	1.5/21'±	2.5/35'±
GROSS FLOOR AREA	(SQUARE FEET)	-	_	_
LOT COVERAGE BY PRINCIPAL BUILDING	(PERCENT)	35% MAXIMUM	3.4%	7.7%
OFF STREET PARKING SPACES	(EACH)	2	2	3
YARDS				
FRONT YARD SETBACK	(FEET)	25' MINIMUM	92'	90'
REAR YARD SETBACK	(FEET)	30' MINIMUM	162.9'	147'
SIDE YARD SETBACK	(FEET/TOTAL)	20' MIN/45' TOTAL	33.4'/93.8'	23.4'/56.3'
PARKING			_	
REAR/SIDE PARKING SETBACK	(FEET)	5' MINIMUM	26.7±	5'
TOTAL PARKING	(SPACES)	2 MINIMUM	1	3



SUBSURFACE UTILITY LOCATIONS ARE BASED ON A COMPILATION OF FIELD EVIDENCE, AVAILABLE RECORD PLANS AND/OR UTILITY MARK-OUTS. THE LOCATION OR COMPLETENESS OF UNDERGROUND INFORMATION CANNOT BE GUARANTEED. VERIFY THE ACTUAL LOCATION OF ALL UTILITIES PRIOR TO EXCAVATION OR CONSTRUCTION.



No.	Revision	Date	Ву
1.	REVISED BUILDING FOOTPRINT	04/11/2019	SPG
2.	UPDATED WETLAND LINES	02/28/2020	RC
3.	UPDATED SURVEY	05/11/2020	RAR
4.	REVISED PER VILLAGE COMMENTS	06/08/2020	RAR
5.	RESUBMIT TO VILLAGE HCZMC	07/01/2020	RAR
	Previous Editions Obsolete		



SPECIFICATIONS, PLATS AND REPORTS BEARING THE SEAL OF A LICENSED PROFESSIONAL ENGINEER OR LICENSED LAND SURVEYOR IS A VIOLATION OF SECTION 7209 OF THE NEW YORK STATE EDUCATION LAW, EXCEPT AS PROVIDED FOR BY SECTION 7209, SUBSECTION 2

ANY ALTERATION OF PLANS,


JMC Planning, Engineering, Landscape Architecture & Land Surveying, PLLC JMC Site Development Consultants, LLC John Meyer Consulting, Inc.

120 BEDFORD ROAD • ARMONK, NY 10504 voice 914.273.5225 • fax 914.273.2102 www.jmcpllc.com

NOT TO SCALE 07/24/2018 roject No: **18100**

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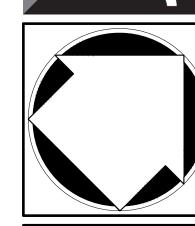
NOTES:

- 1. EXISTING CONDITIONS DEPICTED ON THIS PLAN HAVE BEEN TAKEN FROM SURVEY PREPARED BY SPINELLI SURVEYING, DATED 02/22/2018, LAST REVISED
- 2. WETLANDS FLAGGED BY ECOLOGICAL SOLUTIONS L.L.C.
- THE MEAN LOW WATER BOUNDARY IS BEYOND DRAWING LIMITS TOWARD THE DELANCEY COVE CHANNEL.
- 4. MEAN HIGH WATER: 3.39'
 MEAN HIGHER HIGH WATER: 3.75'
 MEAN LOW WATER: -3.90
 MEAN LOWER LOW WATER: -4.14

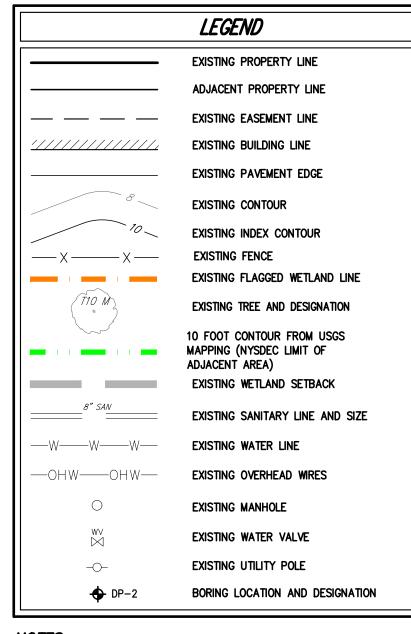

ABE

ELIS/



RESIDENTIAL DEVELOPMENT 1165 GREACEN POINT ROAD MAMARONECK, NY, 10543

CONDITIONS **EXISTING**

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Previous Editions Obsolete		
	REVISED BUILDING FOOTPRINT UPDATED WETLAND LINES UPDATED SURVEY REVISED PER VILLAGE COMMENTS RESUBMIT TO VILLAGE HCZMC	REVISED BUILDING FOOTPRINT UPDATED WETLAND LINES 02/28/2020 UPDATED SURVEY 05/11/2020 REVISED PER VILLAGE COMMENTS 06/08/2020 RESUBMIT TO VILLAGE HCZMC 07/01/2020

Scale: 1" = 20' 07/24/2018



1. EXISTING CONDITIONS DEPICTED ON THIS PLAN HAVE BEEN TAKEN FROM SURVEY PREPARED BY SPINELLI SURVEYING, DATED 02/22/2018, LAST REVISED

2. THE CONTRACTOR SHALL VERIFY THE LOCATION OF EXISTING UTILITIES TO BE DEMOLISHED AND EXISTING UTILITIES TO BE PROTECTED. IF ANY DISCREPANCIES ARE FOUND, THE CONTRACTOR SHALL NOTIFY THE GENERAL CONTRACTOR AND JMC PRIOR TO THE START OF CONSTRUCTION.

3. PRIOR TO THE START OF ANY DEMOLITION THE CONTRACTOR SHALL OBTAIN ALL NECESSARY PERMITS AND/OR APPROVALS FROM THE VILLAGE OF MAMARONECK AND ALL OTHER AUTHORITIES HAVING JURISDICTION. CONTRACTOR SHALL PAY ALL OUTSTANDING FEES, CHARGES, AND DEPOSITS TO ACQUIRE SAID PERMITS. NO DEMOLITION SHALL COMMENCE UNTIL A PERMIT HAS BEEN OBTAINED FROM

4. THE CONTRACTOR SHALL COORDINATE THE DISCONNECTION OF ALL UTILITIES WITH THE UTILITY COMPANY HAVING JURISDICTION PRIOR TO THE START OF DEMOLITION. CONFIRMATION OF DISCONNECTED UTILITIES SHALL BE PROVIDED TO THE VILLAGE OF MAMARONECK BUILDING DEPARTMENT IN ACCORDANCE WITH THEIR REQUIREMENTS. LETTERS FROM THE APPROPRIATE UTILITIES STATING THAT GAS AND ELECTRIC HAVE BEEN CUT OFF SHALL BE PROVIDED TO THE TOWN.

5. ANY UNSUITABLE MATERIAL FOUND ON-SITE DURING DEMOLITION/CONSTRUCTION, AS DETERMINED BY THE PROJECT'S GEOTECHNICAL ENGINEER, SHALL BE PROPERLY DISPOSED OF OFF-SITE IN A MANNER APPROVED BY ALL AUTHORITIES HAVING JURISDICTION AND REPLACED WITH SUITABLE MATERIAL AS REQUIRED. 6. ANY UNSUITABLE MATERIAL FOUND ON-SITE DURING CONSTRUCTION SHALL BE

DISPOSED OF OFF-SITE IN A MANNER APPROVED BY ALL AUTHORITIES HAVING JURISDICTION AND REPLACED WITH SUITABLE MATERIAL AS REQUIRED. ALL REMOVAL AND REPLACEMENT OF UNSUITABLE MATERIAL SHALL BE COMPLETED UNDER THE DIRECT SUPERVISION OF A GEOTECHNICAL ENGINEER. 7. ALL DEMOLITION AND/OR CONSTRUCTION WITHIN THE RIGHT-OF-WAY, INCLUDING

STREETS AND SIDEWALKS, SHALL BE PERFORMED IN ACCORDANCE WITH THE 8. ALL CONSTRUCTION/DEMOLITION DEBRIS NOT PROPOSED TO BE RECYCLED SHALL BE REMOVED AND LEGALLY DISPOSED OF OFF-SITE IN ACCORDANCE WITH THE REGULATIONS OF ALL LOCAL, STATE AND FEDERAL AGENCIES HAVING

9. EXISTING CONCRETE MAY BE STORED ON SITE, AND RECYCLED FOR USE AS

COMPACTED FILL. ALL MATERIAL TO BE USED AS FILL SHALL BE APPROVED BY THE PROJECT GEOTECHNICAL ENGINEER. 10. PRIOR TO THE START OF SITE DEMOLITION, EROSION AND SEDIMENT CONTROL

AND/OR DIRECTED BY THE VILLAGE OF MAMARONECK OR JMC. 11. EXISTING DRAINAGE PATTERNS ON SITE SHALL BE MAINTAINED TO THE MAXIMUM EXTENT PRACTICABLE.

12. ALL EXISTING SIDEWALKS, CURBS, PAVEMENT, ETC. TO REMAIN, WHICH ARE DISTURBED OR DAMAGED DUE TO THE NEW CONSTRUCTION, ARE TO BE REPLACED WITH MATERIALS CONSISTENT WITH EXISTING CONDITIONS.

13. THESE PLANS ARE TO BE PROVIDED TO BOTH THE DEMOLITION CONTRACTOR AND THE SITE CONTRACTOR FOR THEIR USE, INFORMATION AND COORDINATION. ANY QUESTIONS OF CONTRACTOR RESPONSIBILITY AND/OR SEPARATION OF WORK SHALL BE DIRECTED TO THE GENERAL CONTRACTOR IN WRITING PRIOR TO ISSUANCE OF BID.

14. THE OWNER SHALL RETAIN A LICENSED AND QUALIFIED PROFESSIONAL, CERTIFIED BY THE TOWN, TO INSPECT FOR THE PRESENCE OF ASBESTOS AND/OR OTHER HAZARDOUS MATERIALS WITHIN DEMOLITION AREAS PRIOR TO THE COMMENCEMENT OF DEMOLITION. IF REMEDIATION IS REQUIRED, THE OWNER SHALL DO SO IN ACCORDANCE WITH THE COUNTY ASBESTOS RULES AND REGULATIONS AND/OR ANY AUTHORITIES HAVING JURISDICTION. THE CONTRACTOR SHALL PROVIDE ALL REQUIRED DOCUMENTATION TO THE TOWN PRIOR TO OBTAINING A DEMOLITION

15. PRIOR TO COMMENCEMENT OF DEMOLITION, THE CONTRACTOR MUST PROVIDE 24-HOUR NOTIFICATION TO THE TOWN.

LEGEND EXISTING PROPERTY LINE ADJACENT PROPERTY LINE EXISTING EASEMENT LINE

EXISTING BUILDING LINE

EXISTING PAVEMENT EDGE

EXISTING INDEX CONTOUR

EXISTING CURB LINE

EXISTING CONTOUR

EXISTING FENCE

ELIS,

EXISTING TREE AND DESIGNATION

EXISTING TREE TO BE REMOVED


EXISTING WETLAND SETBACK

EXISTING STORM DRAIN LINE AND SIZE EXISTING SANITARY LINE AND SIZE

EXISTING WATER LINE —OHW——OHW— EXISTING OVERHEAD WIRES

EXISTING MANHOLE EXISTING WATER VALVE EXISTING UTILITY POLE

BORING LOCATION AND DESIGNATION EXISTING FEATURE TO BE REMOVED

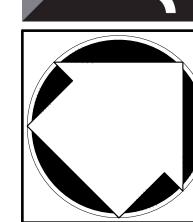



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0.	Revision		Date	Ву	Drawn:	SMN Appro	oved: JAR
1.	REVISED BUILDING FOOTPRINT		04/11/2019	SPG	Scale:	1" = 20'	
2.	UPDATED WETLAND LINES		02/28/2020	RC	Date:	07/24/201	В
5.	UPDATED SURVEY		05/11/2020	RAR	Project No:	18100	
ŀ.	REVISED PER VILLAGE COMMENTS		06/08/2020	RAR	18100-SITE	DEMO	DEMO.scr
5.	RESUBMIT TO VILLAGE HCZMC		07/01/2020	RAR	Drawing No:		
	Previous Editions Obsolete				C	-02	20

ANY ALTERATION OF PLANS, SPECIFICATIONS, PLATS AND REPORTS BEARING THE SEAL



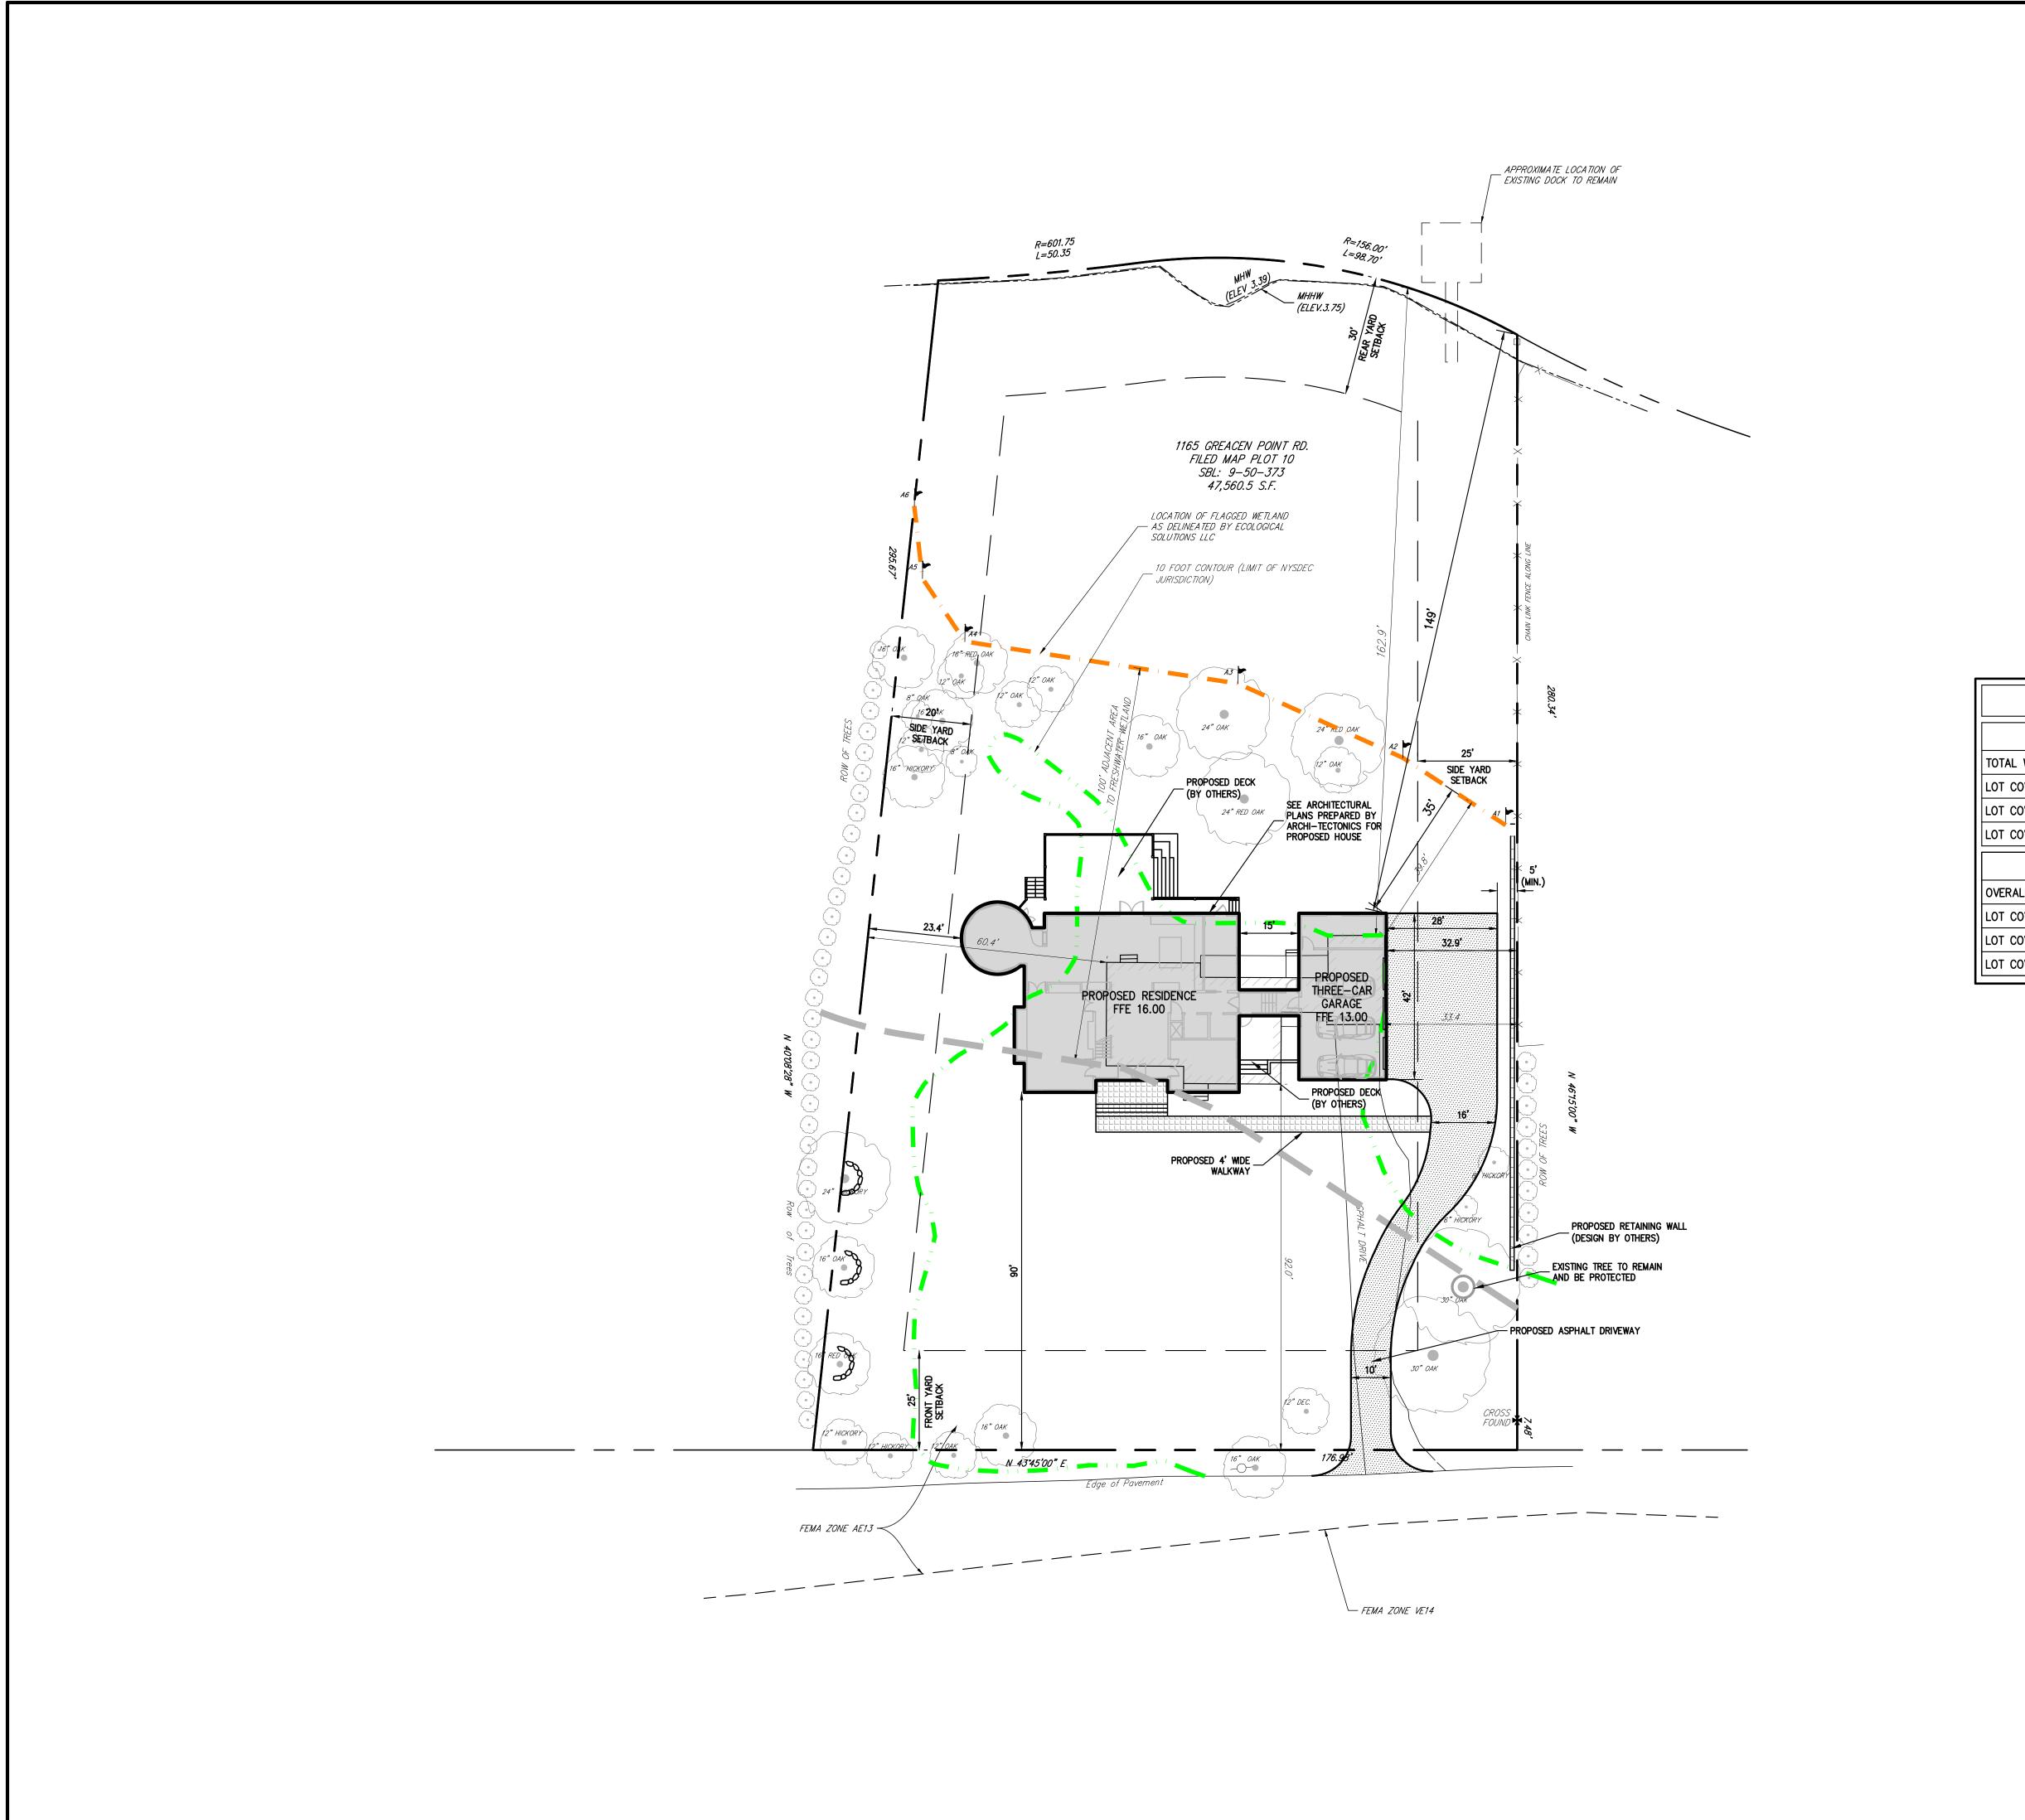

EXISTING CONDITIONS DEPICTED ON THIS PLAN HAVE BEEN TAKEN FROM SURVEY PREPARED BY SPINELLI SURVEYING, DATED 02/22/2018, LAST REVISED 04/23/2020.

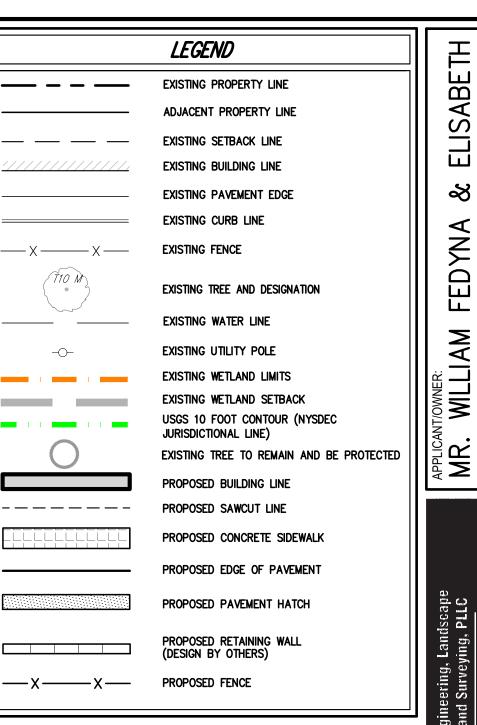
LOT COVERAGES						
WETLAND BUFFER	R	EXISTING	PROPOSED			
TOTAL WETLAND BUFFER COVERAGE	(S.F./PERCENT)	2,455±/6.6	5,428±/11.4			
LOT COVERAGE (PRINCIPAL BUILDING)	(S.F./PERCENT)	1,597±/3.4	3,461±/7.3			
LOT COVERAGE (SIDEWALK)	(S.F./PERCENT)	232±/0.05	199±/0.04			
LOT COVERAGE (DRIVEWAY)	(S.F./PERCENT)	626±/1.3	1,768±/3.7			
OVERALL SITE		EXISTING	PROPOSED			
OVERALL LOT COVERAGE	(S.F./PERCENT)	3,149±/6.6	6,480±/13.6			
LOT COVERAGE (PRINCIPAL BUILDING)	(S.F./PERCENT)	1,597±/3.4	3,655±/7.7			
LOT COVERAGE (SIDEWALK)	(S.F./PERCENT)	234±/0.05	499±/1.0			
LOT COVERAGE (DRIVEWAY)	(S.F./PERCENT)	1,318±/2.8	2,326±/4.9			


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	Previous Editions Obsolete		

rawn: SMN Approved: JAR Scale: 1" = 20' Date: 07/24/2018 Project No: 18100 18100-SITE LAYOUT LAY.scr



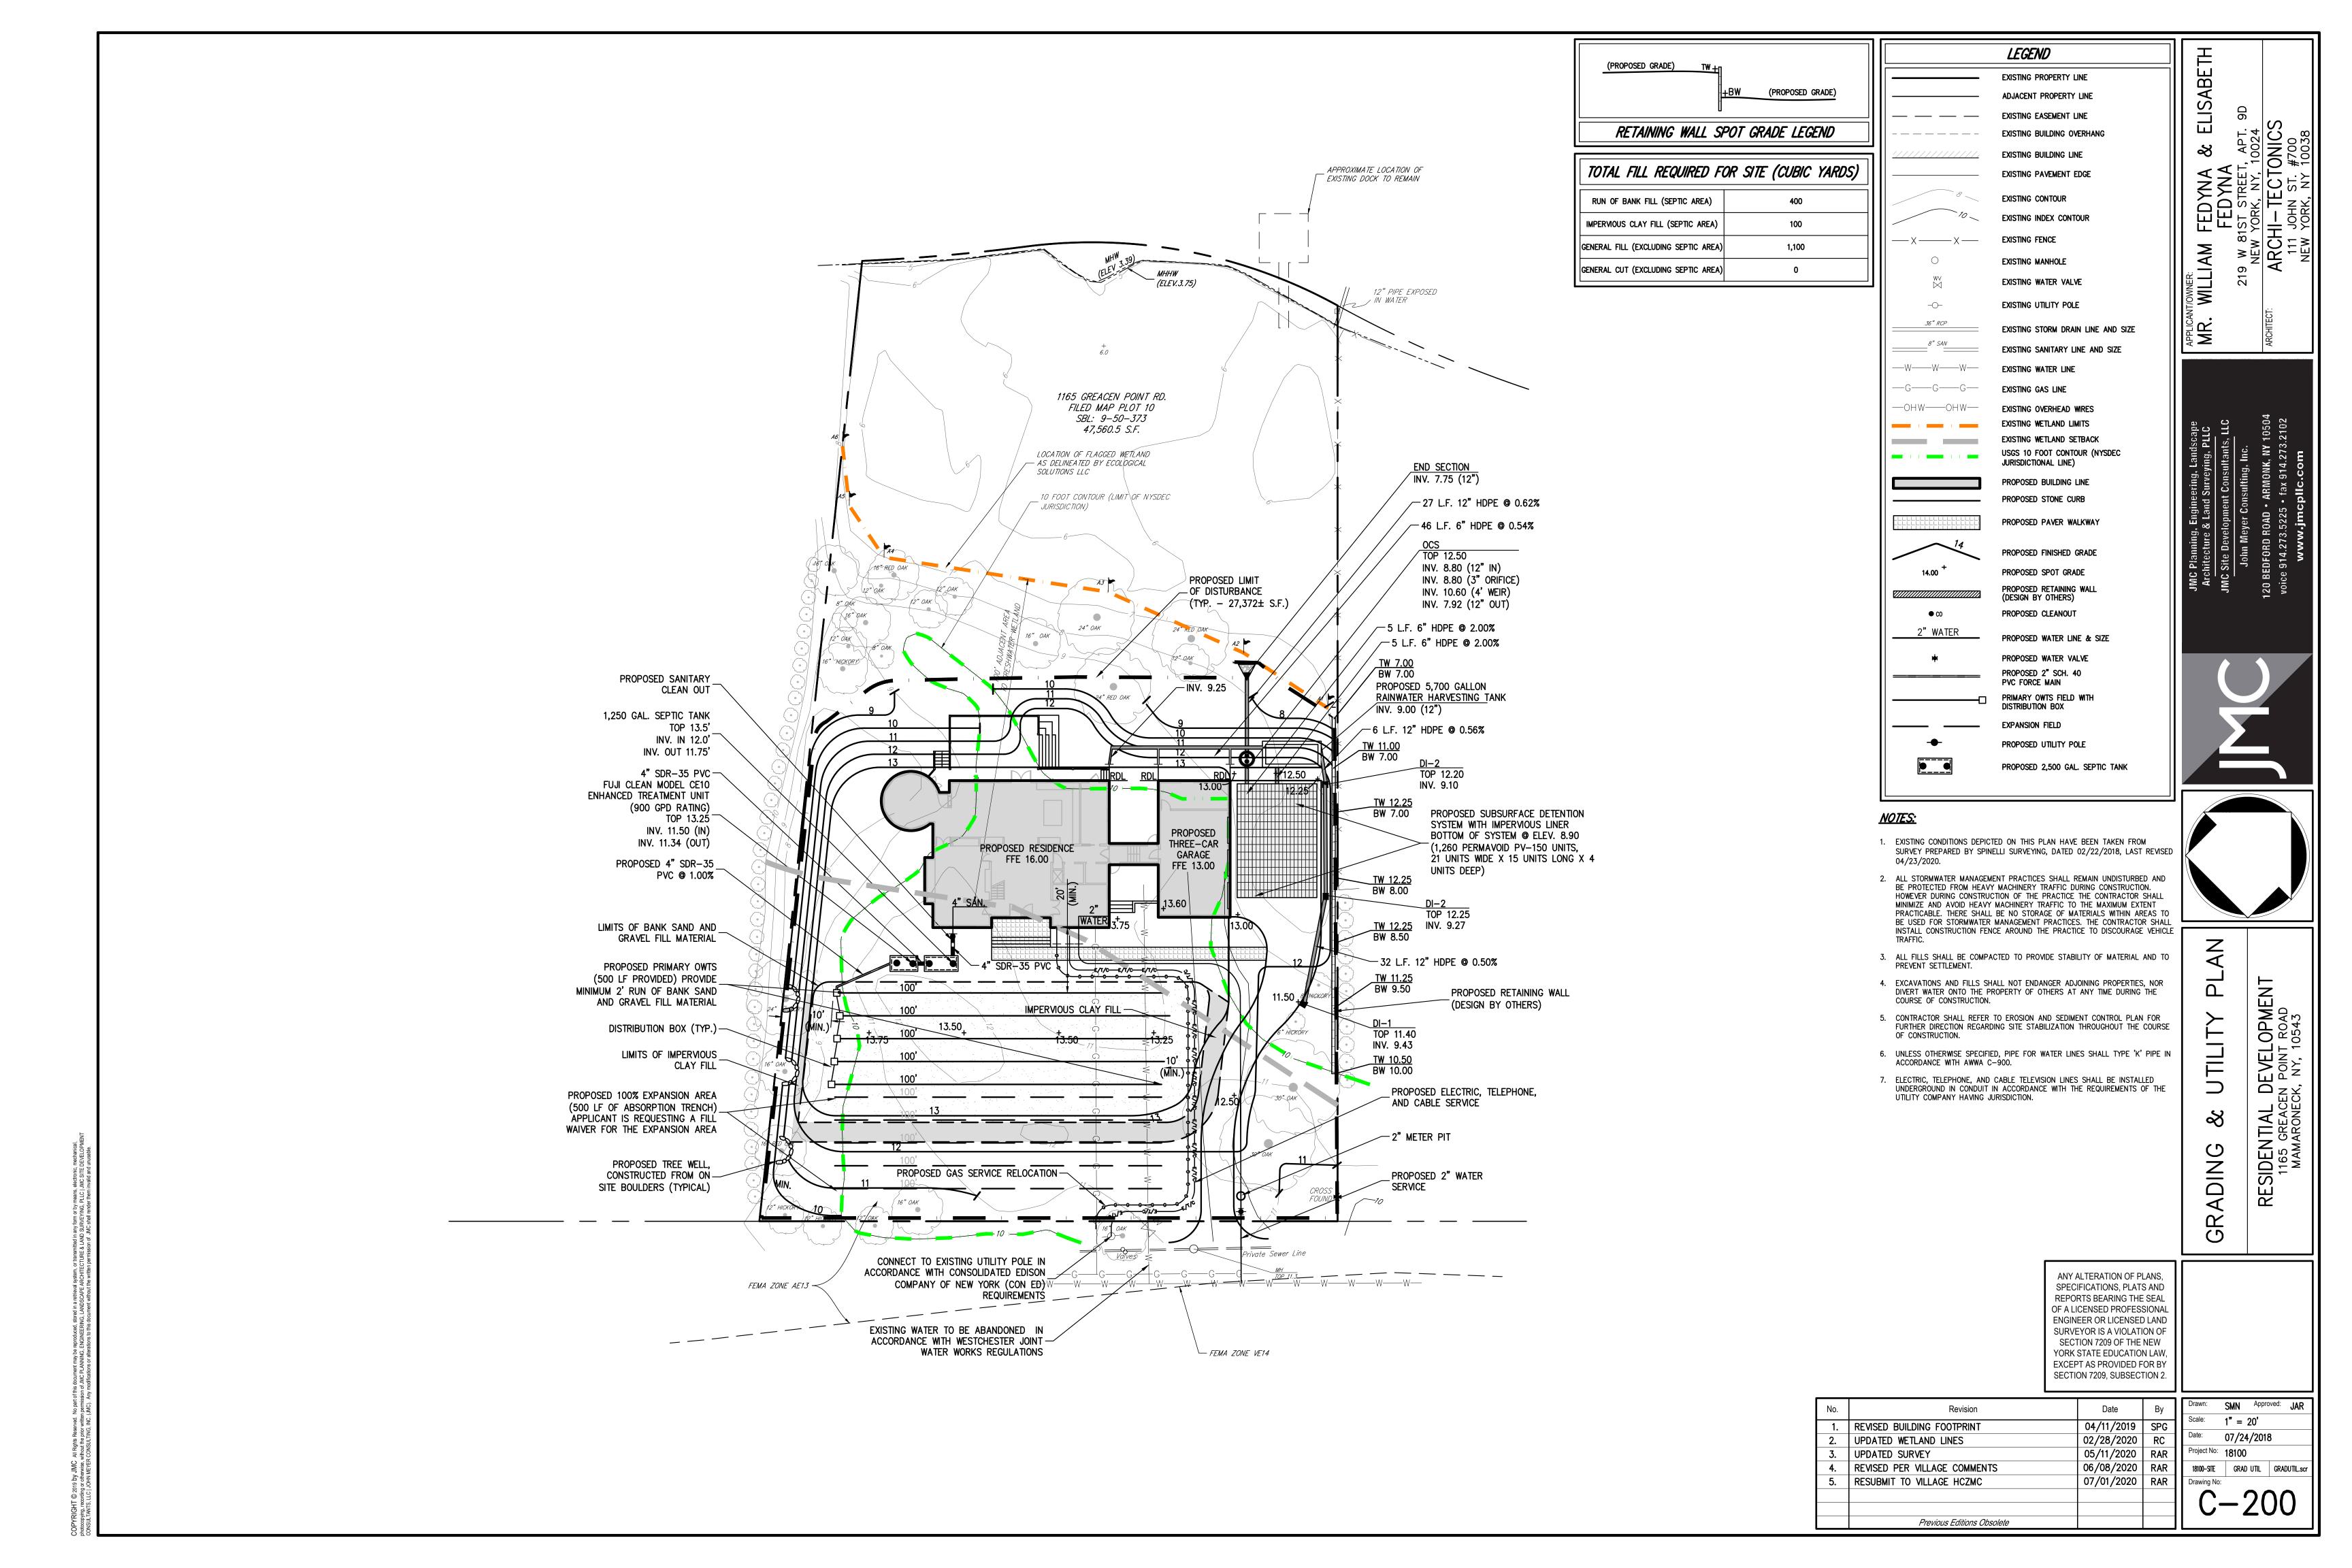

NOTES:

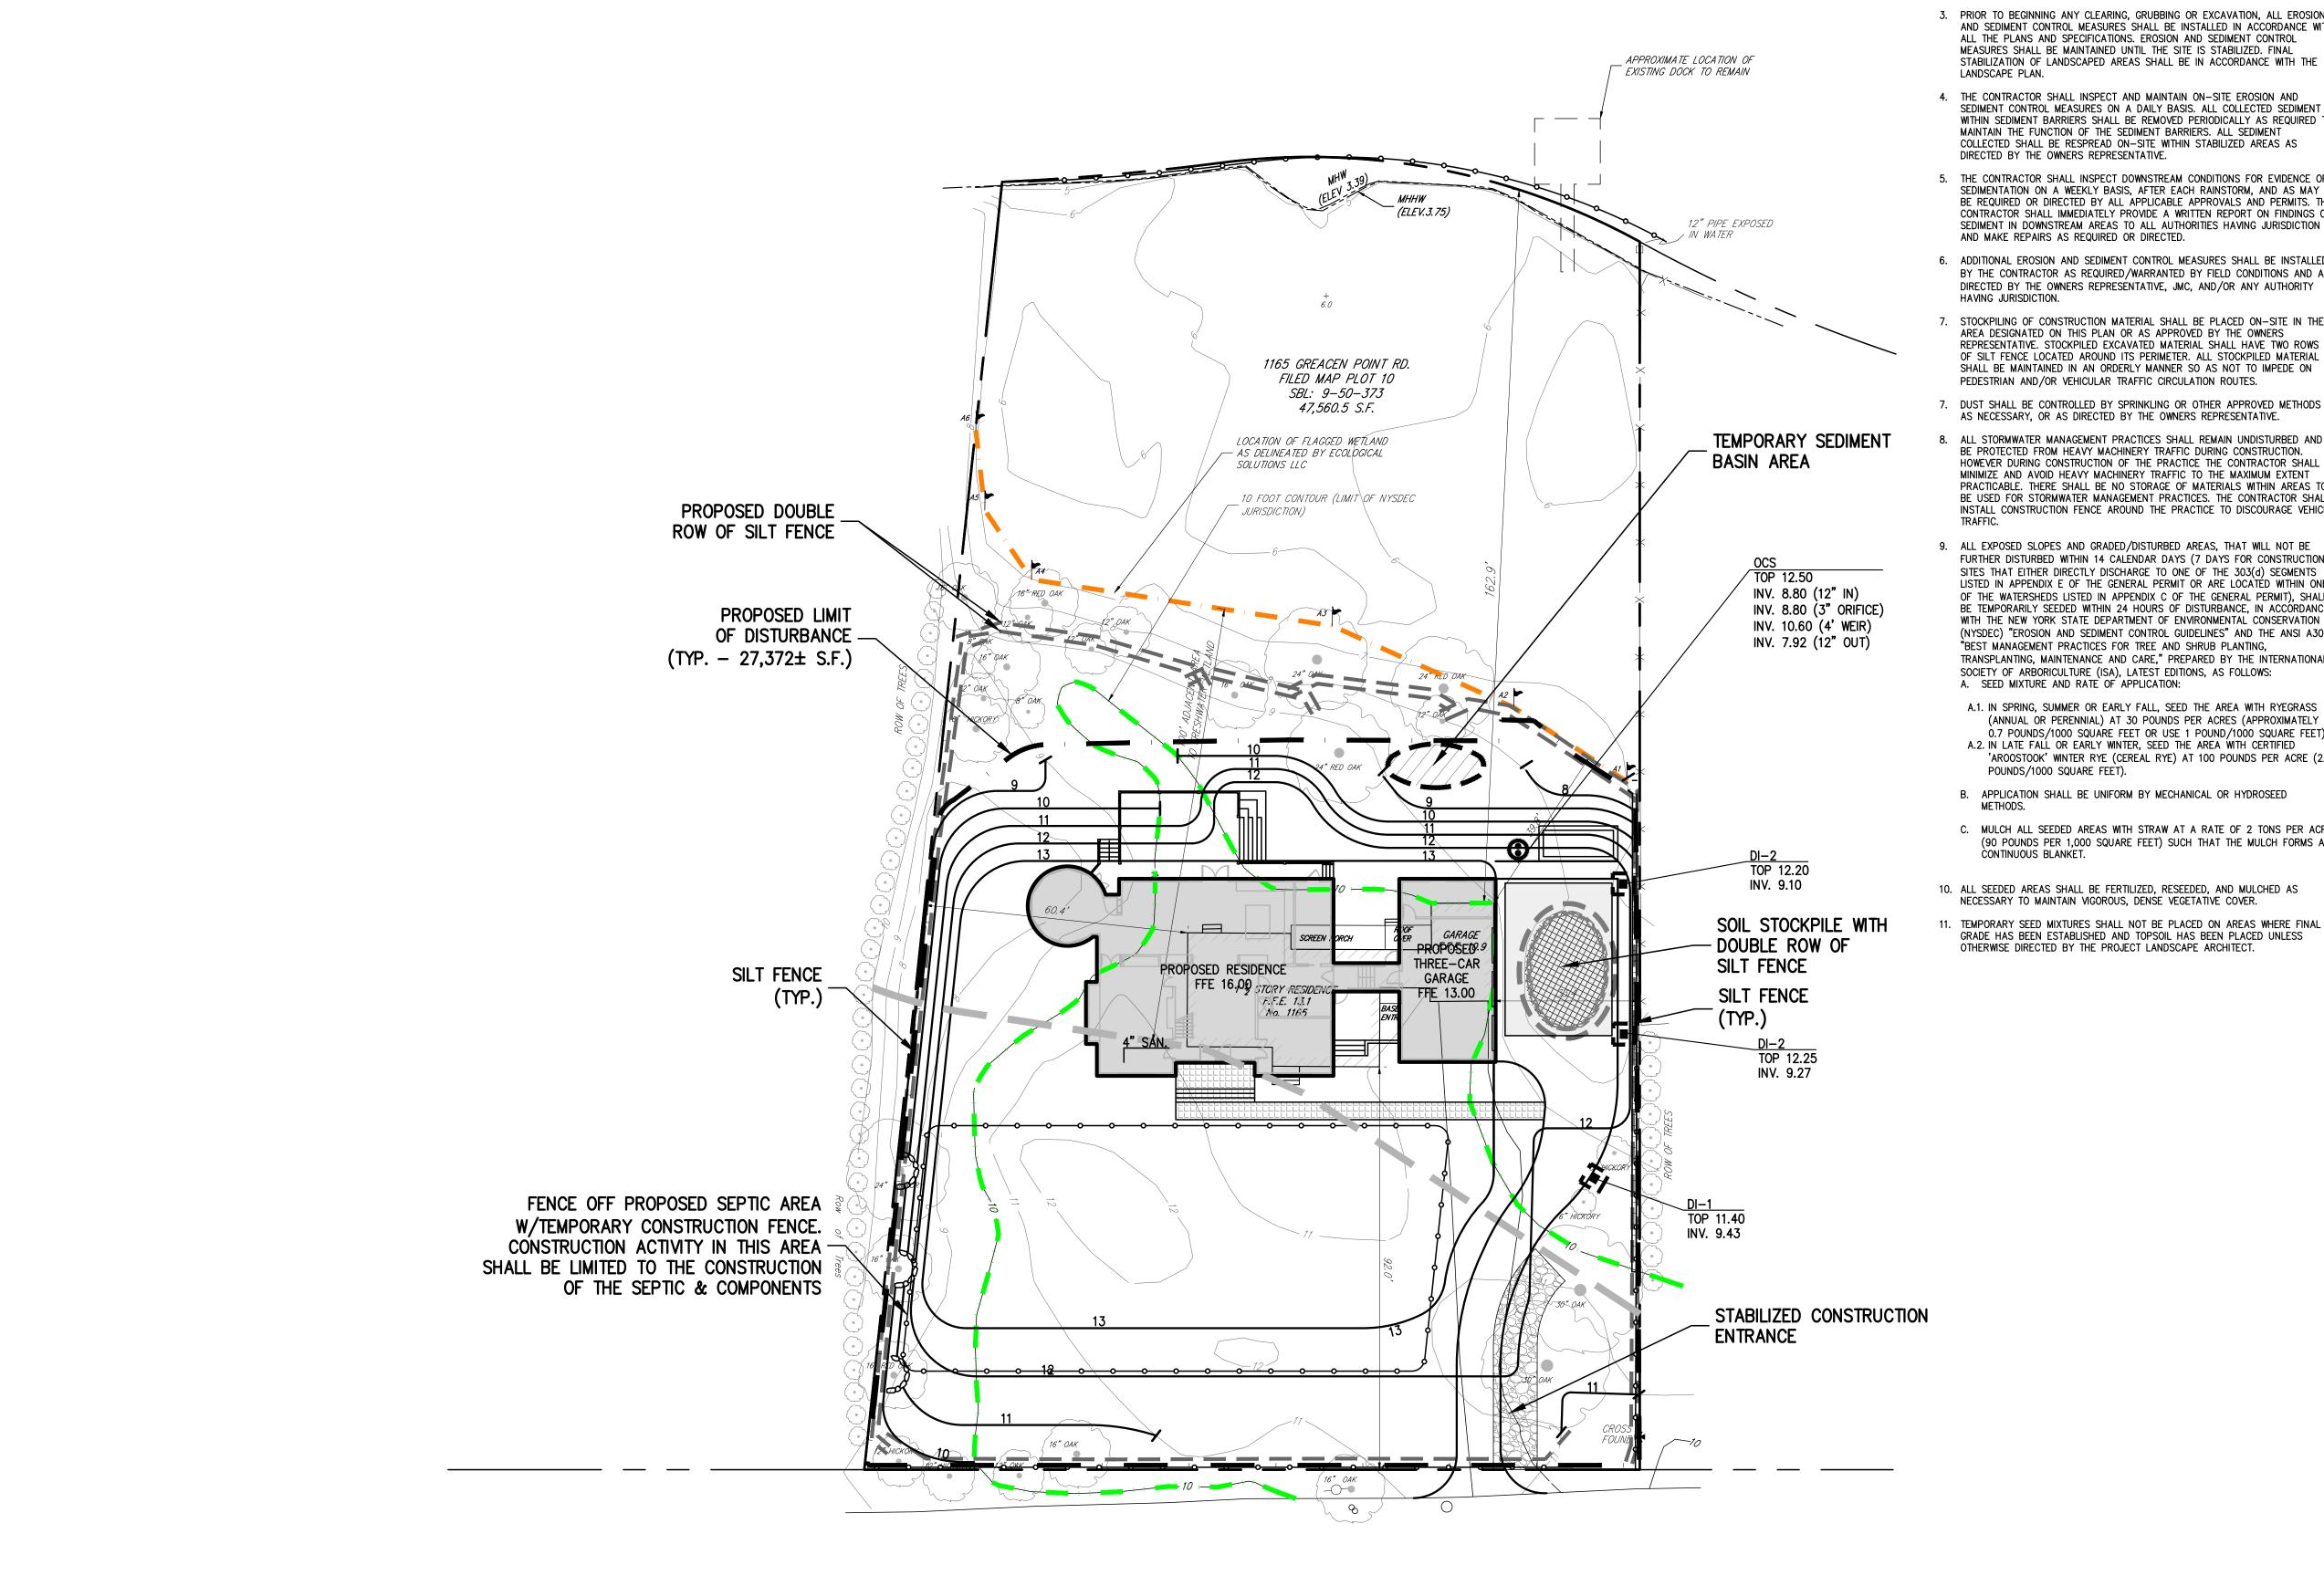- 1. EXISTING CONDITIONS DEPICTED ON THIS PLAN HAVE BEEN TAKEN FROM SURVEY PREPARED BY SPINELLI SURVEYING, DATED 02/22/2018, LAST REVISED
- 2. THIS PLAN IS FOR TEMPORARY EROSION AND SEDIMENT CONTROL INFORMATION
- 3. PRIOR TO BEGINNING ANY CLEARING, GRUBBING OR EXCAVATION, ALL EROSION AND SEDIMENT CONTROL MEASURES SHALL BE INSTALLED IN ACCORDANCE WITH ALL THE PLANS AND SPECIFICATIONS. EROSION AND SEDIMENT CONTROL MEASURES SHALL BE MAINTAINED UNTIL THE SITE IS STABILIZED. FINAL STABILIZATION OF LANDSCAPED AREAS SHALL BE IN ACCORDANCE WITH THE
- 4. THE CONTRACTOR SHALL INSPECT AND MAINTAIN ON-SITE EROSION AND SEDIMENT CONTROL MEASURES ON A DAILY BASIS. ALL COLLECTED SEDIMENT WITHIN SEDIMENT BARRIERS SHALL BE REMOVED PERIODICALLY AS REQUIRED TO MAINTAIN THE FUNCTION OF THE SEDIMENT BARRIERS. ALL SEDIMENT COLLECTED SHALL BE RESPREAD ON-SITE WITHIN STABILIZED AREAS AS DIRECTED BY THE OWNERS REPRESENTATIVE.
- 5. THE CONTRACTOR SHALL INSPECT DOWNSTREAM CONDITIONS FOR EVIDENCE OF SEDIMENTATION ON A WEEKLY BASIS, AFTER EACH RAINSTORM, AND AS MAY BE REQUIRED OR DIRECTED BY ALL APPLICABLE APPROVALS AND PERMITS. THE CONTRACTOR SHALL IMMEDIATELY PROVIDE A WRITTEN REPORT ON FINDINGS OF SEDIMENT IN DOWNSTREAM AREAS TO ALL AUTHORITIES HAVING JURISDICTION AND MAKE REPAIRS AS REQUIRED OR DIRECTED.
- 6. ADDITIONAL EROSION AND SEDIMENT CONTROL MEASURES SHALL BE INSTALLED BY THE CONTRACTOR AS REQUIRED/WARRANTED BY FIELD CONDITIONS AND AS DIRECTED BY THE OWNERS REPRESENTATIVE, JMC, AND/OR ANY AUTHORITY HAVING JURISDICTION.
- STOCKPILING OF CONSTRUCTION MATERIAL SHALL BE PLACED ON-SITE IN THE AREA DESIGNATED ON THIS PLAN OR AS APPROVED BY THE OWNERS REPRESENTATIVE. STOCKPILED EXCAVATED MATERIAL SHALL HAVE TWO ROWS OF SILT FENCE LOCATED AROUND ITS PERIMETER. ALL STOCKPILED MATERIAL SHALL BE MAINTAINED IN AN ORDERLY MANNER SO AS NOT TO IMPEDE ON PEDESTRIAN AND/OR VEHICULAR TRAFFIC CIRCULATION ROUTES.
- 7. DUST SHALL BE CONTROLLED BY SPRINKLING OR OTHER APPROVED METHODS AS NECESSARY, OR AS DIRECTED BY THE OWNERS REPRESENTATIVE.
- 8. ALL STORMWATER MANAGEMENT PRACTICES SHALL REMAIN UNDISTURBED AND BE PROTECTED FROM HEAVY MACHINERY TRAFFIC DURING CONSTRUCTION. HOWEVER DURING CONSTRUCTION OF THE PRACTICE THE CONTRACTOR SHALL MINIMIZE AND AVOID HEAVY MACHINERY TRAFFIC TO THE MAXIMUM EXTENT PRACTICABLE. THERE SHALL BE NO STORAGE OF MATERIALS WITHIN AREAS TO BE USED FOR STORMWATER MANAGEMENT PRACTICES. THE CONTRACTOR SHALL INSTALL CONSTRUCTION FENCE AROUND THE PRACTICE TO DISCOURAGE VEHICLE
- 9. ALL EXPOSED SLOPES AND GRADED/DISTURBED AREAS, THAT WILL NOT BE FURTHER DISTURBED WITHIN 14 CALENDAR DAYS (7 DAYS FOR CONSTRUCTION SITES THAT EITHER DIRECTLY DISCHARGE TO ONE OF THE 303(d) SEGMENTS LISTED IN APPENDIX E OF THE GENERAL PERMIT OR ARE LOCATED WITHIN ONE OF THE WATERSHEDS LISTED IN APPENDIX C OF THE GENERAL PERMIT), SHALL BE TEMPORARILY SEEDED WITHIN 24 HOURS OF DISTURBANCE, IN ACCORDANCE WITH THE NEW YORK STATE DEPARTMENT OF ENVIRONMENTAL CONSERVATION (NYSDEC) "EROSION AND SEDIMENT CONTROL GUIDELINES" AND THE ANSI A300 "BEST MANAGEMENT PRACTICES FOR TREE AND SHRUB PLANTING, TRANSPLANTING, MAINTENANCE AND CARE," PREPARED BY THE INTERNATIONAL SOCIETY OF ARBORICULTURE (ISA), LATEST EDITIONS, AS FOLLOWS: A. SEED MIXTURE AND RATE OF APPLICATION:
- 0.7 POUNDS/1000 SQUARE FEET OR USE 1 POUND/1000 SQUARE FEET). A.2. IN LATE FALL OR EARLY WINTER, SEED THE AREA WITH CERTIFIED 'AROOSTOOK' WINTER RYE (CEREAL RYE) AT 100 POUNDS PER ACRE (2.5 POUNDS/1000 SQUARE FEET).
- B. APPLICATION SHALL BE UNIFORM BY MECHANICAL OR HYDROSEED
- C. MULCH ALL SEEDED AREAS WITH STRAW AT A RATE OF 2 TONS PER ACRE (90 POUNDS PER 1,000 SQUARE FEET) SUCH THAT THE MULCH FORMS A CONTINUOUS BLANKET.
- 10. ALL SEEDED AREAS SHALL BE FERTILIZED, RESEEDED, AND MULCHED AS NECESSARY TO MAINTAIN VIGOROUS, DENSE VEGETATIVE COVER.
- 11. TEMPORARY SEED MIXTURES SHALL NOT BE PLACED ON AREAS WHERE FINAL GRADE HAS BEEN ESTABLISHED AND TOPSOIL HAS BEEN PLACED UNLESS
 OTHERWISE DIRECTED BY THE PROJECT LANDSCAPE ARCHITECT.

LEGEND

EXISTING WETLAND SETBACK PROPOSED SILT FENCE

PROPOSED LIMIT OF DISTURBANCE PROPOSED CONSTRUCTION FENCE

PROPOSED STABILIZED CONSTRUCTION A.A.A. ENTRANCE


SEQUENCE OF CONSTRUCTION

CONSTRUCTION SHALL BE SEQUENCED IN SUCH A MANNER THAT ANY AREA WHICH IS DISTURBED SHALL FIRST BE PROTECTED WITH SEDIMENT EROSION CONTROLS AS INDICATED ON THIS PLAN. PARTICULAR REQUIREMENTS ARE GIVEN

- AS FOLLOWS: 1. DEMOLITION OF EXISTING BUILDINGS AS REQUIRED.
- 2. INSTALLATION OF SEDIMENT AND EROSION CONTROL MEASURES AS INDICATED ON THIS PLAN.
- 3. CLEAR UNDEVELOPED PORTION OF PROPERTY WHICH IS TO BE DEVELOPED. 4. STRIP AND STOCKPILE TOPSOIL.
- 5. BEGIN BUILDING AND PARKING LOT CONSTRUCTION, ROUGH GRADING. 6. INSTALL STORM DRAIN SYSTEM COMPLETE (IMMEDIATELY INSTALL HAYBALE
- FILTERS ON ALL INLETS). 7. INSTALL PUBLIC UTILITIES (GAS, ELECTRIC AND TELEPHONE) AS REQUIRED.
- B. INSTALL CONCRETE AND ASPHALT CONCRETE PAVEMENT COMPLETE.
- 9. FINISH GRADING, REDISTRIBUTE TOPSOIL AND ESTABLISH VEGETATION AND/OR LANDSCAPING.
- O. CLEAN PAVEMENTS AND STORM DRAIN SYSTEM OF ALL ACCUMULATED SEDIMENT IN CONJUNCTION WITH THE REMOVAL OF ALL TEMPORARY SEDIMENT AND EROSION CONTROL DEVICES.
- 1. COMPLETE SITE AND BUILDING CONSTRUCTION.

PROPOSED STOCKPILE AREA WILLIAM

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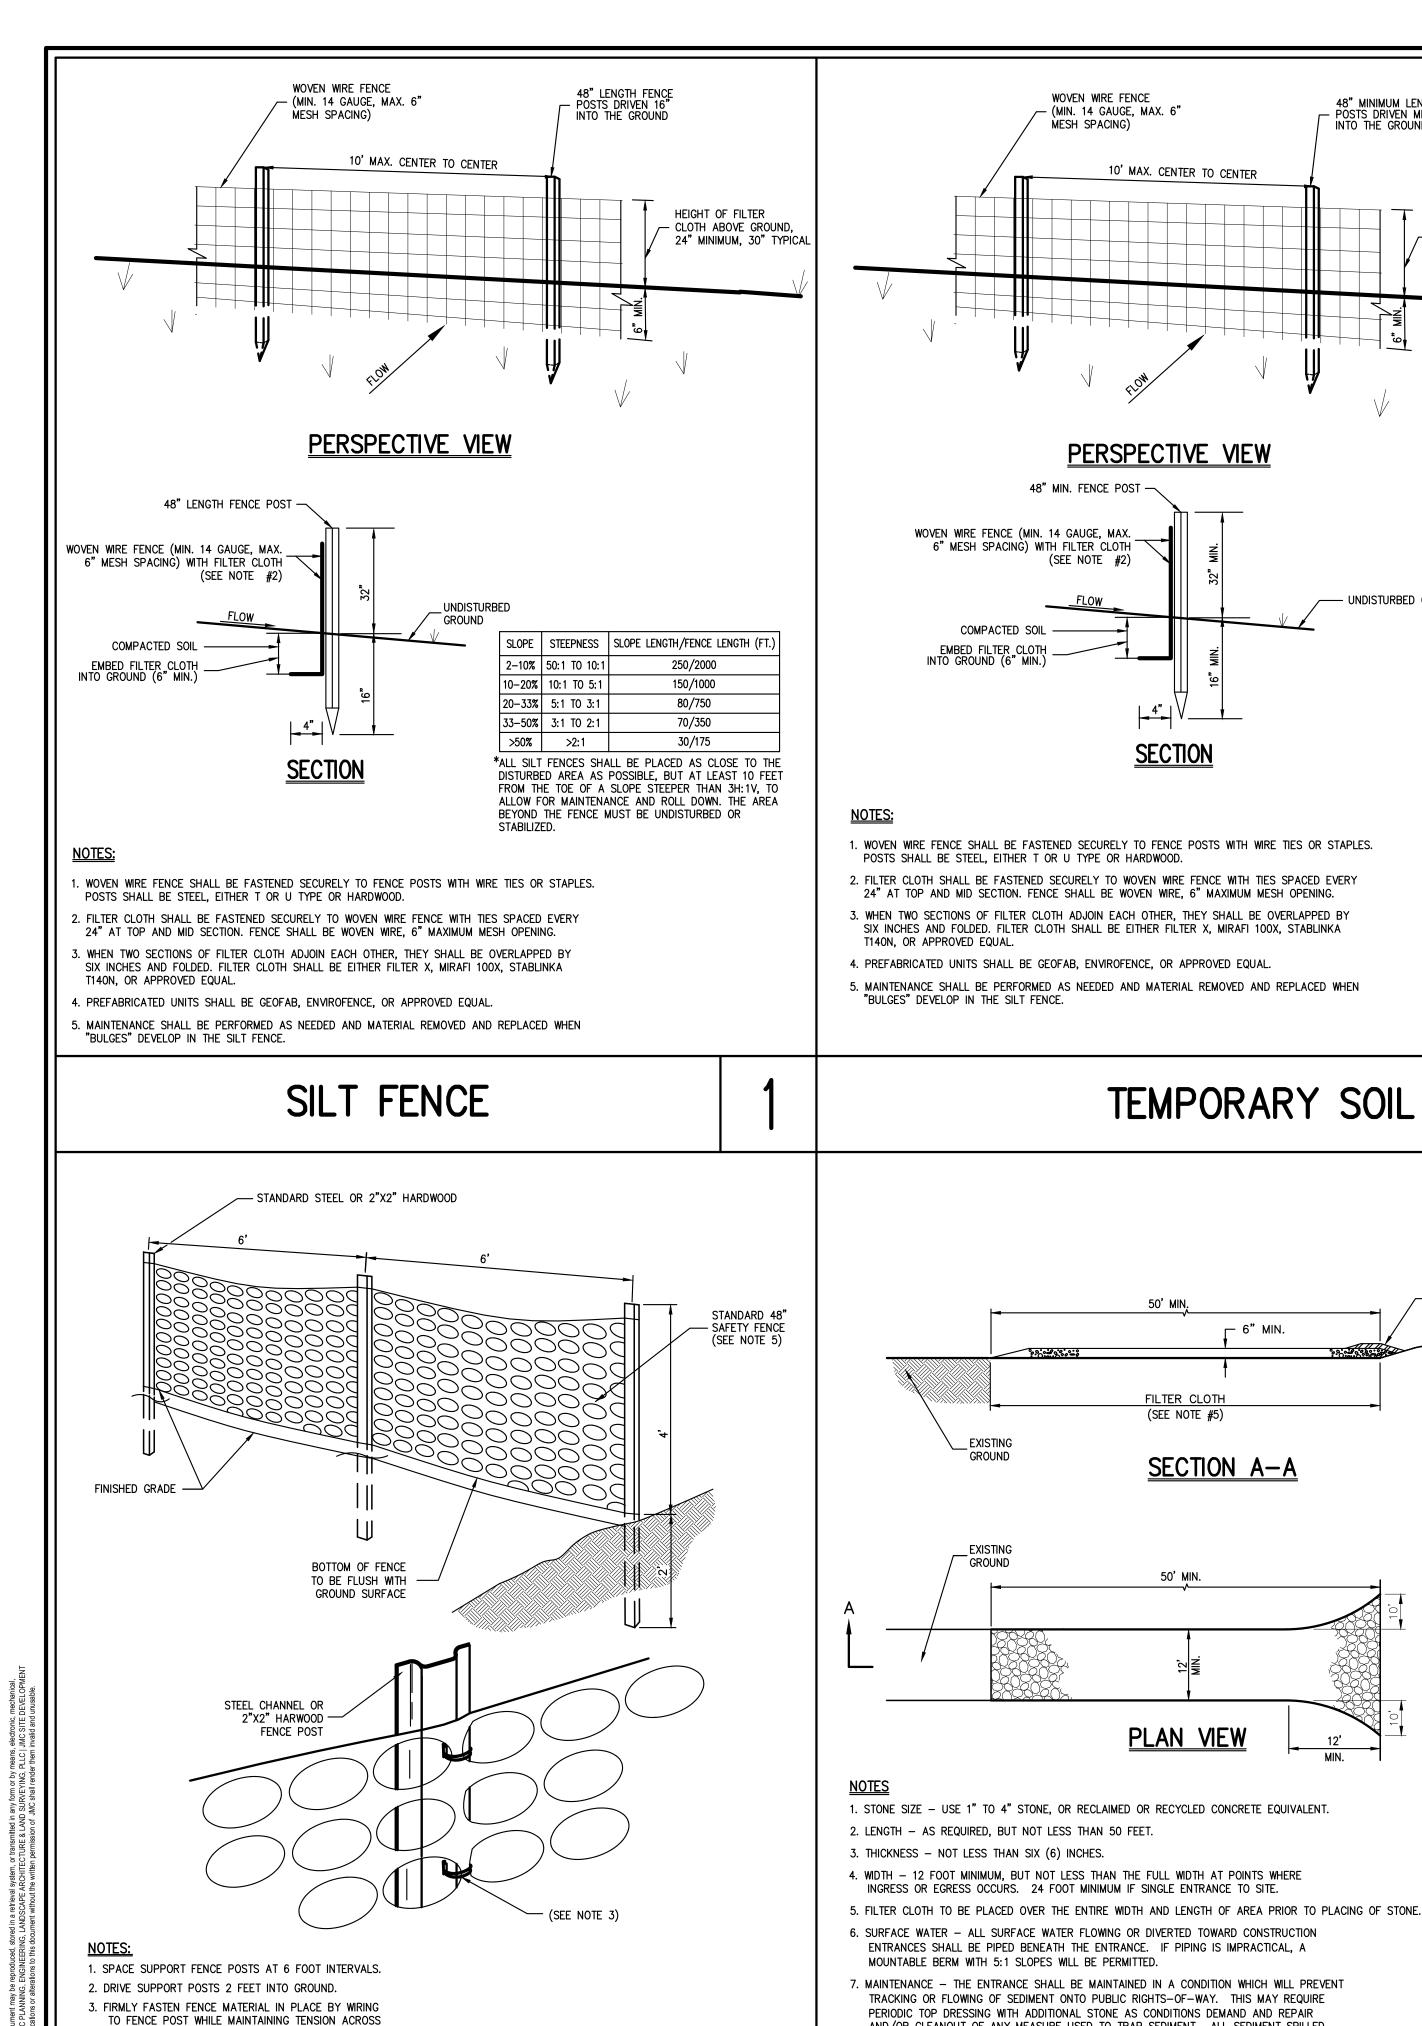


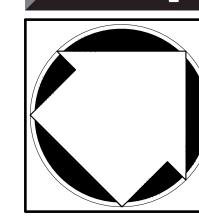
SEDIMENT PLAN

EROSION & SCONTROL SIDENTIAL 1165 GREACE MAMARONEC


ANY ALTERATION OF PLANS, SPECIFICATIONS, PLATS AND REPORTS BEARING THE SEAL OF A LICENSED PROFESSIONAL ENGINEER OR LICENSED LAND SURVEYOR IS A VIOLATION OF SECTION 7209 OF THE NEW YORK STATE EDUCATION LAW, EXCEPT AS PROVIDED FOR BY SECTION 7209, SUBSECTION 2.


No.	Revision	Date	Ву	Drawn:	SMN Appro	oved: JAR
1.	REVISED BUILDING FOOTPRINT	04/11/2019	SPG	Scale:	1" = 20'	
2.	UPDATED WETLAND LINES	02/28/2020	RC	Date:	07/24/2018	3
3.	UPDATED SURVEY	05/11/2020	RAR	Project No:	18100	
4.	REVISED PER VILLAGE COMMENTS	06/08/2020	RAR	18100-SITE	SE	SE.scr
5.	RESUBMIT TO VILLAGE HCZMC	07/01/2020	RAR	Drawing No:		
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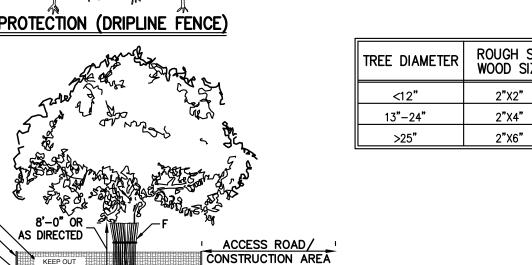


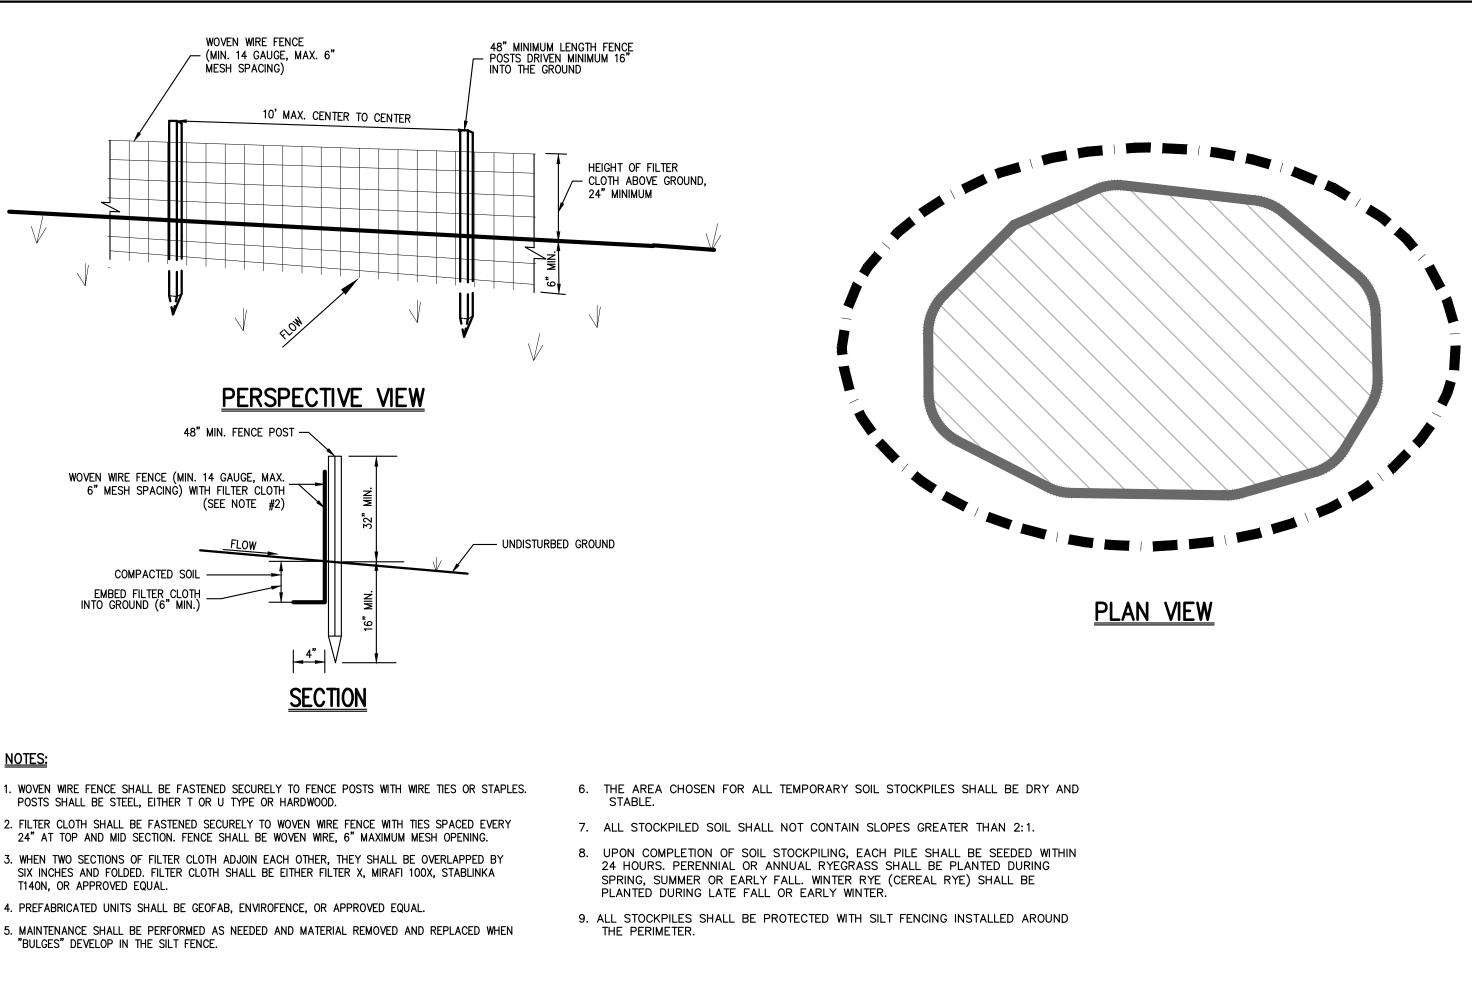

TEMPORARY SOIL STOCKPILE WITH SILT FENCE



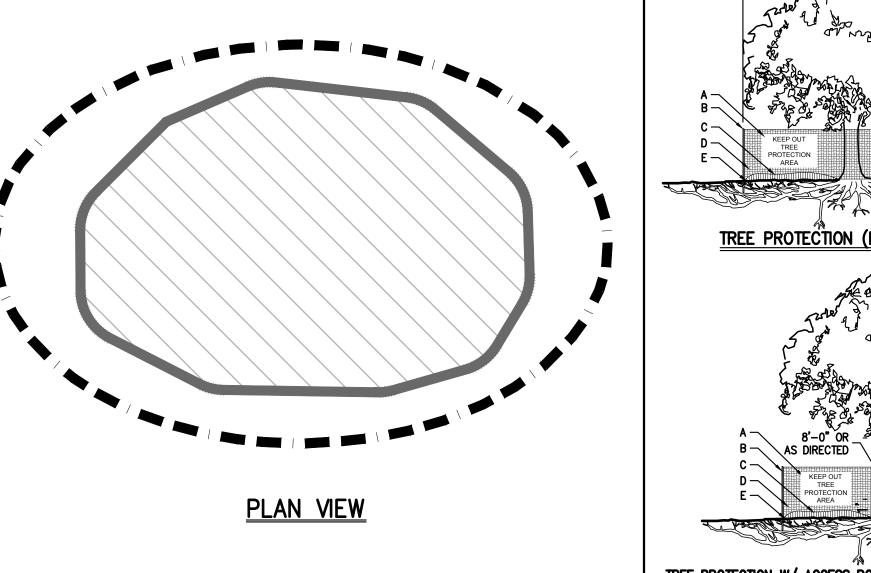


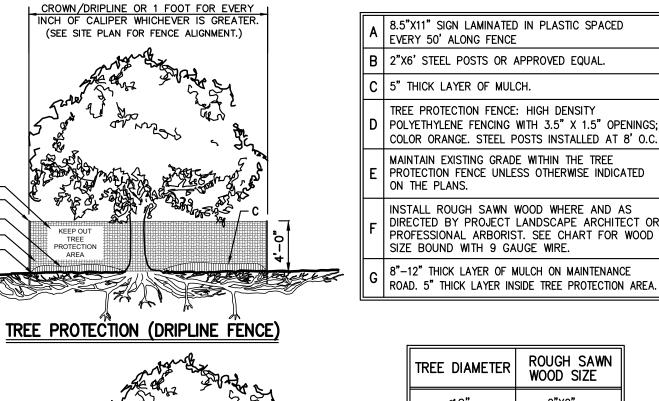

TREE PROTECTION W/ ACCESS ROAD/CONSTRUCTION AREA (DRIPLINE FENCE)

1. SEE SPECIFICATIONS FOR ADDITIONAL TREE PROTECTION REQUIREMENTS.

- 2. IF THERE IS NO EXISTING IRRIGATION, SEE SPECIFICATIONS FOR WATERING
- 3. NO PRUNING SHALL BE PERFORMED EXCEPT BY APPROVED ARBORIST.
- I. NO EQUIPMENT SHALL OPERATE INSIDE THE PROTECTIVE FENCING INCLUDING DURING FENCE INSTALLATION AND REMOVAL.
- 5. SEE SITE PLANS FOR IDENTIFICATIONS/LOCATIONS OF INDIVIDUAL TREES TO BE
- 6. ALL EXCAVATION WITHIN THE CROWN/DRIPLINE OF ANY TREE SHALL BE PERFORMED UNDER THE DIRECT SUPERVISION OF THE PROJECT LANDSCAPE ARCHITECT OR PROFESSIONAL ARBORIST. SPECIAL MEASURES, SUCH AS THE USE OF AN AIR SPADE MAY BE REQUIRED.
- . THE CONTRACTOR MAY PROPOSE THE USE OF ENGINEERED MATTING OR OTHER ENGINEERED PRODUCTS IN LIEU OF MULCH, WHICH SHALL BE SUBJECT TO THE REVIEW AND APPROVAL OF ALL AUTHORITIES HAVING JURISDICTION.

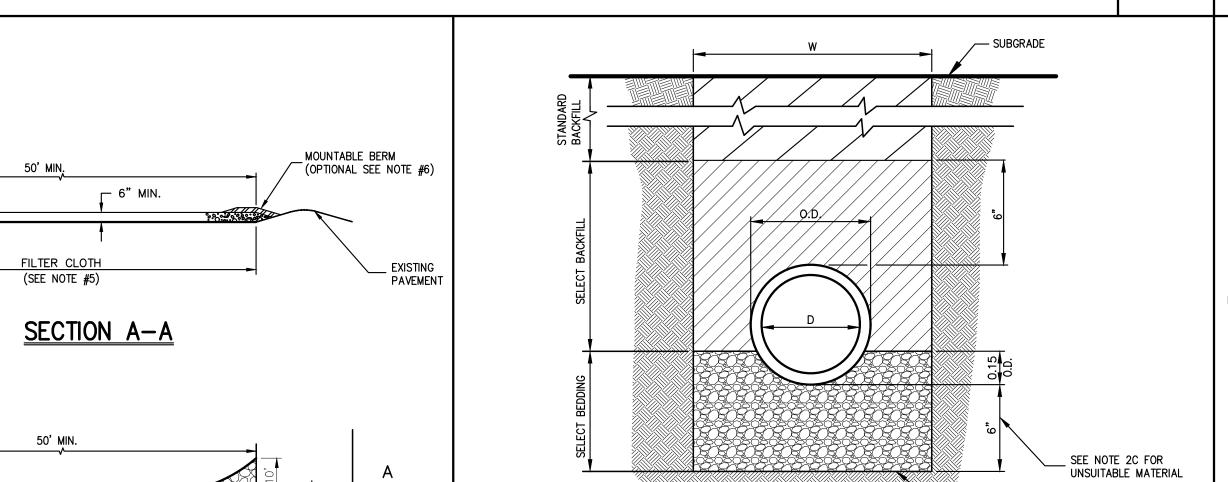

1. FOR TYPE II TRENCH, MATERIAL FOR SELECT BEDDING AND SELECT BACKFILL SHALL BE: A. EITHER SAND OR CRUSHED STONE IF NO WATER IS ENCOUNTERED IN TRENCH.

D=INSIDE DIAMETER, SPAN, OR RISE


O.D.=OUTSIDE BARREL DIAMETER, SPAN OR RISE

H.D.=OUTSIDE DIAMETER, SPAN, OR RISE @ BELL OR BAND

W=H.D. + 2.0' - FOR 48" OR SMALLER DIAMETER, SPAN, OR RISE

W=H.D. + 2.5' - FOR GREATER THAN 48" DIAMETER, SPAN, OR RISE

- B. 3/4"CRUSHED STONE IF WATER IS ENCOUNTERED IN TRENCH. 2. TYPE II TRENCH SHALL BE USED IN ALL OF THE FOLLOWING CASES: A. FOR ALL CORRUGATED POLYETHYLENE DRAIN PIPE (CPDP) AND
- PVC PIPE AND CONDUIT INSTALLATION. B. WHEN ROCK OR HARDPAN IS ENCOUNTERED IN BOTTOM OF TRENCH. C. WHEN UNSUITABLE MATERIAL IS ENCOUNTERED IN BOTTOM OF TRENCH. IN SUCH CASE DEPTH OF UNDERCUTTING SHALL BE AS DIRECTED BY THE ENGINEER WITH 6" MINIMUM.
- 3. FOR ALL TRENCH EXCAVATION IN FILL AREAS, ALL EMBANKMENTS SHALL BE CONSTRUCTED TO A MINIMUM OF 2 FEET ABOVE THE OUTSIDE TOP (AT THE BELL) OF THE PIPE PRIOR TO BEGINNING ANY TRENCH EXCAVATION.
- 4. BACKFILL FOR PIPE AND CONDUIT SHALL BE PLACED EVENLY AND CAREFULLY AROUND AND OVER THE PIPE OR CONDUIT IN SIX (6) INCH MAXIMUM LAYERS. EACH LAYER SHALL BE THOROUGHLY AND CAREFULLY COMPACTED UNTIL TWELVE (12) INCHES OF COVER EXISTS OVER THE PIPE OR CONDUIT. THE REMAINDER OF THE BACKFILL MAY THEN BE PLACED AND COMPACTED IN A MAXIMUM OF TWELVE (12) INCH LAYERS. EACH LAYER SHALL BE COMPACTED BY APPROVED MECHANICAL TAMPING MACHINES. UNLESS OTHERWISE SPECIFIED BACKFILL SHALL BE COMPACTED TO NOT LESS THAN 92% MAXIMUM MODIFIED DENSITY IN ACCORDANCE WITH ASTM DESIGNATION D-1557 IN THE MANNER HEREIN DESCRIBED. BACKFILL SHALL PROCEED UP TO THE LINES AND GRADES AS SHOWN ON THE DRAWINGS.

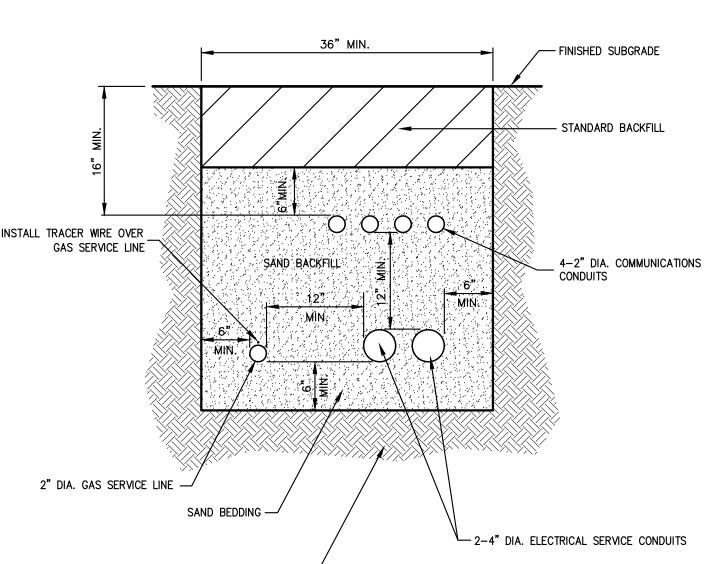

- 1. UTILITIES TO BE INSTALLED IN ACCORDANCE WITH THE REGULATIONS AND REQUIREMENTS OF THE UTILITY COMPANY HAVING JURISDICTION.
- 2. BACKFILL FOR PIPE AND CONDUIT SHALL BE PLACED EVENLY AND CAREFULLY AROUND AND OVER THE PIPE OR CONDUIT IN SIX (6) INCH MAXIMUM LAYERS. EACH LAYER SHALL BE THOROUGHLY AND CAREFULLY COMPACTED UNTIL TWELVE (12) INCHES OF COVER EXISTS OVER THE PIPE OR CONDUIT. THE REMAINDER OF THE BACKFILL MAY THEN BE PLACED AND COMPACTED IN A MAXIMUM OF TWELVE (12) INCH LAYERS. EACH LAYER SHALL BE COMPACTED BY APPROVED MECHANICAL TAMPING MACHINES. UNLESS OTHERWISE SPECIFIED BACKFILL SHALL BE COMPACTED TO NOT LESS THAN 92% MAXIMUM MODIFIED DENSITY IN ACCORDANCE WITH ASTM DESIGNATION D-1557 IN THE MANNER HEREIN DESCRIBED. BACKFILL SHALL PROCEED UP TO THE LINES AND GRADES AS SHOWN ON THE DRAWINGS.
- 3. CONTRACTOR SHALL STAKE THE PROPOSED SERVICE LINES AND CONDUITS PRIOR TO BACKFILLING TO ENSURE SERVICES DO NOT MOVE WITHIN TRENCH.

APPROVED SUBGRADE-

TREE PROTECTION

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SMN Approved: JAR NOT TO SCALE 07/24/2018

³roject No: **18100** 18100-DETAILS C-900

TYPE II TRENCH

UTILITY TRENCH DETAIL

CONSTRUCTION FENCE

FULL HEIGHT OF FENCE. WIRING SHALL BE DONE IN A

4. PROVIDE PERIODIC INSPECTION AND MAINTENANCE OF

MANNER THAT WILL PREVENT SAGGING OF FENCE MATERIAL

FENCE INCLUDING REPAIRS AS NECESSARY AND REQUIRED.

5. PLASTIC FENCE SHALL BE INTERNATIONAL ORANGE COLOR, AS

MANUFACTURED BY ADPI ENTERPRISES, INC. OR APPROVED EQUAL.

6. REMOVE CONSTRUCTION FENCE AS DIRECTED BY THE OWNER'S FIELD REPRESENTATIVE.

STABILIZED CONSTRUCTION ENTRANCE

AND/OR CLEANOUT OF ANY MEASURE USED TO TRAP SEDIMENT. ALL SEDIMENT SPILLED,

PUBLIC RIGHTS-OF-WAY. WHEN WASHING IS REQUIRED, IT SHALL BE DONE ON AN AREA

STABILIZED WITH STONE AND WHICH DRAINS INTO AN APPROVED SEDIMENT TRAPPING DEVICE.


DROPPED, WASHED OR TRACKED ONTO PUBLIC RIGHTS-OF-WAY MUST BE REMOVED

8. WASHING - WHEELS SHALL BE CLEANED TO REMOVE SEDIMENT PRIOR TO ENTRANCE ONTO

9. PERIODIC INSPECTION AND NEEDED MAINTENANCE SHALL BE PROVIDED AFTER EACH RAIN.

PLAN VIEW

APPROVED SUBGRADE

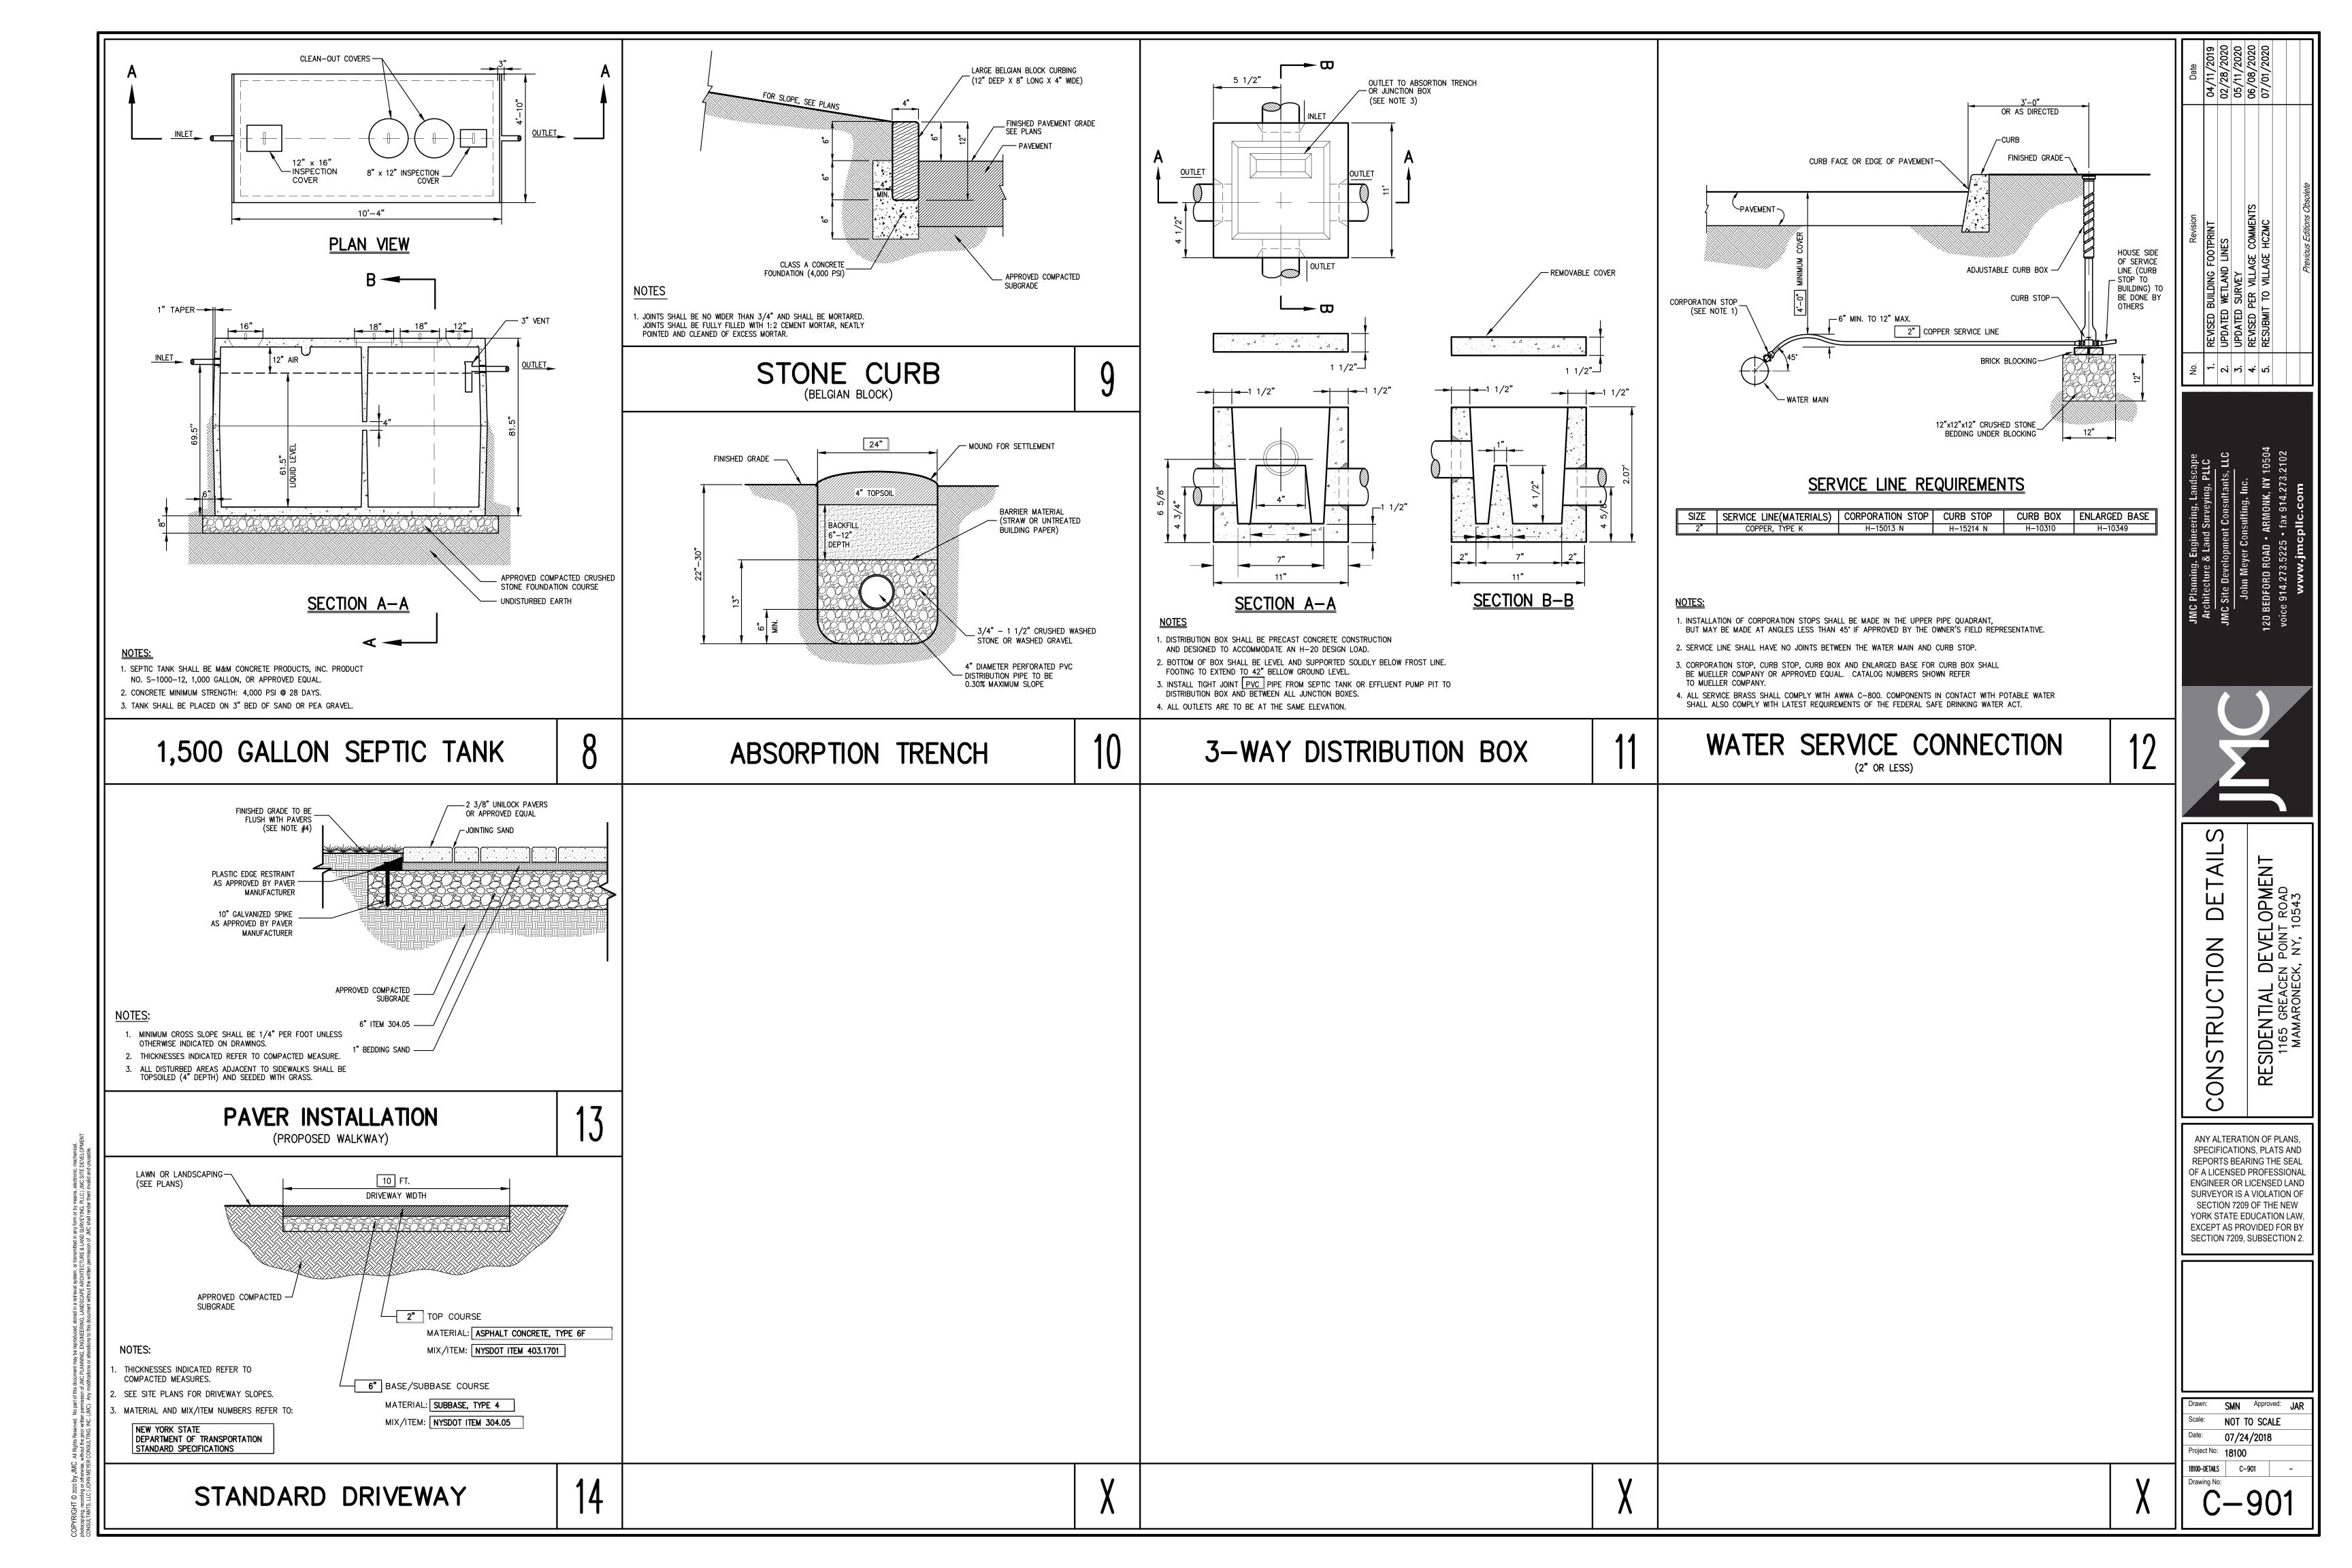



___ APPROXIMATE LOCATION OF EXISTING DOCK TO REMAIN

ELIS,

LEGEND

EXISTING PROPERTY LINE

ADJACENT PROPERTY LINE

EXISTING PAVEMENT EDGE

EXISTING TREE AND DESIGNATION

EXISTING CURB LINE

EXISTING WATER LINE

EXISTING FENCE

RAR Approved: JAR 06/28/2020 ^oroject No: **18100** 18100-LAND L-100 LAY.scr Drawing No:

Previous Editions Obsolete

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