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Revisions

5/29/2020 - Bid Addendum 2. 9/29/2020 - SWPPP submittal

Drawing North

ORIENTA BEACH

CLUB 1054 WALTON AVE

MAMARONECK, NY 10543

LOWER TERRACE **IMPROVEMENTS**

1054 WALTON AVE TOWN OF MAMARONECK WESTCHESTER CO.


NEW YORK


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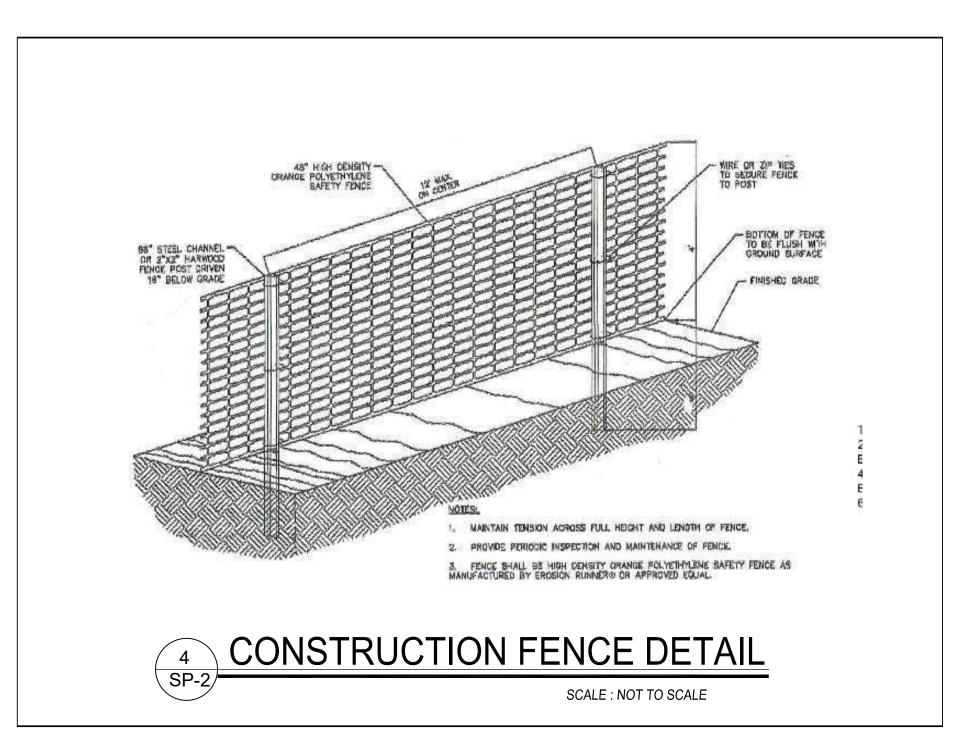
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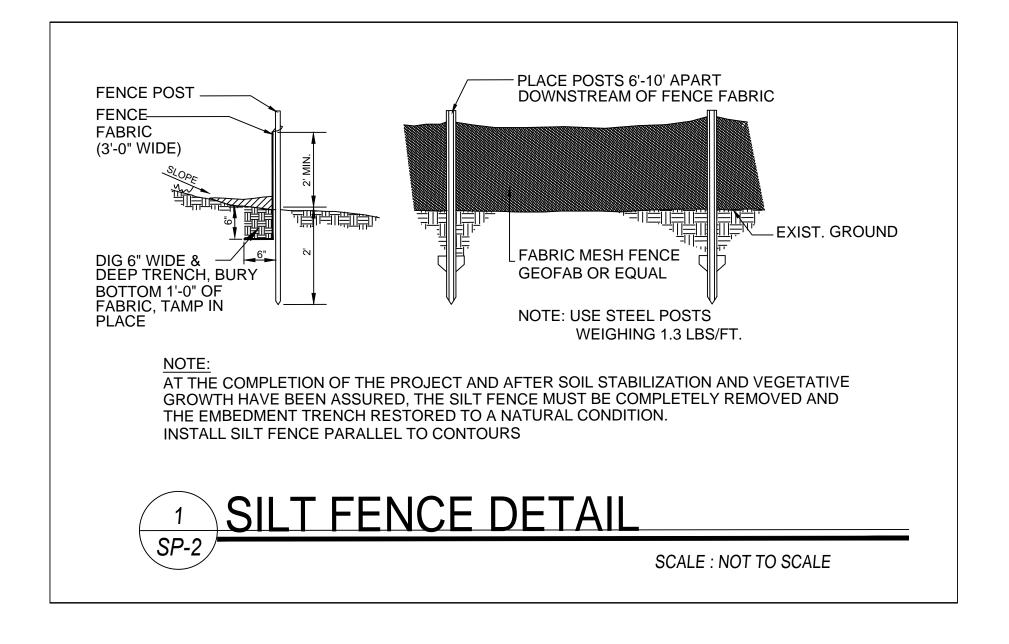
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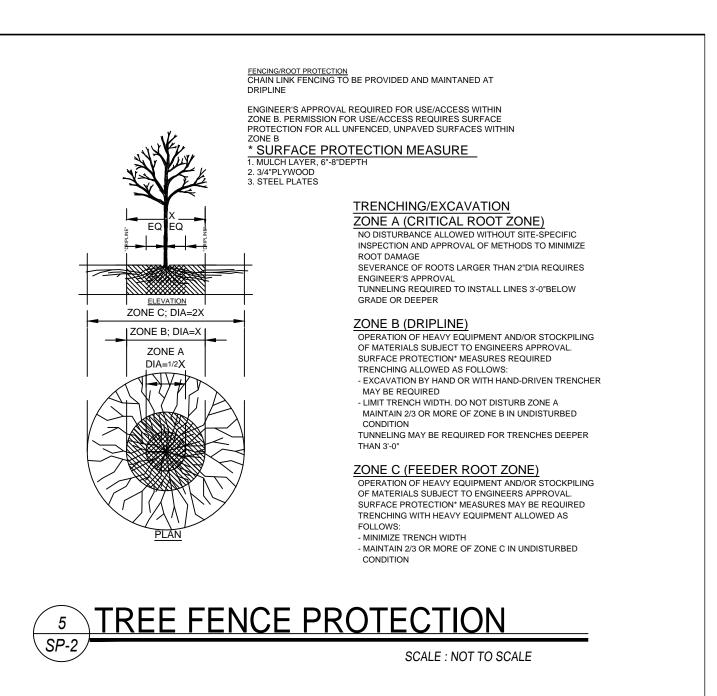
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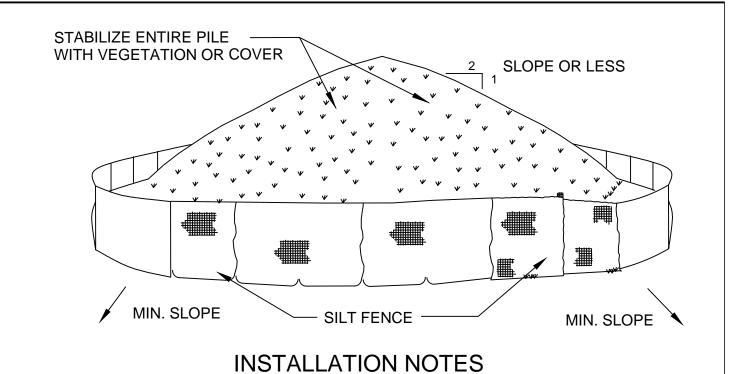








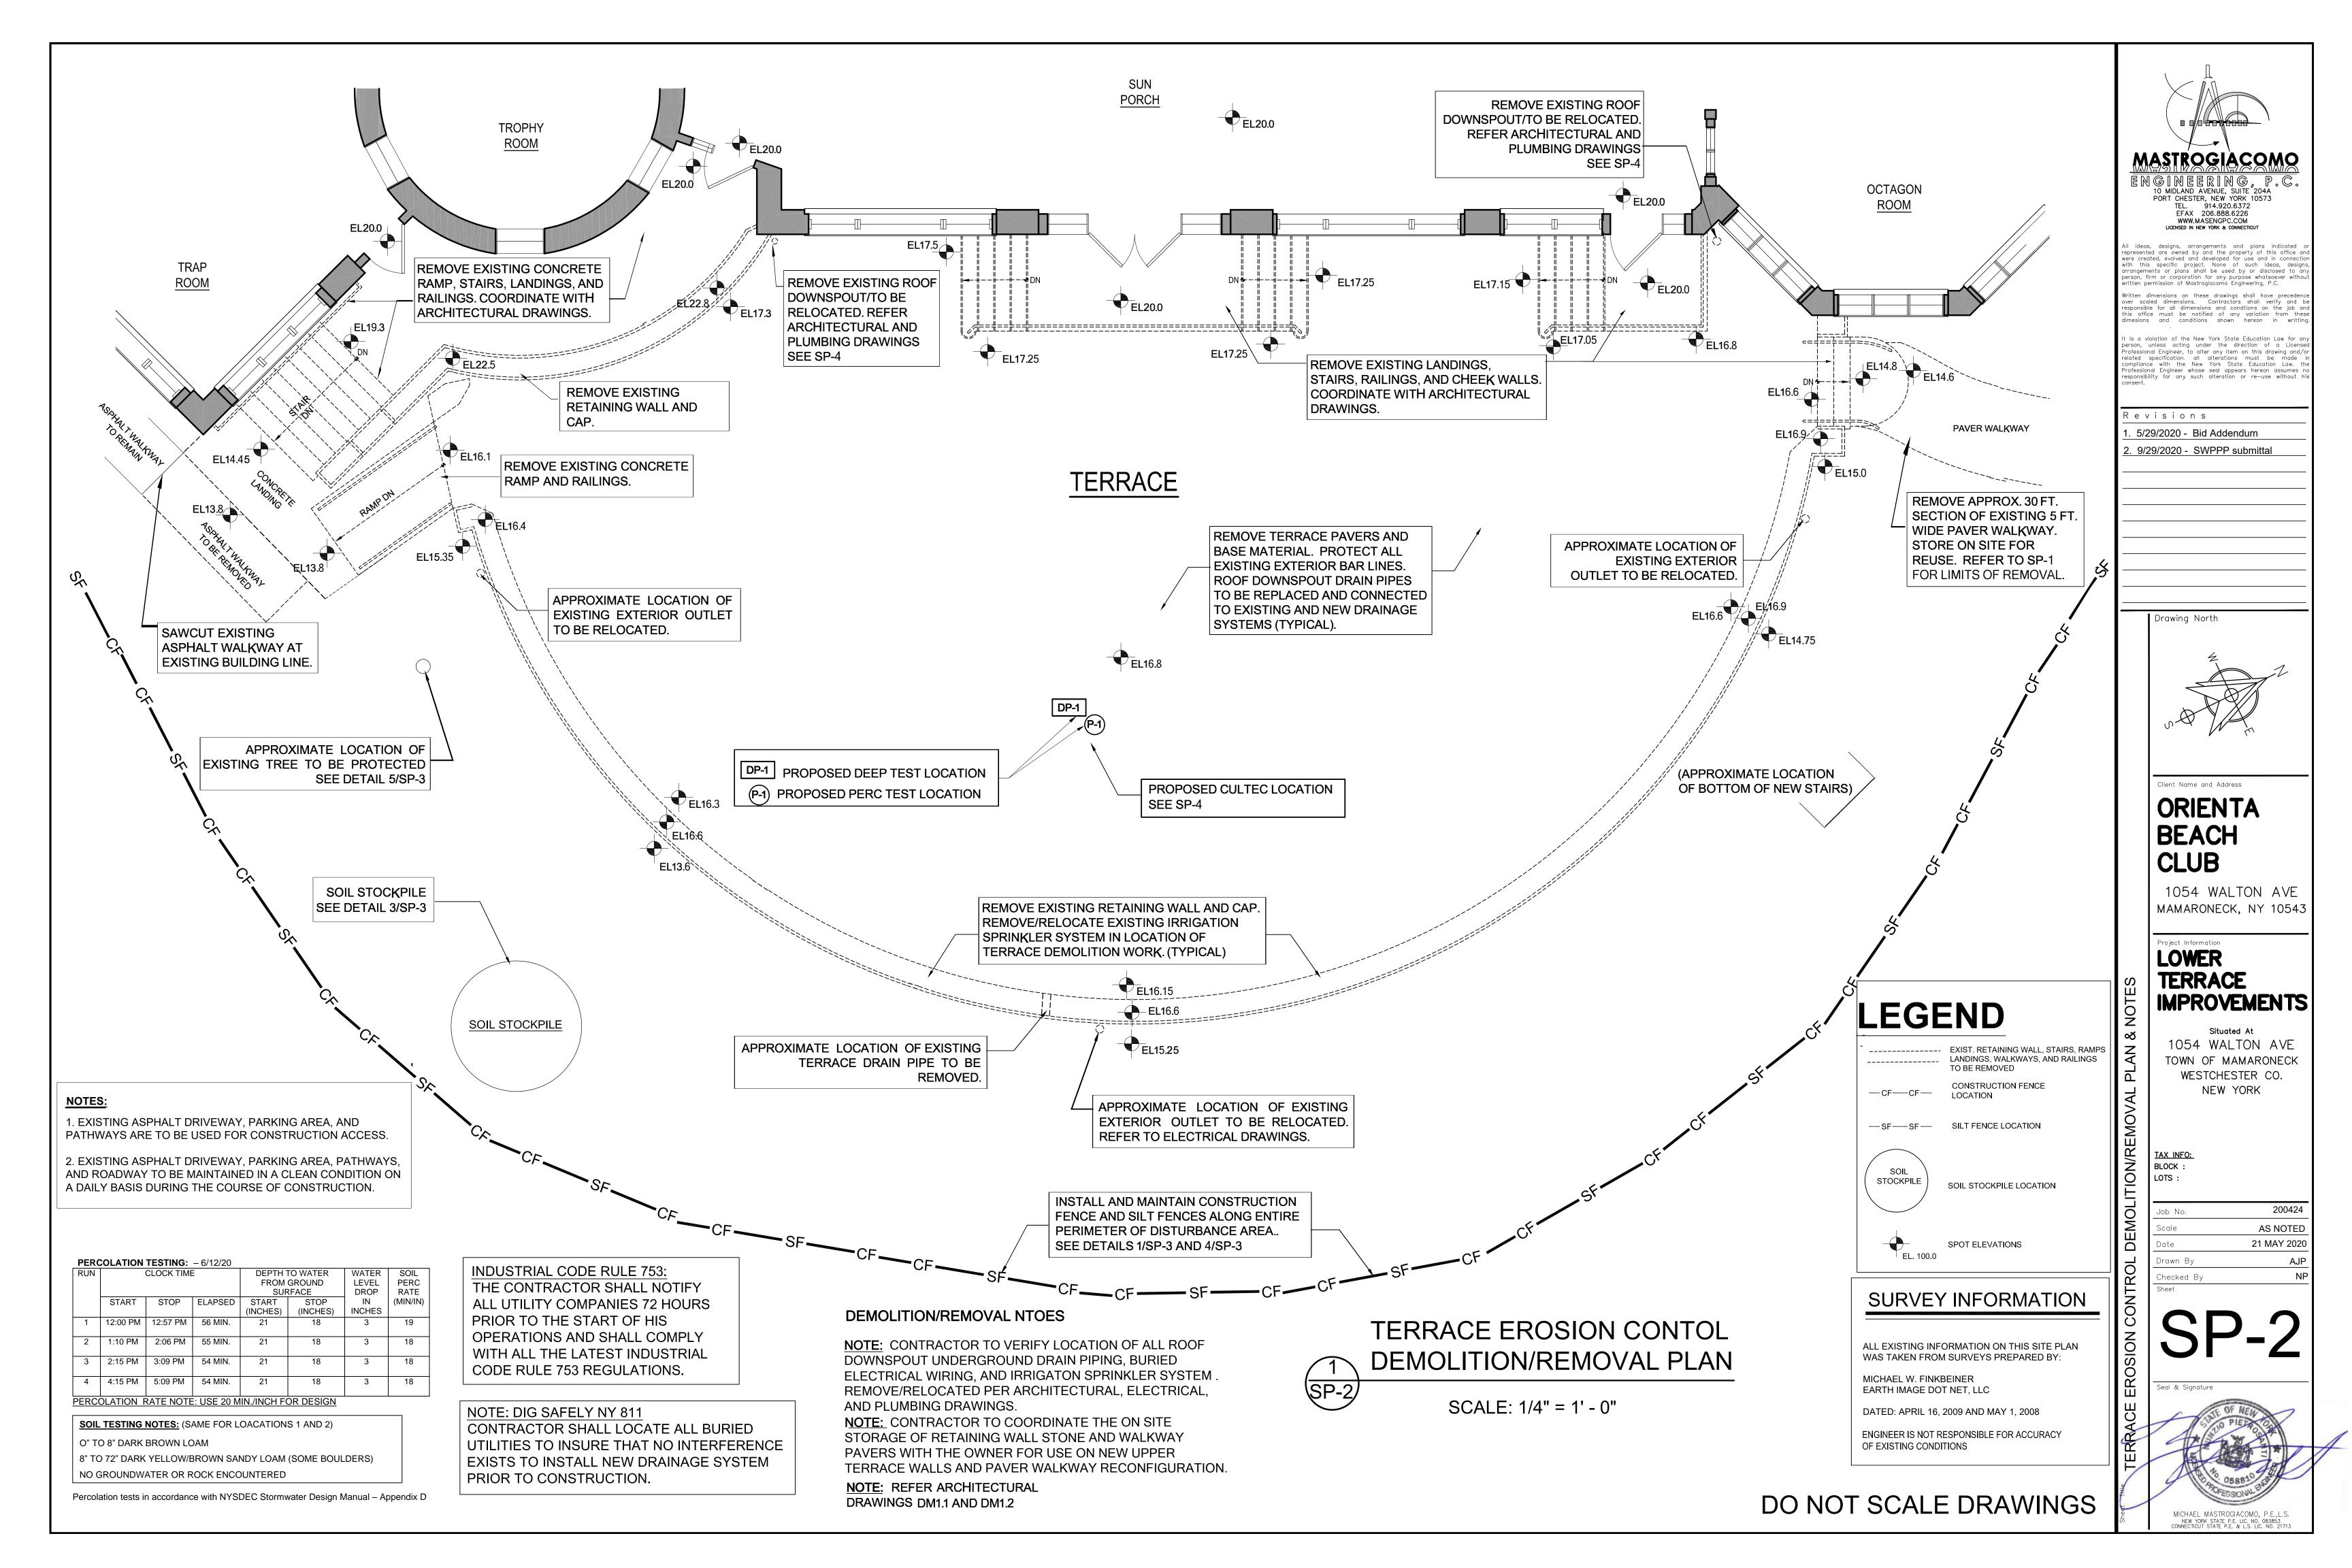


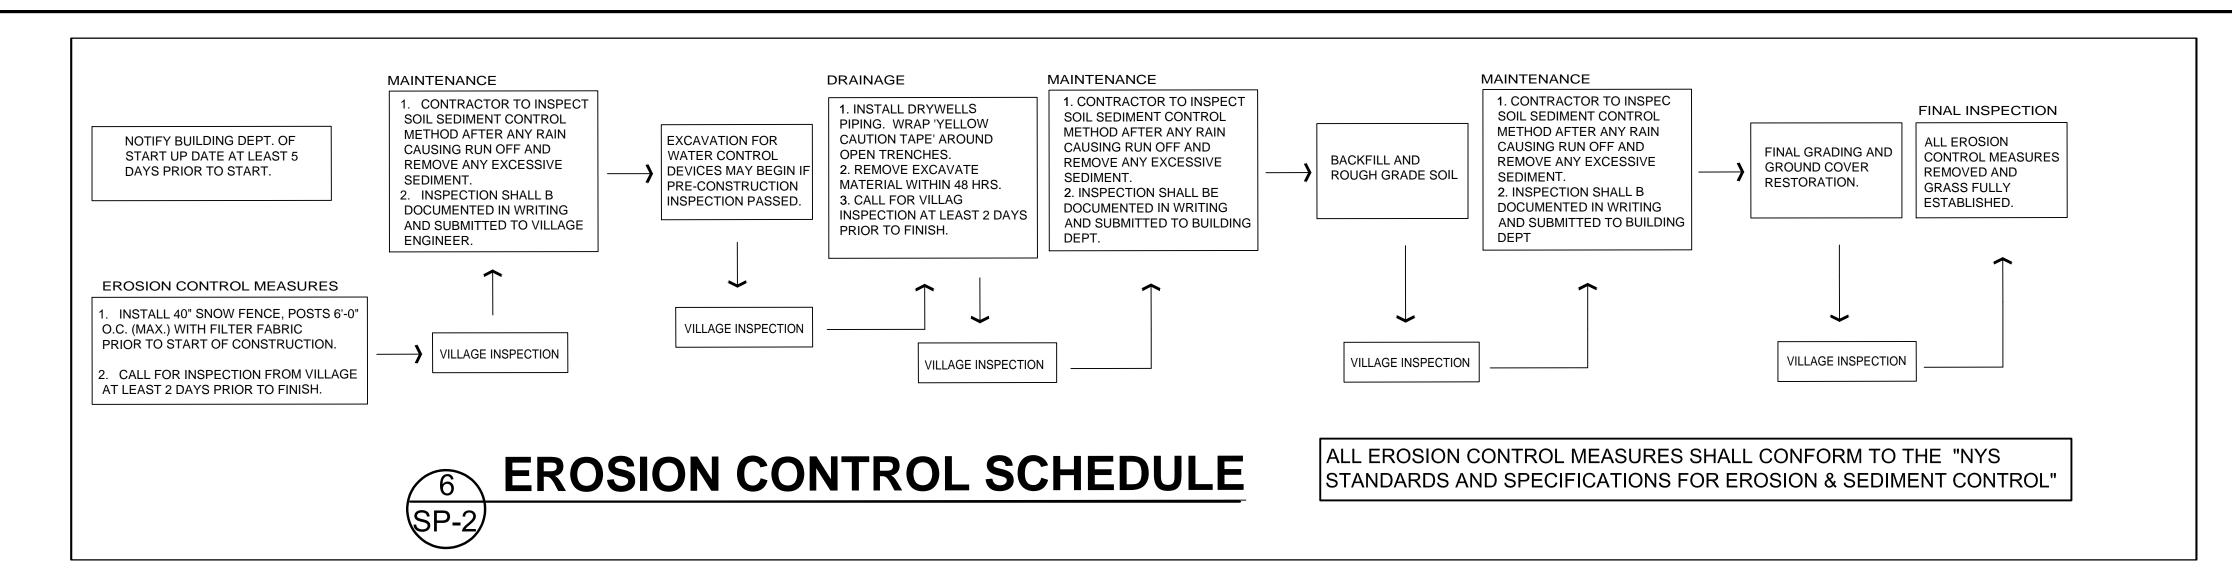

1. AREA CHOSEN FOR STOCKPILING OPERATIONS SHALL BE DRY AND STABLE

- 2. SOILS OR FILL TO BE STOCKPILED ON SITE DURING CUTTING AND FILLING ACTIVITIE SHOULD BE LOCATED ON LEVEL PORTIONS OF THE SITE WITH A MINIMUM OF 50-75 FOOT SETBACKS FROM TEMPORARY DRAINAGE SWALES.
- 3. MAXIMUM SLOPE OF STOCKPILE SHALL BE 1:2
- 4. UPON COMPLETION OF SOIL STOCKPILING, EACH PILE SHALL BE SURROUNDE WITH EITHER SILT FENCING, THEN STABILIZED WITH VEGETATION
- 5. STOCKPILES REMAINING IN PLACE FOR MORE THAN A WEEK SHOULD BE SEEDED AN MULCHED OR COVERED WITH GEOTEXTILE FABRIC SURROUNDED BY SILT FENCE.
- 6. SEE SPECIFICATIONS FOR INSTALLATION OF SILT FENCE



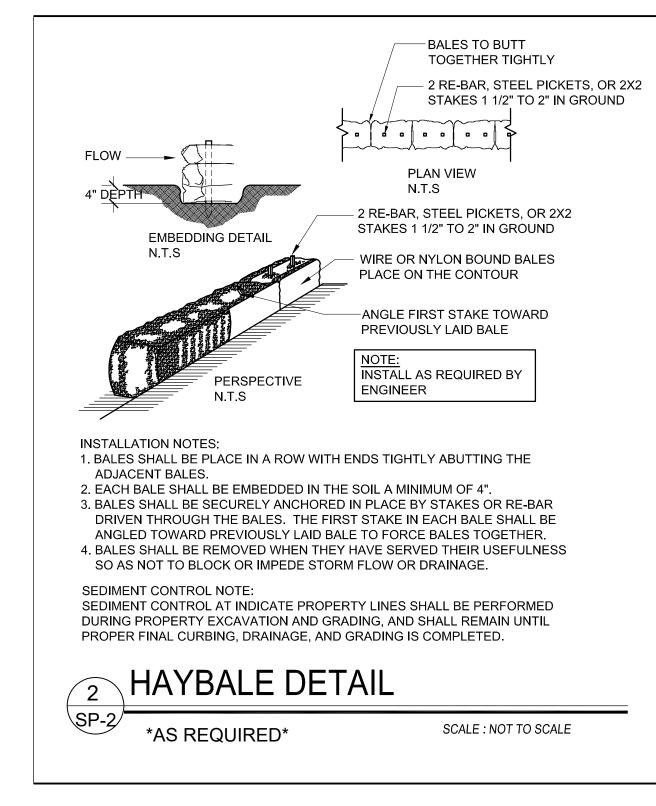

INSTALLATION & MAINTENANCE OF EROSION CONTROL

NOTIFY APPROPRIATE MUNICIPAL AGENCY HAVING JURISDICTION AT LEAST 5 DAYS PRIOR TO

INSTALL ALL EROSION CONTROL MEASURES PRIOR TO START OF CONSTRUCTION. CALL FOR INSPECTION FROM THE APPROPRIATE MUNICIPAL AGENCY HAVING JURISDICTION AT LEAST 2 DAYS PRIOR TO FINISH.

MAINTENANCE (TO BE PERFORMED DURING ALL PHASES OF CONSTRUCTION)

AFTER ANY RAIN CAUSING RUNOFF, CONTRACTOR TO INSPECT SILT FENCE, ETC. AND REMOVE AND EXCESSIVE SEDIMENT, AND INSPECT STOCKPILES AND CORRECT ANY PROBLEMS WITH SEED ESTABLISHMENT. INSPECTIONS SHALL BE DOCUMENTED IN WRITING AND SUBMITTED TO THE APPROPRIATE

MUNICIPAL AGENCY HAVING JURISDICTION.

STRIP TOPSOIL AND STOCKPILE

STOCK PILING OF EXCAVATED MATERIAL

STOCKPILE EXCAVATION SUBGRADE SEED PILES WITH 1LB TOTAL ANNUAL RYE OR REMOVE FROM SITE WITHIN 2 DAYS

REMOVE UNNEEDED SUBGRADE FROM SITE. CALL FOR INSPECTION FROM THE APPROPRIATE MUNICIPAL AGENCY HAVING JURISDICTION AT LEAST 2 DAYS PRIOR TO FINISH.

LANDSCAPING

SPREAD TOPSOIL EVENLY OVER AREAS TO BE SEEDED. HAND RAKE LEVEL BROADCAST 1.25LB BAG OF JONATHAN GREEN "FASTGROW" MIX OR EQUAL OVER AREAS TO BE SEEDED. APPLY STRAW MULCH AND WATER WITHIN 2 DAYS OF COMPLETION OF TOPSOILING. CALL FOR INSPECTION FROM THE APPROPRIATE MUNICIPAL AGENCY HAVING JURISDICTION AT LEAST 2 DAYS PRIOR TO FINISH.

INSPECTION BY MUNICIPALITY

FINAL LANDSCAPING

CALL FOR INSPECTION FROM THE APPROPRIATE MUNICIPAL AGENCY HAVING JURISDICTION AT LEAST 2 DAYS PRIOR TO FINISH.

INSPECTION BY MUNICIPALITY FINIAL INSPECTION

- 1. ALL EROSION CONTROL MEASURES REMOVED AND GRASS ESTABLISHED.
- 2. CALL FOR INSPECTION FROM THE APPROPRIATE MUNICIPAL AGENCY HAVING JURISDICTION AT LEAST 2 DAYS PRIOR TO FINISH.

VILLAGE OF



Building Department 169 Mt. Pleasant Ave Mamaroneck, N.Y. 10543

> Fax Number: (914) 777-7792

Date 10-7-2020

Contractor Certification for Storm Water Pollution Prevention Plans (SWPPP).

(1) Per Village of Mamaroneck Code, section 294, each contractor and subcontractor identified in the SWPPP who will be involved in soil disturbance and/or storm water management practice installation shall sign and date a copy of the following certification statement before undertaking any land development activity:

certify under penalty of law that I understand and agree to comply with the terms and condition of the storm water pollution prevention plan. I also understand that it is unlawful for any person to cause or contribute to a violation of water quality

The certification must include the name and title of the person providing the signature, address and telephone number of the contracting firm; the address (or other identifying description) of the site; and the date the certification is made.

(914) 777-7731

Contractor Information

· Name SEAN MURD

· Company Name Murph Bearts Co · Address 416 Warel Are manusonecking 10543

• Phone 914-777-5777

Manasoneel, na 10543

THE FRIENDLY VILLAGE

NOTES:

1. EXISTING ASPHALT DRIVEWAY, PARKING AREA, AND PATHWAYS ARE TO BE USED FOR CONSTRUCTION ACCESS.

2. EXISTING ASPHALT DRIVEWAY, PARKING AREA, PATHWAYS, AND ROADWAY TO BE MAINTAINED IN A CLEAN CONDITION ON A DAILY BASIS DURING THE COURSE OF CONSTRUCTION.


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5/29/2020 - Bid Addendum 9/29/2020 - SWPPP submittal

Drawing North



ORIENTA

1054 WALTON AVE

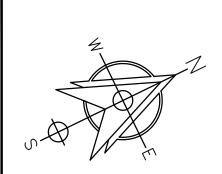MAMARONECK, NY 10543

LOWER **TERRACE IMPROVEMENTS**


1054 WALTON AVE TOWN OF MAMARONECK WESTCHESTER CO.


NEW YORK

TAX INFO: BLOCK:

LOTS: 200424 AS NOTED 21 MAY 2020

Checked By

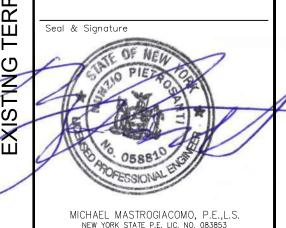

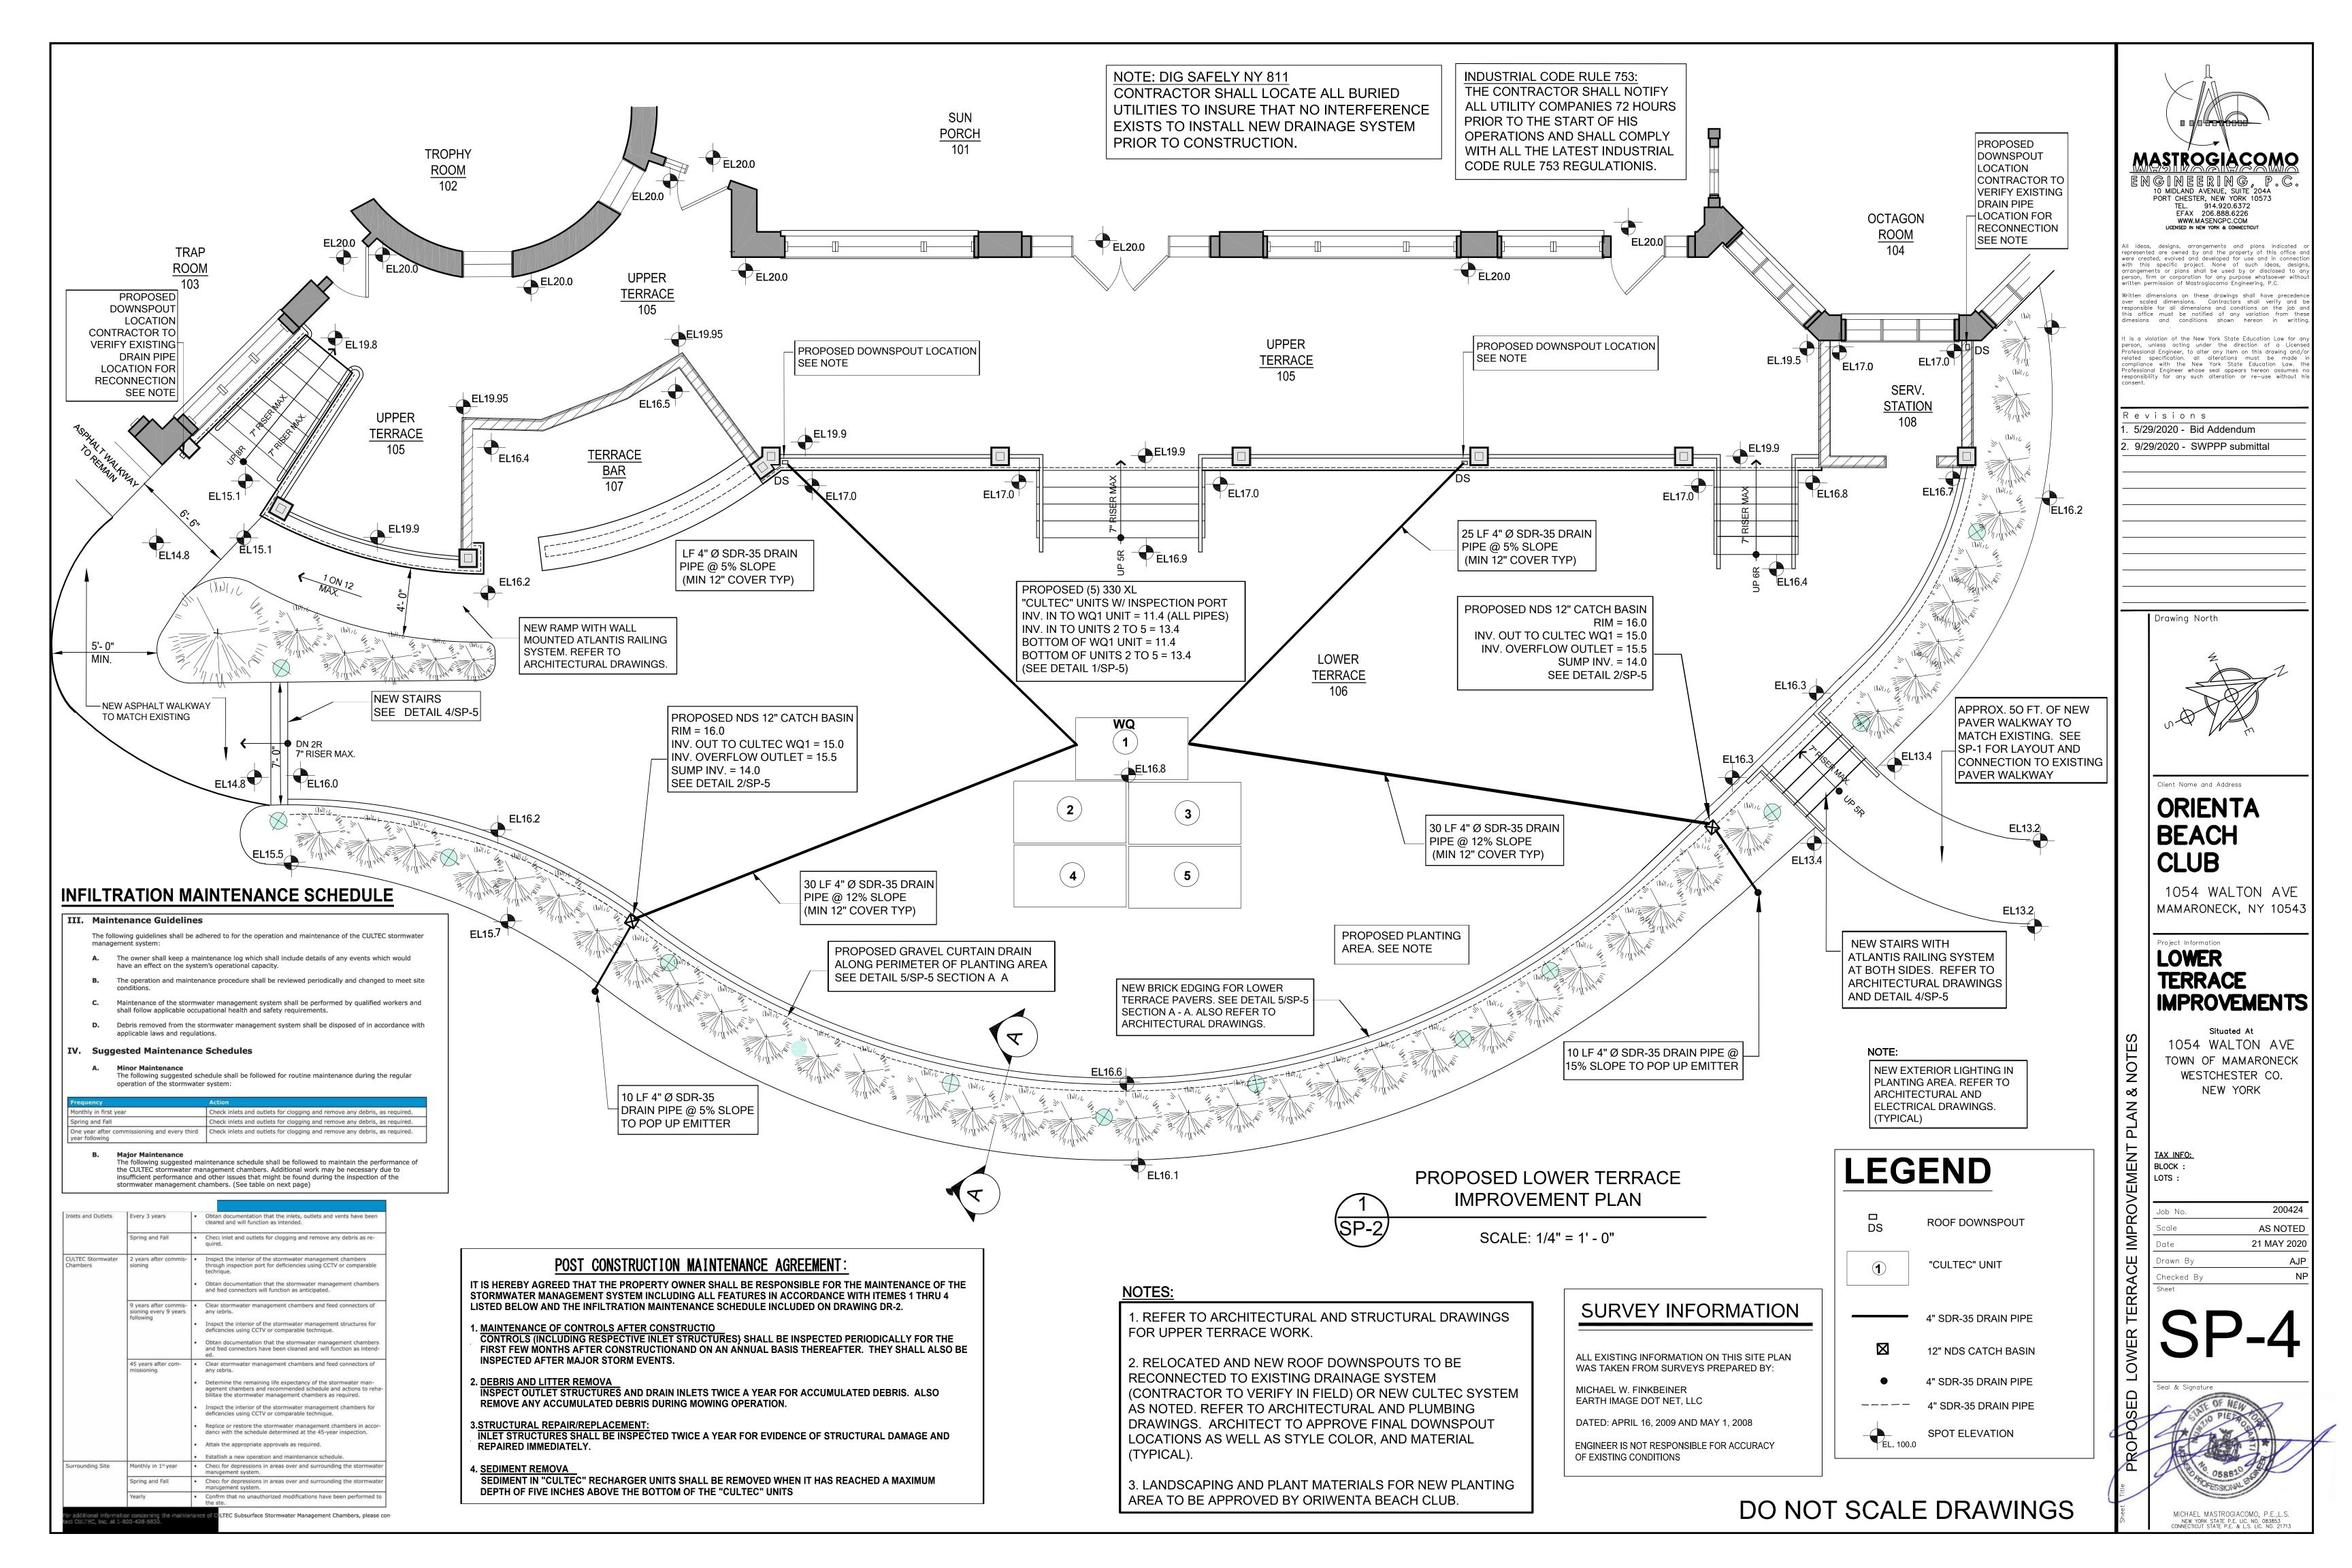

GENERAL CONDITIONS AND SPECIFICATIONS:

GENERAL CONDITIONS:

- 1. THE PROJECT SHALL BE CONSTRUCTED IN ACCORDANCE WITH THE INTERNATIONAL RESIDENTIAL CODE (IRC-2015), THE 2017 NEW YORK STATE CODE SUPPLEMENT, ANY AND ALL OTHER APPLICABLE ORDINANCES, REGULATIONS, AND STANDARDS AS REQUIRED BY THE VILLAGE OF MAMARONECK. ALL CASES THE MOST RESTRICTIVE LIMITATION OF ANY APPLICABLE CODE SHALL BE FOLLOWED BY THE CONTRACTOR.
- CONTRACTOR TO CALL FOR MARK OUT OF ALL UNDERGROUND UTILITIES INSIDE PROPERTY LINE. CONTRACTOR SHALL VERIFY ALL EXISTING CONDITIONS IN THE FIELD PRIOR TO THE START OF WORK. ANY DISCREPANCIES SHALL BE BROUGHT TO THE ENGINEER'S ATTENTION IN A TIMELY MANNER AND PRIOR TO COMMENCEMENT OF WORK.
- CONTRACTOR SHALL NOT "SCALE" DRAWINGS IN ORDER TO OBTAIN DIMENSIONS, ANY QUESTIONS REGARDING DIMENSIONS SHALL BE REFERRED TO THE ENGINEER WHO SHALL PROVIDE THE
- DIMENSIONS AND REPRESENTATIONS RELATING TO THE EXISTING BUILDING AND SITE CONDITIONS ARE APPROXIMATE. CONTRACTOR SHALL VERIFY EXISTING CONDITIONS AND DIMENSIONS PRIOR TO ANY CONSTRUCTION, WITH DISCREPANCIES REPORTED TO THE ENGINEER IMMEDIATELY.
- 5. ANY DISCREPANCIES FOUND BETWEEN THOSE CONDITIONS UNCOVERED IN THE FIELD AND THOSE INDICATED ON THE DRAWINGS SHALL BE BROUGHT TO THE ENGINEER'S ATTENTION IN A TIMELY
- ALL WORK SHALL BE EXECUTED IN ACCORDANCE WITH THE BEST ACCEPTABLE TRADE PRACTICES, PER MANUFACTURER'S RECOMMENDATIONS, AND PER THE REQUIREMENTS OF THE CODE. OWNER RESERVES THE RIGHT TO REJECT UNACCETABLE CONSTRUCTION AT THE COST OF THE CONTRACTOR.
- 7. ALL MANUFACTURED ITEMS SHALL BE INSTALLED OR APPLIED AS DIRECTED BY THE MANUFACTURER'S RECOMMENDATIONS.
- 8. CONTRACTOR TO INCLUDE ALL MATERIALS, LABOR, INCIDENTALS, AND SERVICES FOR SATSFACTORY COMPLETION OF THE WORK. ALL MATERIALS INDICATED FOR THIS PROJECT ARE TO BE FURNISHED AND INSTALLED BY THE CONTRACTOR AND APPROVED BY THE OWNER, UNLESS SPECIFICALLY NOTED OTHERWISE.
- 9. CONTRACTOR SHALL PERFORM ALL WORK REQUIRED FOR THE TOTAL COMPLETION OF THE PROJECT WHETHER OR NOT INDICATED ON THE DRAWINGS. THE INTENTION OF THE DRAWINGS IS
- FOR THE COMPLETE AND PROPER FUNCTIONS OF THE ENTIRE PROJECT. 10. CONTRACTOR AND SUBCONTRACTORS SHALL MAINTAIN WORKMEN'S COMPENSATION INSURANCE AS WELL AS ADEQUATE LIABILITY INSURANCE DURING THE ENTIRE LENGTH OF THE PROJECT.
- 12. THE CONTRACTOR SHALL BE SOLEY RESPONSIBLE FOR PROJECT SAFETY. ABIDE BY ALL OSHA STANDARDS AND REQUIREMENTS.

11. COORDINATE STORAGE OF MATERIAL, EQUIPMENT, AND CONTAINERS WITH OWNER.

- AND EQUIPMENT. CONTRACTOR SHALL RESTORE ANY DAMAGED AREAS TO THEIR ORIGINAL CONDITION AT NO EXPENSE TO OWNER.
 - UPON ENTERING A CONTRACT WITH THE OWNER IT IS THE RESPONSIBILITY OF THE CONTRACTOR TO CARRY OUT THE WORK AS SPECIFIED AND IN ACCORDANCE WITH ALL CODES, RULES, REGULATIONS, AND MANUFACTURER'S RECOMMENDATIONS. CONTRACTOR SHALL FOLLOW THE BUILDING DEPARTMENT APPROVED SET OF DOCUMENTS. NO SUBSTITUTION SHALL BE MADE WITHOUT CONSULTING THE ENGINEER FIRST.

ON THE PROPERTY AND ADJACENT PROPERTIES FROM ANY DAMAGES DUE TO THE METHODS AND

MANNERS OF CONSTRUCTION, TRAFFICKING, AND THE DELIVERY AND STORAGE OF MATERIALS

- NO CHANGES SHALL BE MADE TO THE DRAWINGS EXCEPT AS PER NEW YORK STATE LAW CHAPTER 15. 987. ALL CHANGES MADE TO THESE DRAWINGS SHALL BE APPROVED BY ENGINEER AND SHALL BE FILED AS AMENDMENTS TO THE ORIGINAL PERMIT.
- CONTRACTOR TO NOTIFY THE OWNER WHEN THE WORK WILL BEGIN ON THE PROJECT AND SHALL COORDINATE ALL WORK WITH THE OWNER.
- CONTRACTOR SHALL BE SOLELY AND TOTALLY RESPONSIBLE FOR ALL SEQUENCE OF CONSTRUCTION 17. AND PROTECTION AGAINST WEATHER, PROJECT SAFETY, AND COORDINATION OF TRADES,
- CONTRACTOR IS SOLELY RESPONSIBLE FOR DETERMINING AND IMPLEMENTING METHODS FOR ACCOMPLISHING TEMPORARY SHORING, SUPPORTS, BARRICADES, ETC. FOR ALL ITEMS OF WORK (AS REQUIRED).
- 19. IF THE "CULTEC" DRAINAGE SYSTEM IS TO BE CONSTRUCTED IN A FILL AREA, THE FILL SHALL BE WELL DRAINED MATERIAL WITH A SETTING PERIOD OF ONE TO THREE MONTHS PRIOR TO THE "CULTEC" SYSTEM INSTALLATION, ADDITIONAL PERCOLATION TESTING SHALL BE REQUIRED AFTER THE SETTING PERIOD AND THE SYSTEM DESIGN SHALL BE REDESIGNED AS REQUIRED.
- 20. IF IMPORTED FILL IS REQUIRED, IT SHALL BE CERTIFIED IN WRITING BY A NEW YORK STATE LICENSED PROFESSIONAL ENGINEER AS NON-CONTAMINATED, CLEAN FILL SUITABLE FOR THE INTENDED USE (A PROPER MANIFEST IS TO BE SUBMITTED). PERCOLATION TESTS SHALL BE PERFORMED BY THE DESIGN ENGINEER. THE RESULTS OF THE PERCOLATION TEST(S) SHALL BE
- 21. THE CONTRACTOR SHALL MAINTAIN THE JOB SITE AND ROADWAY IN A CLEAN CONDITION AT ALL TIMES. TRASH AND CONSTRUCTION DEBRIS SHALL BE REMOVED FROM THE SITE ON A REGULAR BASIS AND PROPERLY AND LEGALLY DISPOSED OF AT AN APPROVED LOCATION.

SUBMITTED TO THE BUILDING DEPARTMENT FOR REVIEW AND APPROVAL

22. ALL PROPOSED TEMPORARY SEEDING MIXTURES SHALL BE IN ACCORDANCE WITH THE NEW YORK STATE STANDARDS AND SPECIFICATIONS FOR URBAN EROSION CONTROL, LATEST EDITION.

NEW TERRACE PAVERS

SEE DETAIL 3/SP-5

TYPICAL ____

BASE (MIN. 4") ON

UNDISTURBED SOIL OR COMPACTED SUB-GRADE

SP-5 SCALE: NTS

- 1/2" EXPANSION

—— 1 1/2" GRANITE

TREADS (MIN. 12") ON

BED OF 1/2" MORTAR

LOWER TERRACE STAIRS DETAIL

1 1/2" BLUE STONE

(SIZE & COLOR BY

OWNER) TYPICAL

RISERS (MAX. 7") ON BED OF 1/2"MORTAR ON FACE OF STEP

(SIZE & COLOR BY

OWNER) TYPICAL

JOINT

- 23. THE CONTRACTOR SHALL COORDINATE AND COOPERATE WITH ALL OTHER CONTRACTORS AND SHALL CUT, LAY, AND INSTALL THEIR WORK AT SUCH A TIME AND MANNER SO THAT NO DELAY OR INTERFERENCE WITH THE CARRYING FORWARD OF THE WORK OF OTHER CONTRACTORS SHALL
- 24. THE ENGINEER AND OWNER RESERVE THE RIGHT TO MAKE CHANGES TO THE DRAWINGS AND SPECIFICATIONS OR TO INCREASE OR DECREASE THE QUANTITY OF WORK AT ANY TIME, BEFORE OR AFTER CONSTRUCTION HAS COMMENCED. WITH APPROPRIATE ADJUSTMENT TO CONTRACT SUM
- 25. ANY ITEMS ADDED TO THE PROJECT SUBSEQUENT TO THE CONSTRUCTION CONTRACT SHALL FOLLOW THE SPECIFICATIONS FOR MATERIAL PREVIOUSLY SPECIFIED UNLESS OTHERWISE NOTED.
- 26. THE CONTRACTOR SHALL BE SOLEY RESPONSIBLE FOR NOTIFICATION TO THE VILLAGE OF BUILDING AND ENGINEERING DEPARTMENTS IN CONJUNCTION WITH ANY AND ALL REQUIRED INSPECTIONS TO BE PERFORMED. THE CONTRACTOR SHALL BE SOLELY RESPONSIBLE FOR KNOWLEDGE OF WHICH INSPECTIONS THE BUILDING AND ENGINEERING DEPARTMENTS PERFORM. THE CONTRACTOR'S WORK SHALL BE CONSIDERED COMPLETE ONLY WHEN ALL REQUIRED CLOSE-**OUT DOCUMENTS ARE IN ORDER**
- 27. NO RESPONSIBILITY HAS BEEN ASSUMED BY THE ENGINEER FOR INFORMATION SUPPLIED BY OTHERS AND BELIEVED BY THE ENGINEER TO BE RELIABLE. NOR FOR ANY CONDITIONS WHICH WERE CONCEALED OR IMPOSSIBLE TO DETECT WITHOUT SUBSTANTIAL EXCAVATION, PROBING OR TESTING NOR FOR ANY LATENT DEFECTS IN THE EXISTING STRUCTURE. ENGINEER ASSUMES NO LIABILITY FOR ANY WORK NOT IN CONFORMANCE WITH THE CODE OR FOR EXISTING CONDITIONS
- 28. ANY SITE OBSERVATIONS PERFORMED BY THE ENGINEER ARE SOLELY FOR THE ENGINEER'S PURPOSE OF DETERMINING IF THE WORK IS BEING CARRIED OUT IN ACCORDANCE WITH THE CONTRACT DOCUMENTS FOR THE GENERAL DESIGN AND AESTHETIC INTENT. THE ENGINEER'S PRESENCE ON THE SITE IN NO WAY RELIEVES THE CONTRACTOR OF HIS DUTIES TO PERFORM THE WORK IN ACCORDANCE WITH THE CONTRACT DOCUMENTS, THE INTERNATIONAL RESIDENTIAL CODE (IRC-2015), AND THE RULES AND REGULATIONS MANDATED BY THE VILLAGE OF
- 29. THE ENGINEER WILL NOT BE HELD LIABLE FOR ANY UNSTISFACTORY WORK PERFORMED, QUALITY OF WORKMANSHIP, MEANS AND METHODS OF CONSTRUCTION, SITE SAFETY, EXCEPTIONS BY THE LOCAL MUNICIPALITY FOR FAILED INSPECTIONS, OR ANY OTHER DEFICIENCIES BY THE CONTRACTOR.

NOTE INSTALL ALANTIS

SIDES OF NEW STAIRS.

DRAWINGS.

4,000 PSI CONCRETE

#4 REBAR 12" O.C.

BOTH WAYS

RAILING SYSTEM AT BOTH

REFER TO ARCHITECTURAL

RELOCATED ASPHALT OR PAVER WALKWAY

30. THE ENGINEER HAS NOT BEEN RETAINED TO PERFORM FIELD SUPERVISION OF THIS PROJECT.

ı MIN. CULTEC NO. 20L POLYETHYLENE LINER TO BE PLACED BENEATH **HVLV FC-24 FEED CONNECTORS CULTEC NO. 66 WOVEN GEOTEXTILE (FOR** WHEN UTILIZING INTERNAL SCOUR PROTECTION) TO BE PLACED MANIFOI D BENEATH ALWATER QUALITY_ INFILTRATION CHAMBERS AND BENEATH ALL INLET/OUTLET PIPES PER MFRS. ALL RECHARGER 330 XL HEAVY DUTY UNITS ARE MARKED WITH A **RECOMMENDATIONS** COLOR STRIPE FORMED INTO THE PART ALONG THE LENGTH OF THE ALL RECHARGER 330 XL CHAMBERS MUST BE INSTALLED IN ACCORDANCE WITH ALL APPLICABLE LOCAL, STATE AND FEDERAL ECHARGER 330 XL BY CULTEC, INC. OF BROOKFIELD, CT. STORAGE PROVIDED = 11.32 CF/FT PER DESIGN UNIT. REFER TO CULTEC, INC.'S CURRENT RECOMMENDED INSTALLATION **Storage Volume Provided per Installed Chamber:** USE RECHARGER 330 XL HEAVY DUTY FOR TRAFFIC AND/OR H20 APPLICATIONS. With 6" stone base = 79.26 cu. ft. / unit TYPICAL PLAN AND SECTION THRU "CULTEC INC." RECHARGER 330 XLHD" SCALE: NOT TO SCALE

F 24 FEED

-- PAVEMENT

RECHARGER 330 XL HD


HEAVY-DUTY CHAMBER


CONNECTOR

- 95% COMPACTED FILL

CULTEC ACCESS PORT

AROUND STONE

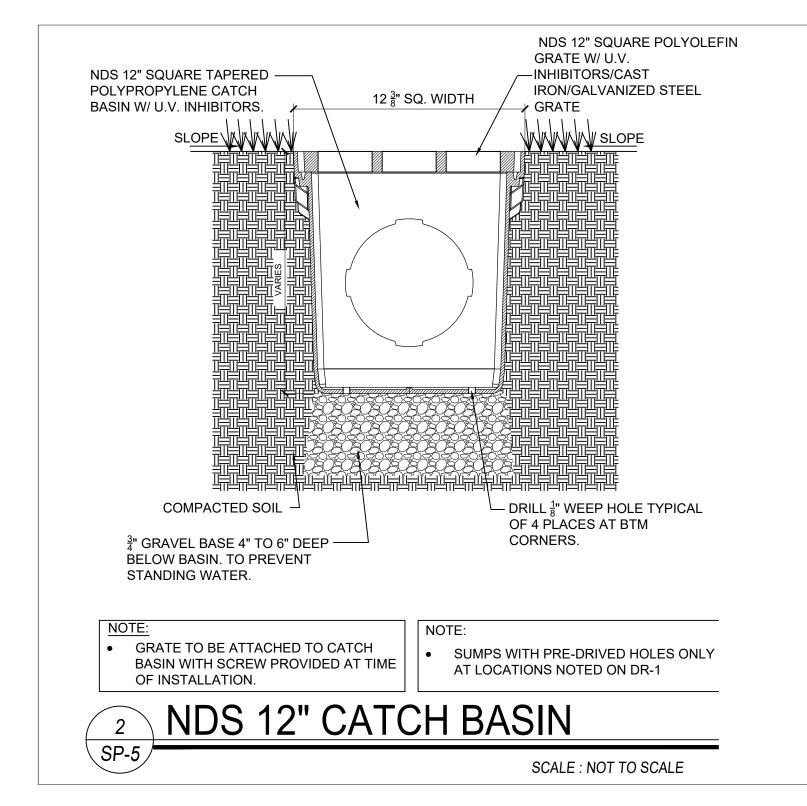

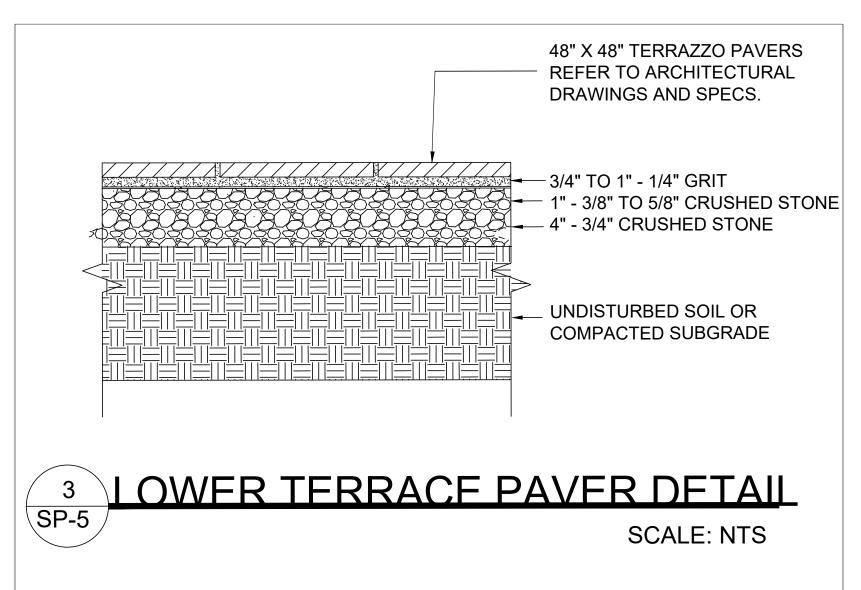

SPECIFICATIONS:

- FOUNDATION DESIGN IS BASED ON 2 TON/SF BEARING CAPACITY.
- 2. EXCAVATE BELOW EXISTING FOOTINGS TO UNDISTURBED SOIL.
- 3. EXCAVATE TO FROST LINE (3'-6" MIN.) FOR ALL FOOTINGS (UNDERPIN ADJACENT WALL FOOTINGS
- 4. STOCKPILE ALL EXCAVATED SOIL FOR FUTURE REUSE AS FILL MATERIAL OR REMOVE AND DISPOSE
- 5. ALL FILL MATERIAL TO BE CLEAN FILL WITH COMPACTION TO 95% WITH MAXIMUM LIFTS OF 12".

- 1. ALL CONCRETE FOR FOOTINGS TO BE MIN. 3000 PSI CONCRETE.
- 2. PROVIDE CONCRETE FOOTINGS OF SIZES SHOWN ON DRAWINGS.
- CONCRETE FOR FLOOR SLAB SHALL BE MIN. 4000 PSI AIR ENTRAINED CONCRETE. PROVIDE CONCRETE FOOTINGS OF SIZE INDICATED ON THE DRAWINGS.
- 5. ALL WORK SHALL BE IN ACCORDANCE WITH THE ACI CODE 318 (LATEST EDITION).
- 6. ALL REINFORCEMENT SHALL BE PLACED FREE FROM RUST OR OTHER COATINGS THAT MAY DESTROY
- 7. WIRE FABRIC SHALL BE IN ACCORDANCE WITH THE ASTM A185 (LATEST EDITION).

- 1. RE-USE EXISTING STONE FOR RELOCATED RETAINING WALL RECONSTRUCTION. CLEAN AND PROPERLY STORE STONE FOR REUSE. IF ADDITIONAL STONE IS REQUIRED, IT MUST MATCH THE
- 2. MORTAR SHALL COMPLY WITH ASTM C270-1986, TYPE N.
- LIME SHALL BE TYPE S OR N AS PER ASTM C207-1979.
- SAND SHALL CONFORM TO ASTM C144-1984. 5. WATER SHALL BE CLEAN AND POTABLE.
- 6. ALL STONE TO BE LAID UP IN PORTLAND CEMENT MORTAR OF A 1:3 MIX WITH 15% LIME
- 7. BLUESTONE FOR STAIRS TO BE MINIMUM 1-1/2" IN THICKNESS. SIZE, COLOR, AND TEXTURE TO BE

SPECIAL NOTES:


- EXISTING DRIVEWAY TO BE USED FOR CONSTRUCTION ACCESS.
- 2. CONTRACTOR TO MAINTAIN CONTINUOUS ACCESS TO OCCUPANTS DURING CONSTRUCTION
- DRAINAGE PIPING. AND ANY DRYWELL /CULTECS UNITS THAT INTERFERE WITH THE PROPOSED WORK. ENGINEER TO BE NOTIFIED AND MUST APPROVE ANY REPAIR OR RELOCATIONS.


ADDITIONAL SPECIAL NOTES:

- DEEP PIT AND PERCOLATION TESTING SHALL BE PERFORMED IN ACCORDANCE WITH NYSDEC STORMWATER DESIGN MANUAL - APPENDIX D.
- . PROPOSED SILT FENCE TO BE INSTALLED PARALLEL TO CONTOUR LINES.
- ORANGE CONSTRUCTION FENCE TO BE INSTALLED ALONG THE LIMITS OF THE PROPOSED
- THE APPLICANT SHALL PROVIDE AN AS-BUILT PLAN OF THE STORMWATER MANAGEMENT SYSTEM (FOR ALL STORMWATER INFRASTRUCTURE FEATURES, INCLUDING, BUT NOT LIMITED TO, LOCATIONS OF GRADING, ETC.) CERTIFIED BY THE ENGINEER ON RECORD, PRIOR TO THE ISSUANCE OF A CERTIFICATE OF OCCUPANCY. THE AS-BUILT PLAN SHALL ALSO INCLUDE THE FINAL MAINTENANCE SCHEDULE FOR THE STORMWATER MANAGEMENT FEATURES.

NOTE: EXISTING ROOF LEADERS TO BE RECONNECTED TO EXISTING DRAINAGE SYSTEM. NEW ROOF LEADERS AND NET INCREASE IN IMPERVIOUS TERRACE SURFACE TO BE CONNECTED TO NE "CULTEC" UNITS UNDER RECONSTRUCTED LOWER TERRACE.

NOTE: SEE ARCHITECTURAL AND STRUCTURAL DRAWINGS FOR UPPER TERRACE WORK

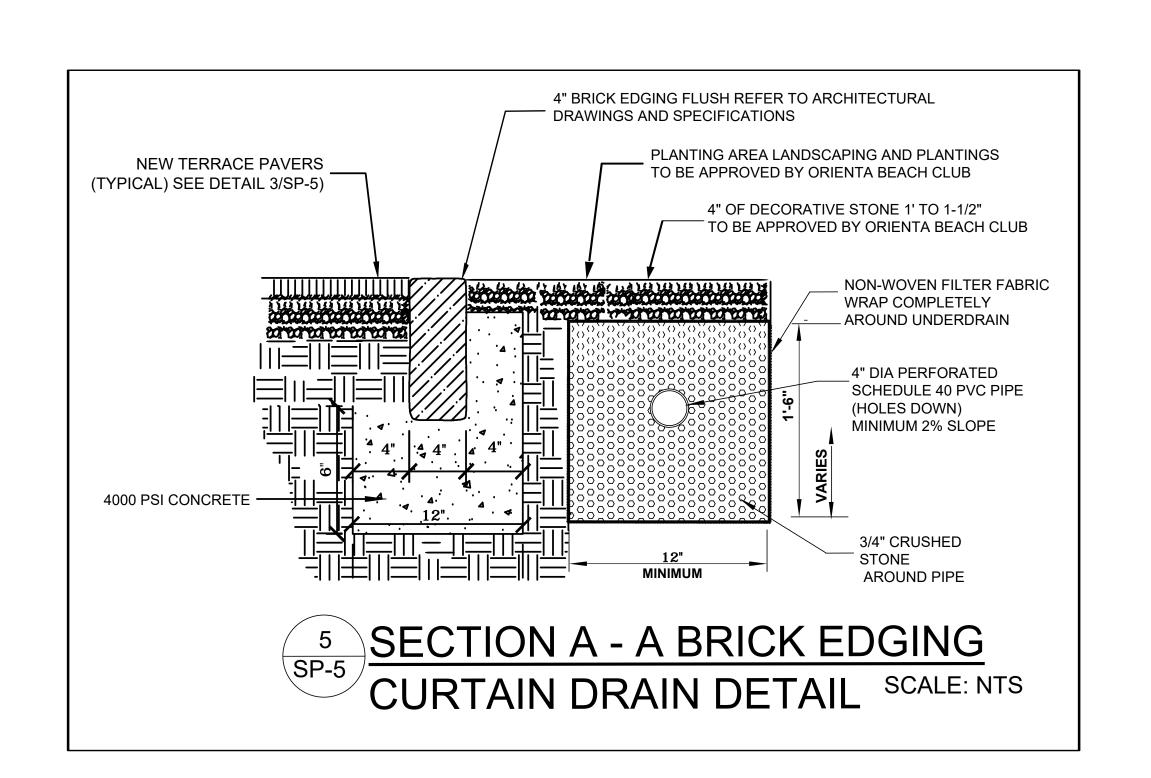

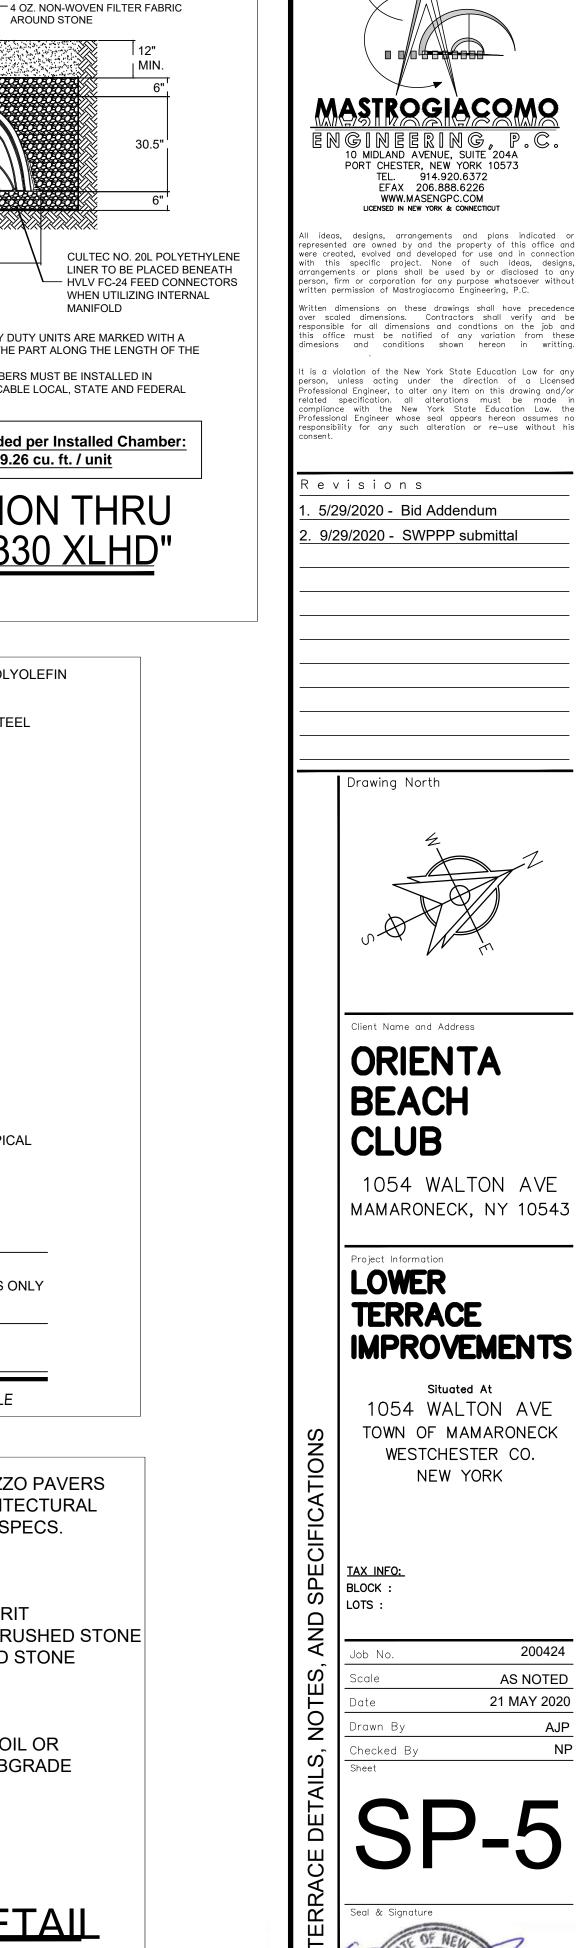

914.920.6372 EFAX 206.888.6226

1054 WALTON AVE

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TOWN OF MAMARONECK

WESTCHESTER CO. NEW YORK

NEW YORK STATE P.E. LIC. NO. 083853 CONNECTICUT STATE P.E. & L.S. LIC. NO. 2171.

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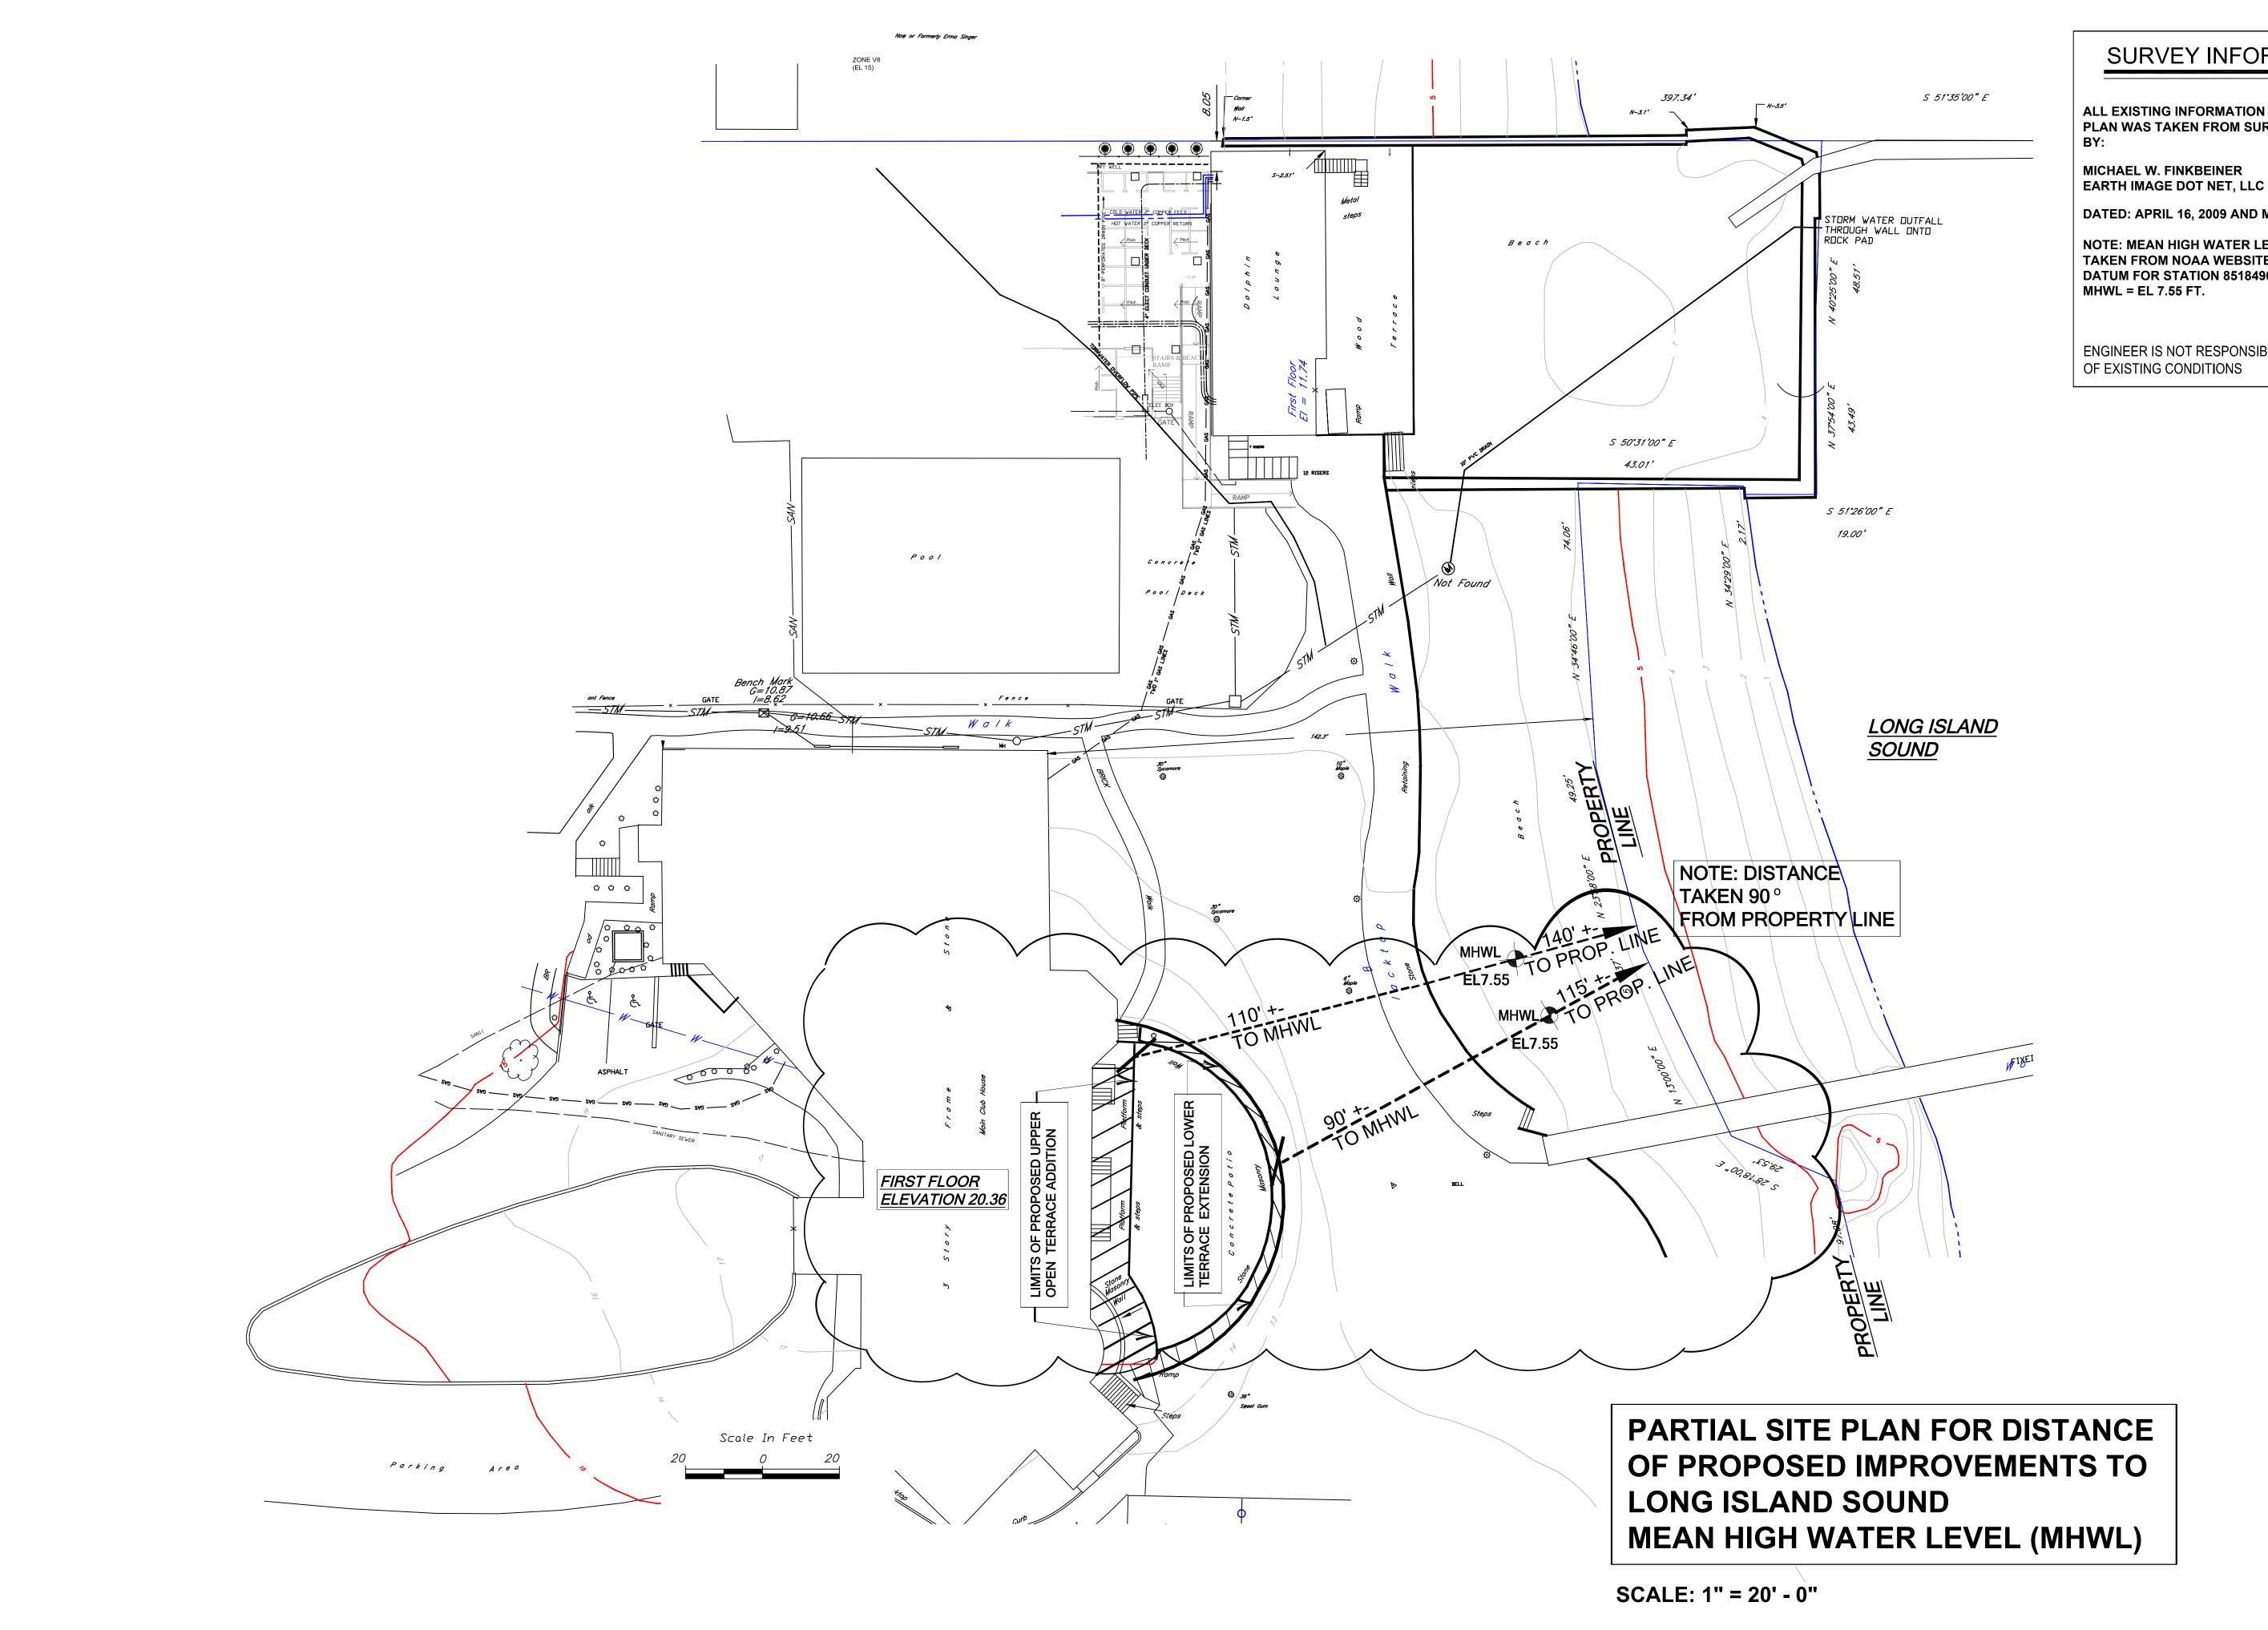
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SURVEY INFORMATION

ALL EXISTING INFORMATION ON THIS SITE PLAN WAS TAKEN FROM SURVEYS PREPARED

DATED: APRIL 16, 2009 AND MAY 1, 2008

NOTE: MEAN HIGH WATER LEVEL (MHWL) TAKEN FROM NOAA WEBSITE **DATUM FOR STATION 8518490 NEW ROCHELLE**

ENGINEER IS NOT RESPONSIBLE FOR ACCURACY

MASTROGIACOMO ENGINEERING, P.C.

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PORT CHESTER, NEW YORK 10573 TEL. 914.920.6372 EFAX 206.888.6226 WWW.MASENGPC.COM LICENSED IN NEW YORK & CONNECTICUT

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Revisions - ADD REAR YARD SETBACKS FOR UPPER OPEN TERRACE & LOWER TERRACE EXTENSION

2. 9/29/2020 - SWPPP SUBMITTAL

Drawing North

ORIENTA BEACH CLUB


1054 WALTON AVE MAMARONECK, NY 10543

LOWER TERRACE **IMPROVEMENTS**

Situated At 1054 WALTON AVE TOWN OF MAMARONECK WESTCHESTER CO. NEW YORK

AS NOTED 21 SEPTEMBER2020



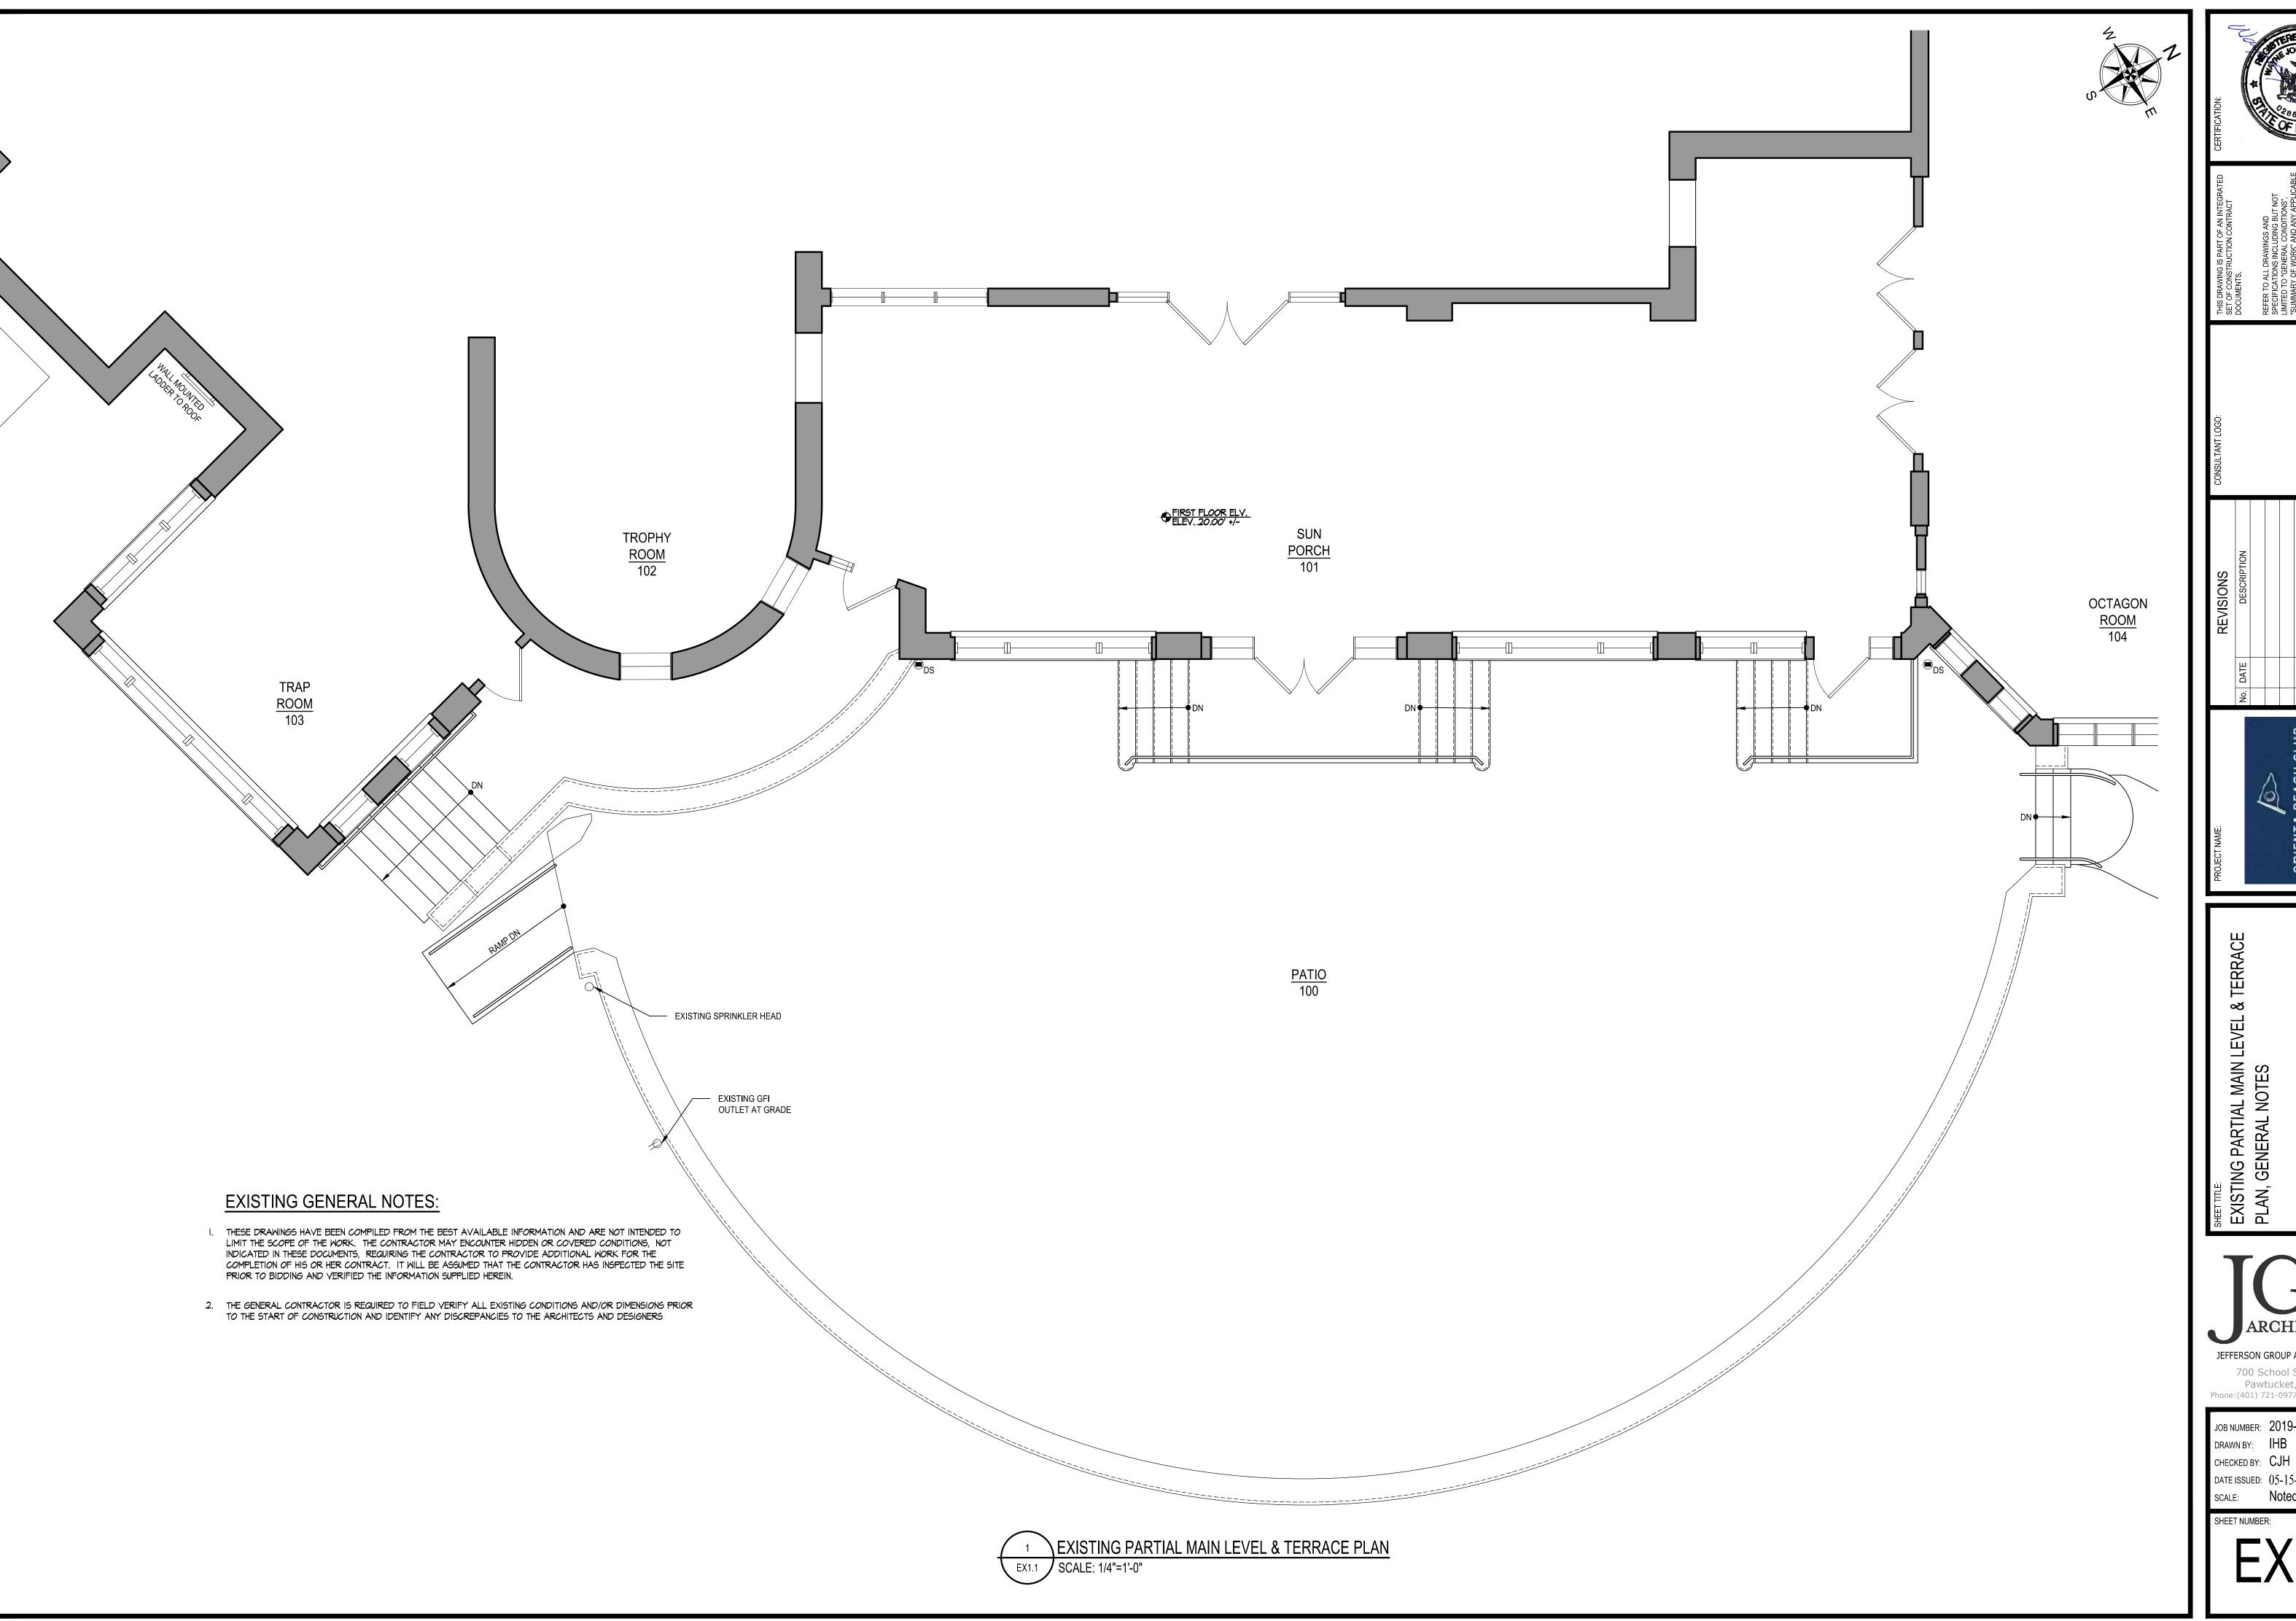



EXISTING PARTIAL MAIN LEVEL PLAN, GENERAL NOTES

JEFFERSON GROUP ARCHITECTURE, INC. 700 School Street Unit 2

700 School Street Unit 2
Pawtucket, RI 02860
Phone:(401) 721-0977 Fax:(401) 721-2238 JOB NUMBER: 2019-26

снескед ву: **С**ЈН DATE ISSUED: 05-15-2020 SCALE: Noted

SHEET NUMBER:




JEFFERSON GROUP ARCHITECTURE, INC.

700 School Street Unit 2
Pawtucket, RI 02860
Phone:(401) 721-0977 Fax:(401) 721-2238

JOB NUMBER: 2019-26 DRAWN BY: IHB CHECKED BY: PRB/JSM DATE ISSUED: 05-15-2020

SHEET NUMBER:

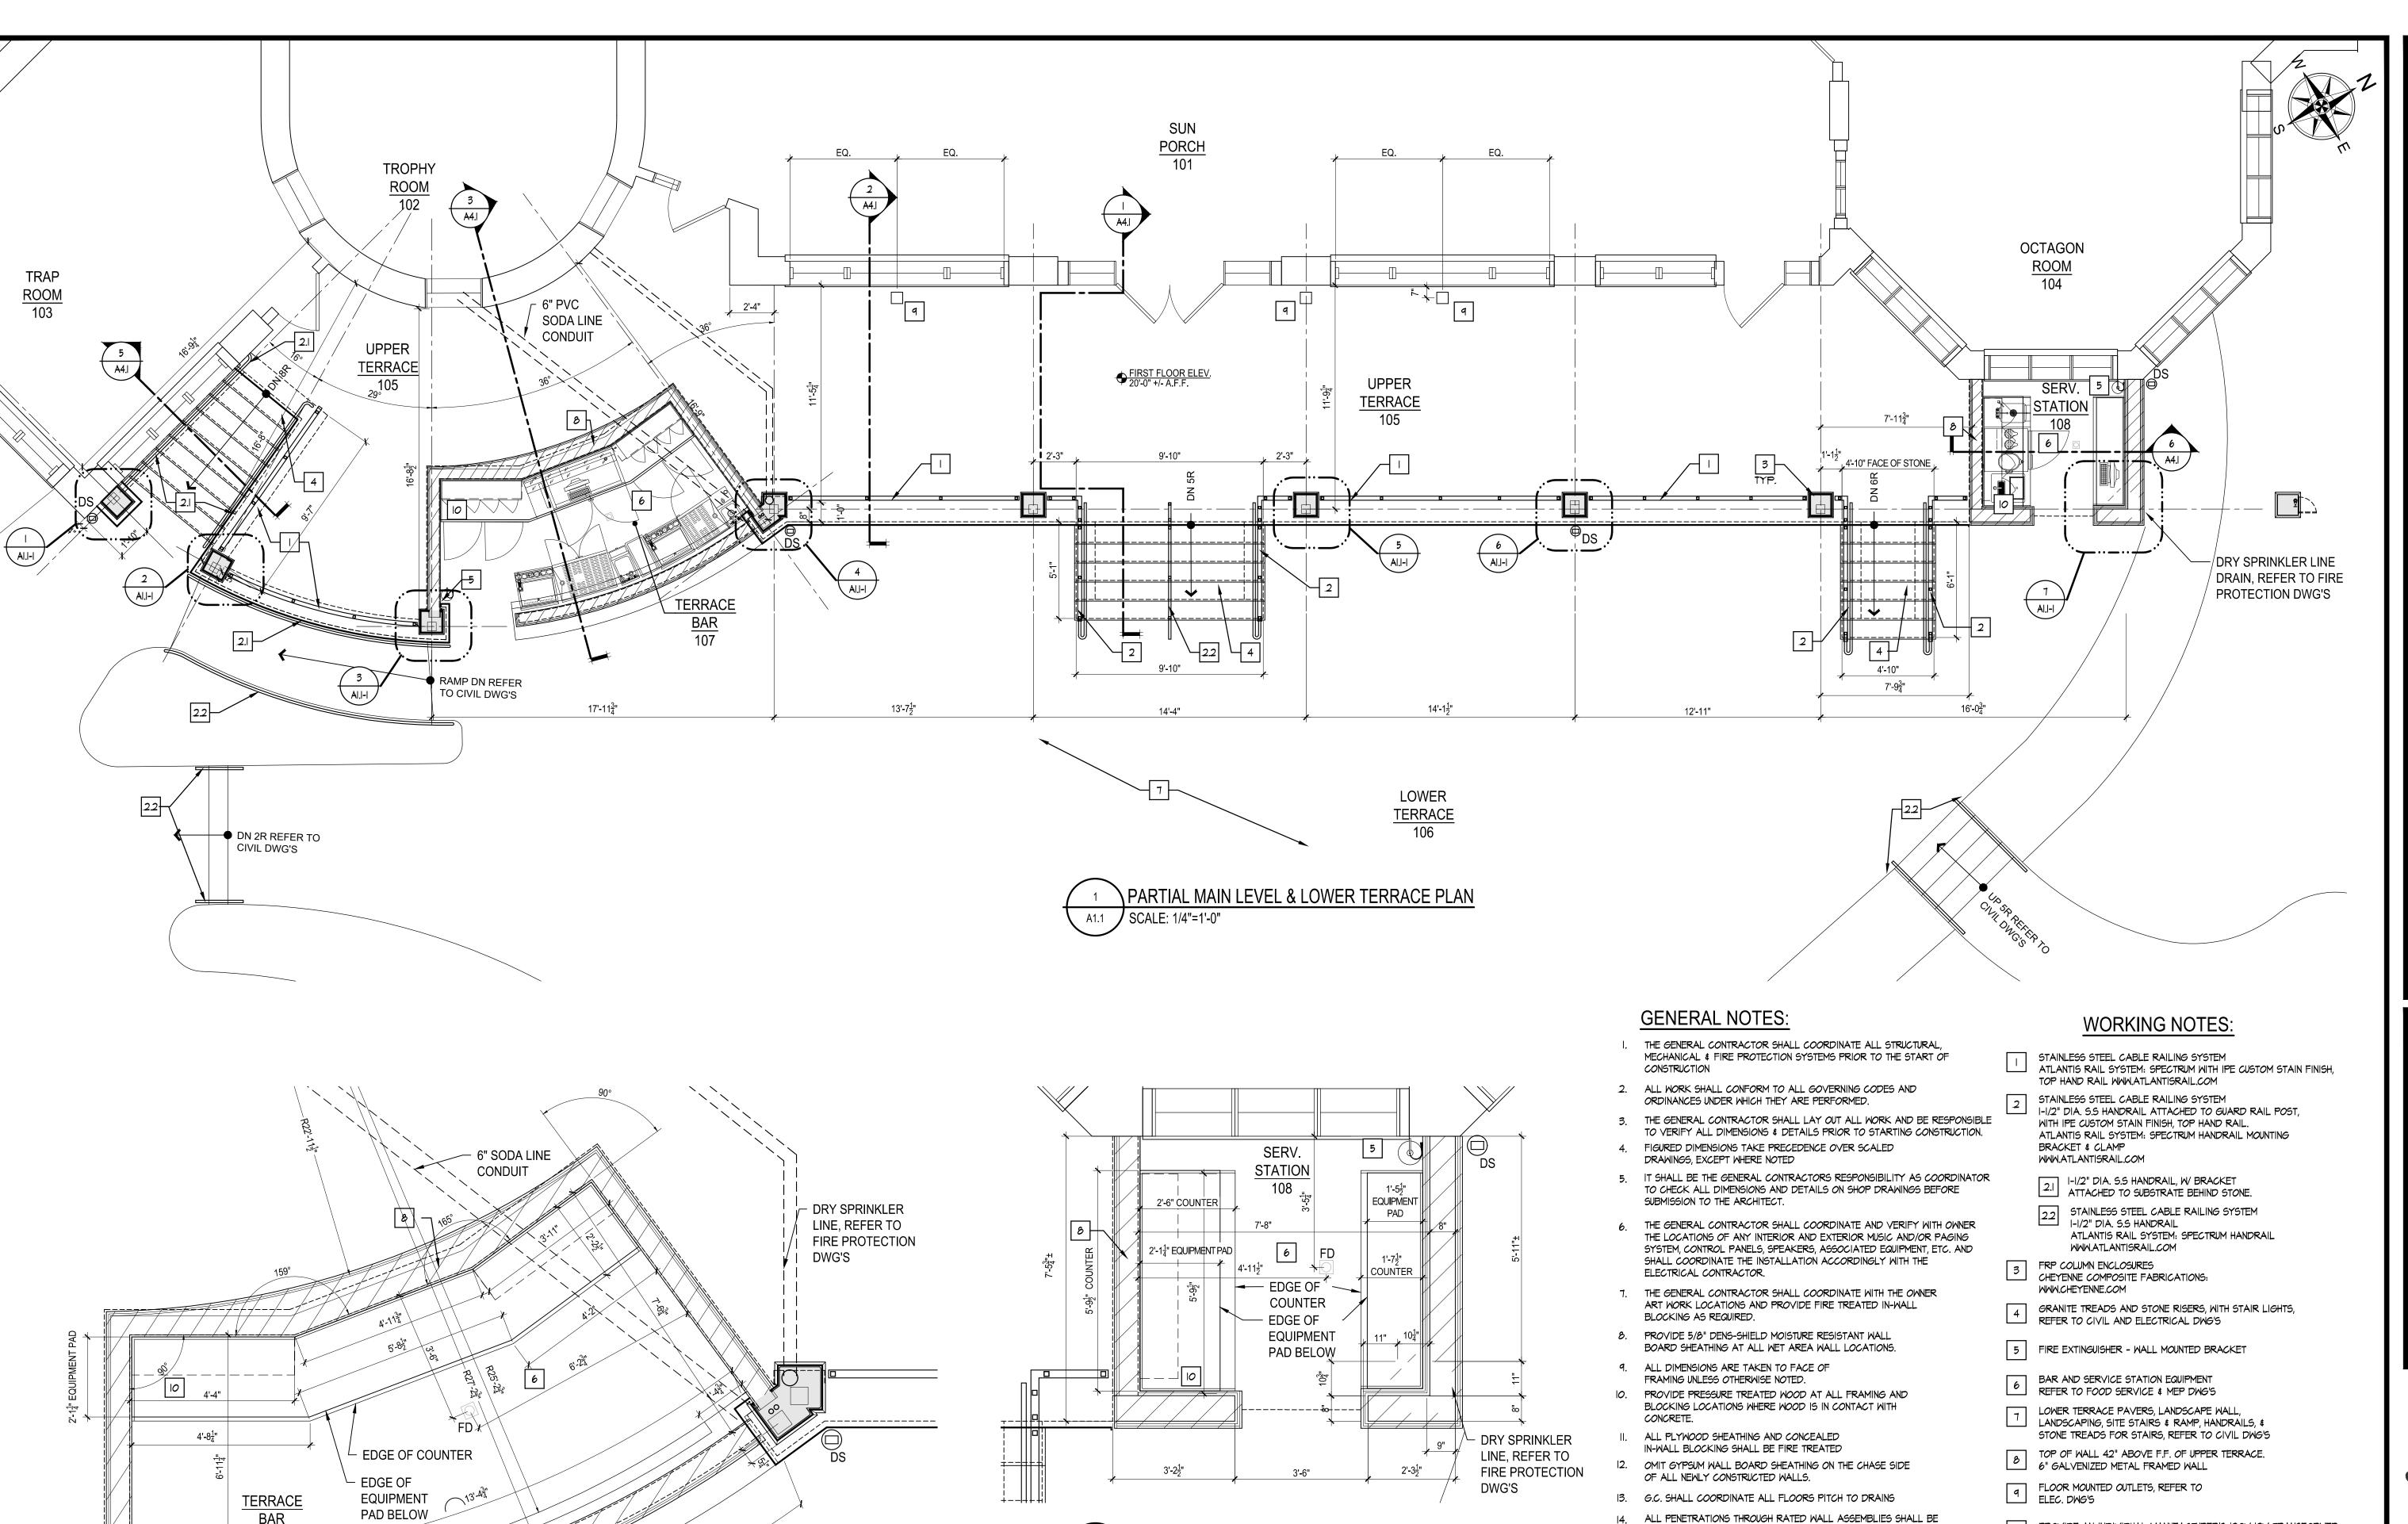

SERVICE STATION ENLARGE PARTIAL FLOOR PLAN

3'-53"

A1.1 SCALE: 1/2"=1'-0"

TERRACE BAR ENLARGE PARTIAL FLOOR PLAN

PROVIDE AN INDIVIDUAL MANUFACTURER'S 120V:12V TRANSFORMER FOR EACH STAIR TO POWER STEP LIGHTS. LOCATE TRANSFORMERS IN BAR AND SERVICE STATION UNDER COUNTER CABINETS. IN NEMA-4X ENCLOSURE WITH A HINGED COVER. TRANSFORMERS SHALL BE MODEL #0075W SS 75W PRO-SERIES TRANSFORMER STAINLESS STEEL. UTILIZE #10AWG COPPER CONDUCTORS FOR LOW VOLTAGE WIRING TO A MAXIMUM OF 48'-0" BETWEEN TRANSFORMERS AND STEP LIGHTS TO ACCOMMODATE FOR VOLTAGE DROP. REFER TO ELECTRICAL DWG'S.

TREATED WITH AN APPROVED "FIRESTOP" MATERIAL TO MEET THE

SPECIFIED WALL CONSTRUCTION.



JEFFERSON GROUP ARCHITECTURE, INC.


700 School Street Unit 2
Pawtucket, RI 02860
Phone:(401) 721-0977 Fax:(401) 721-2238


JOB NUMBER: 2019-26
DRAWN BY: IHB/JSM

DRAWN BY: IHB/JSM
CHECKED BY: PRB
DATE ISSUED: 05-15-2020
SCALE: Noted

SHEET NUMBER:

A1.1

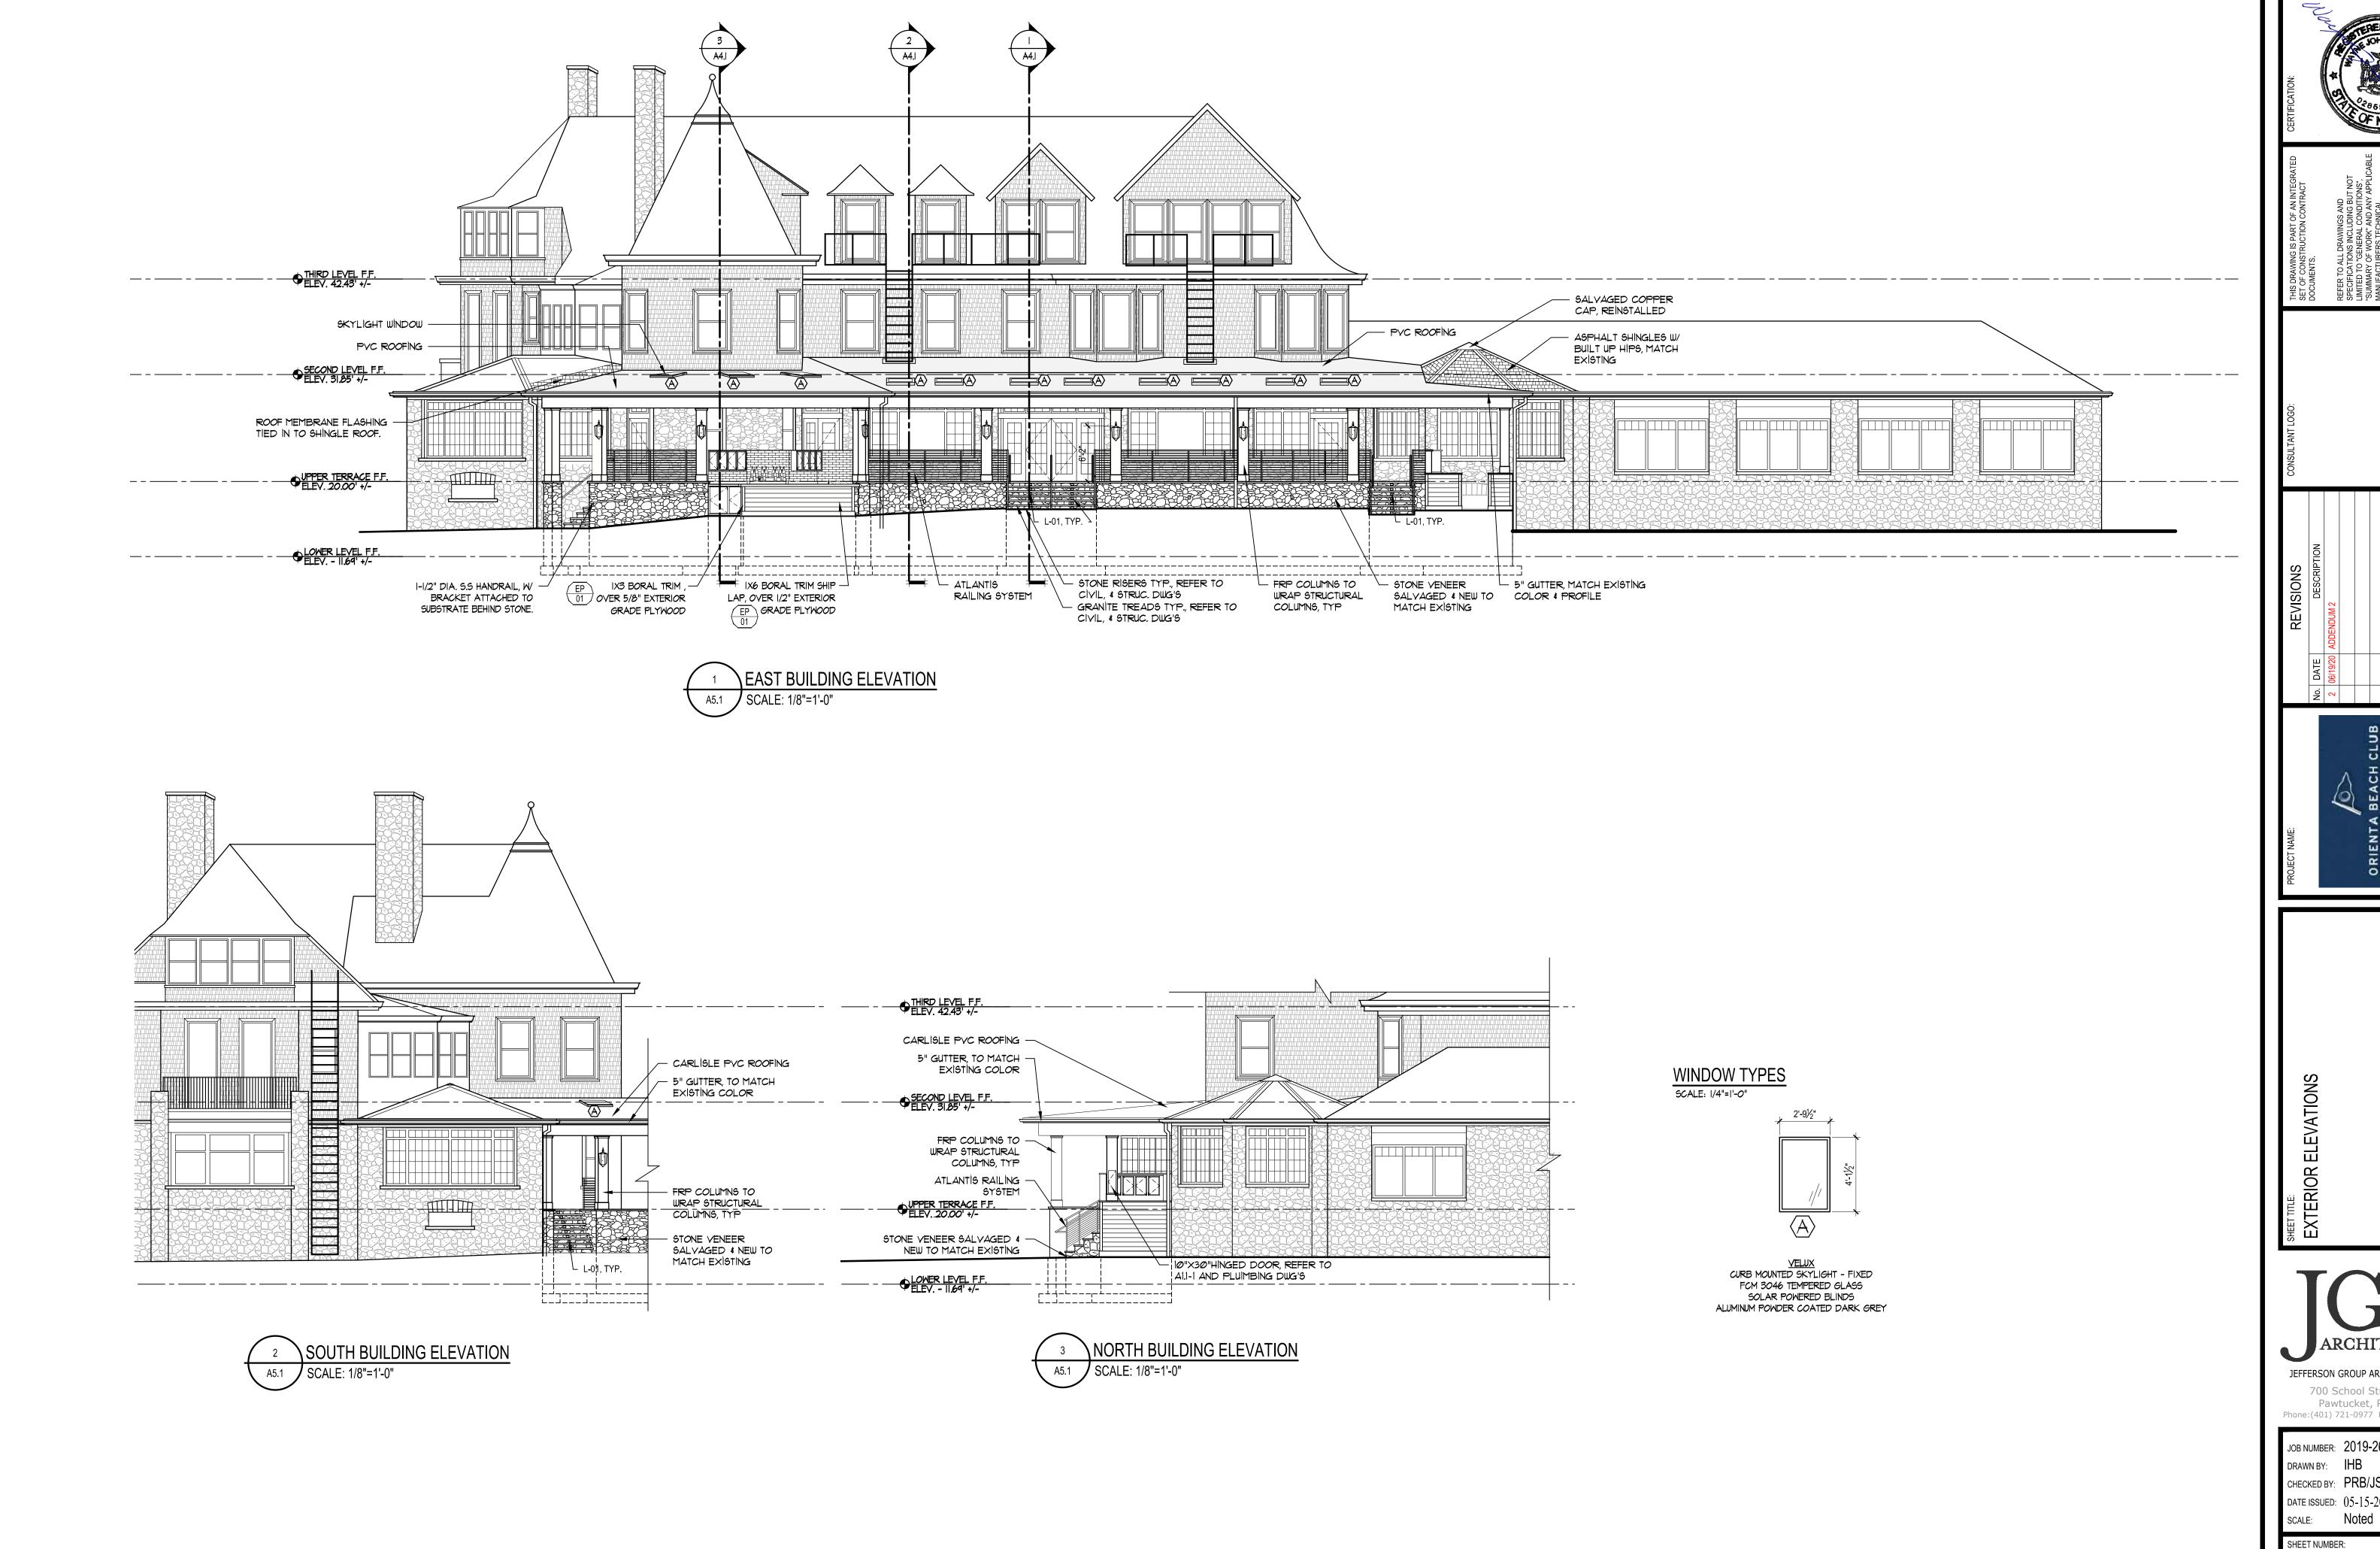


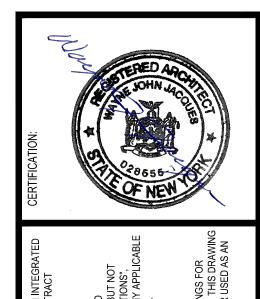

JEFFERSON GROUP ARCHITECTURE, INC. 700 School Street Unit 2 Pawtucket, RI 02860 Phone: (401) 721-0977 Fax: (401) 721-2238

JOB NUMBER: 2019-26 DRAWN BY: IHB CHECKED BY: PRB/JSM DATE ISSUED: 05-15-2020

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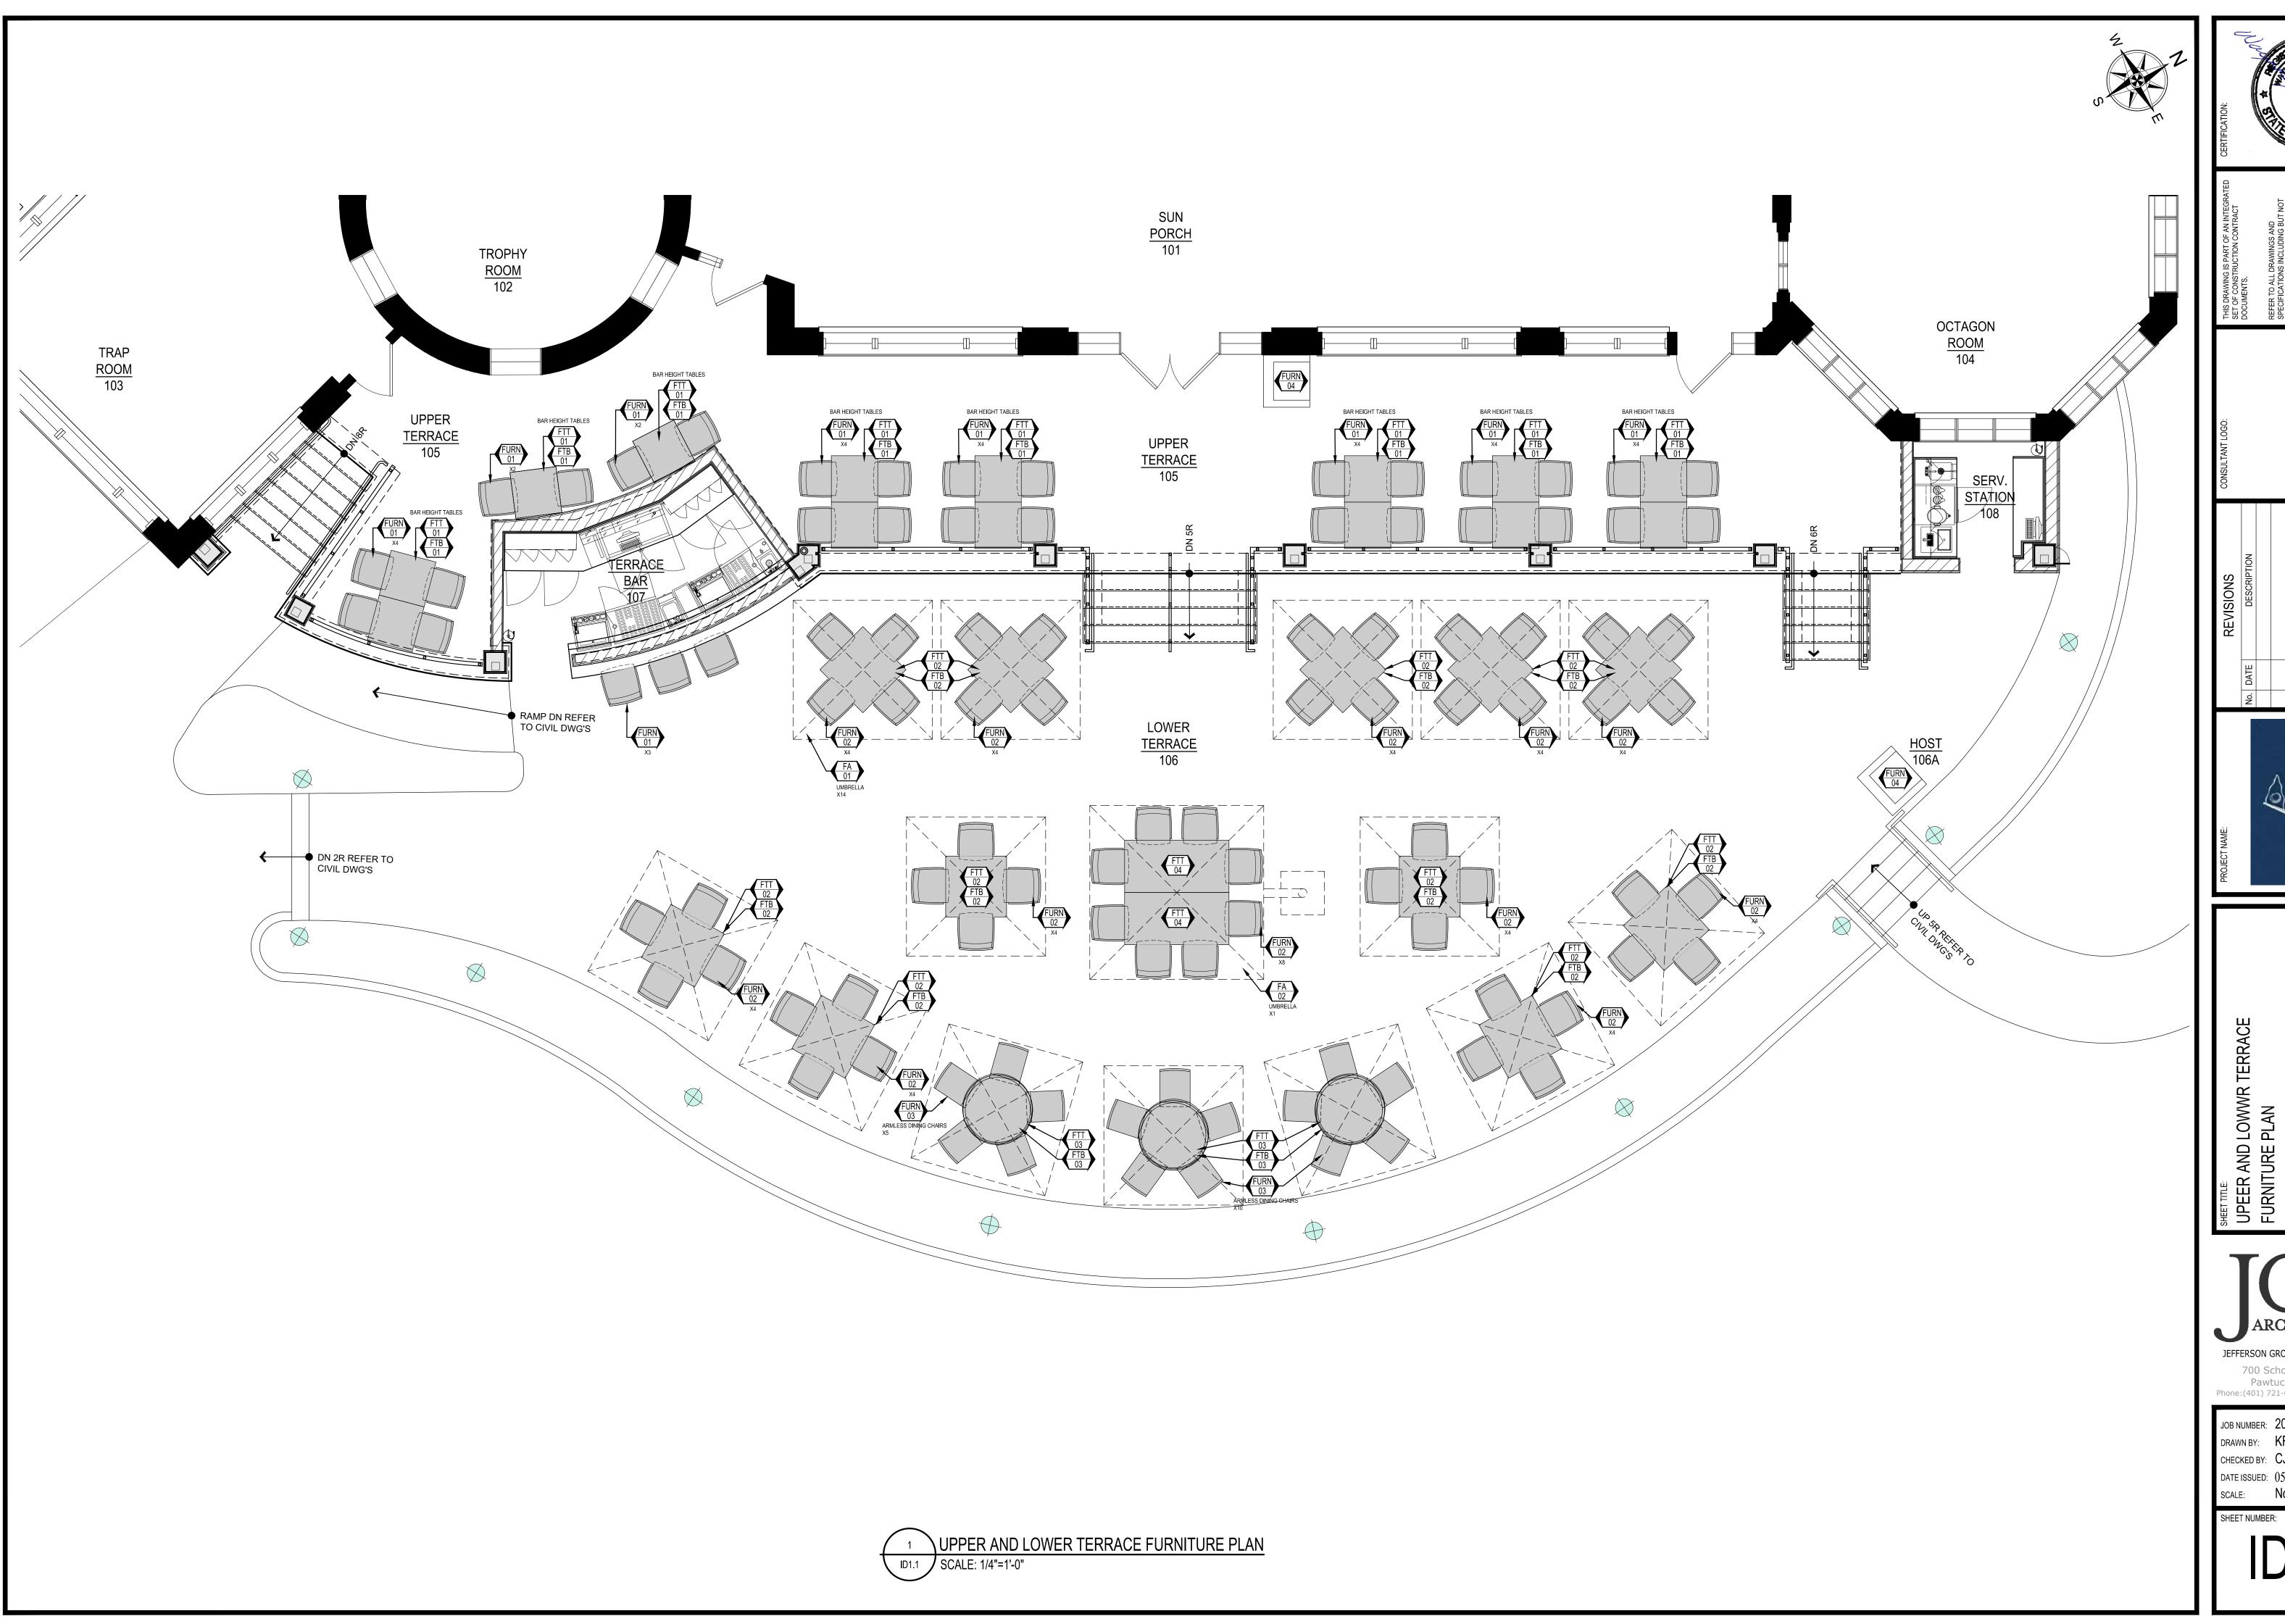


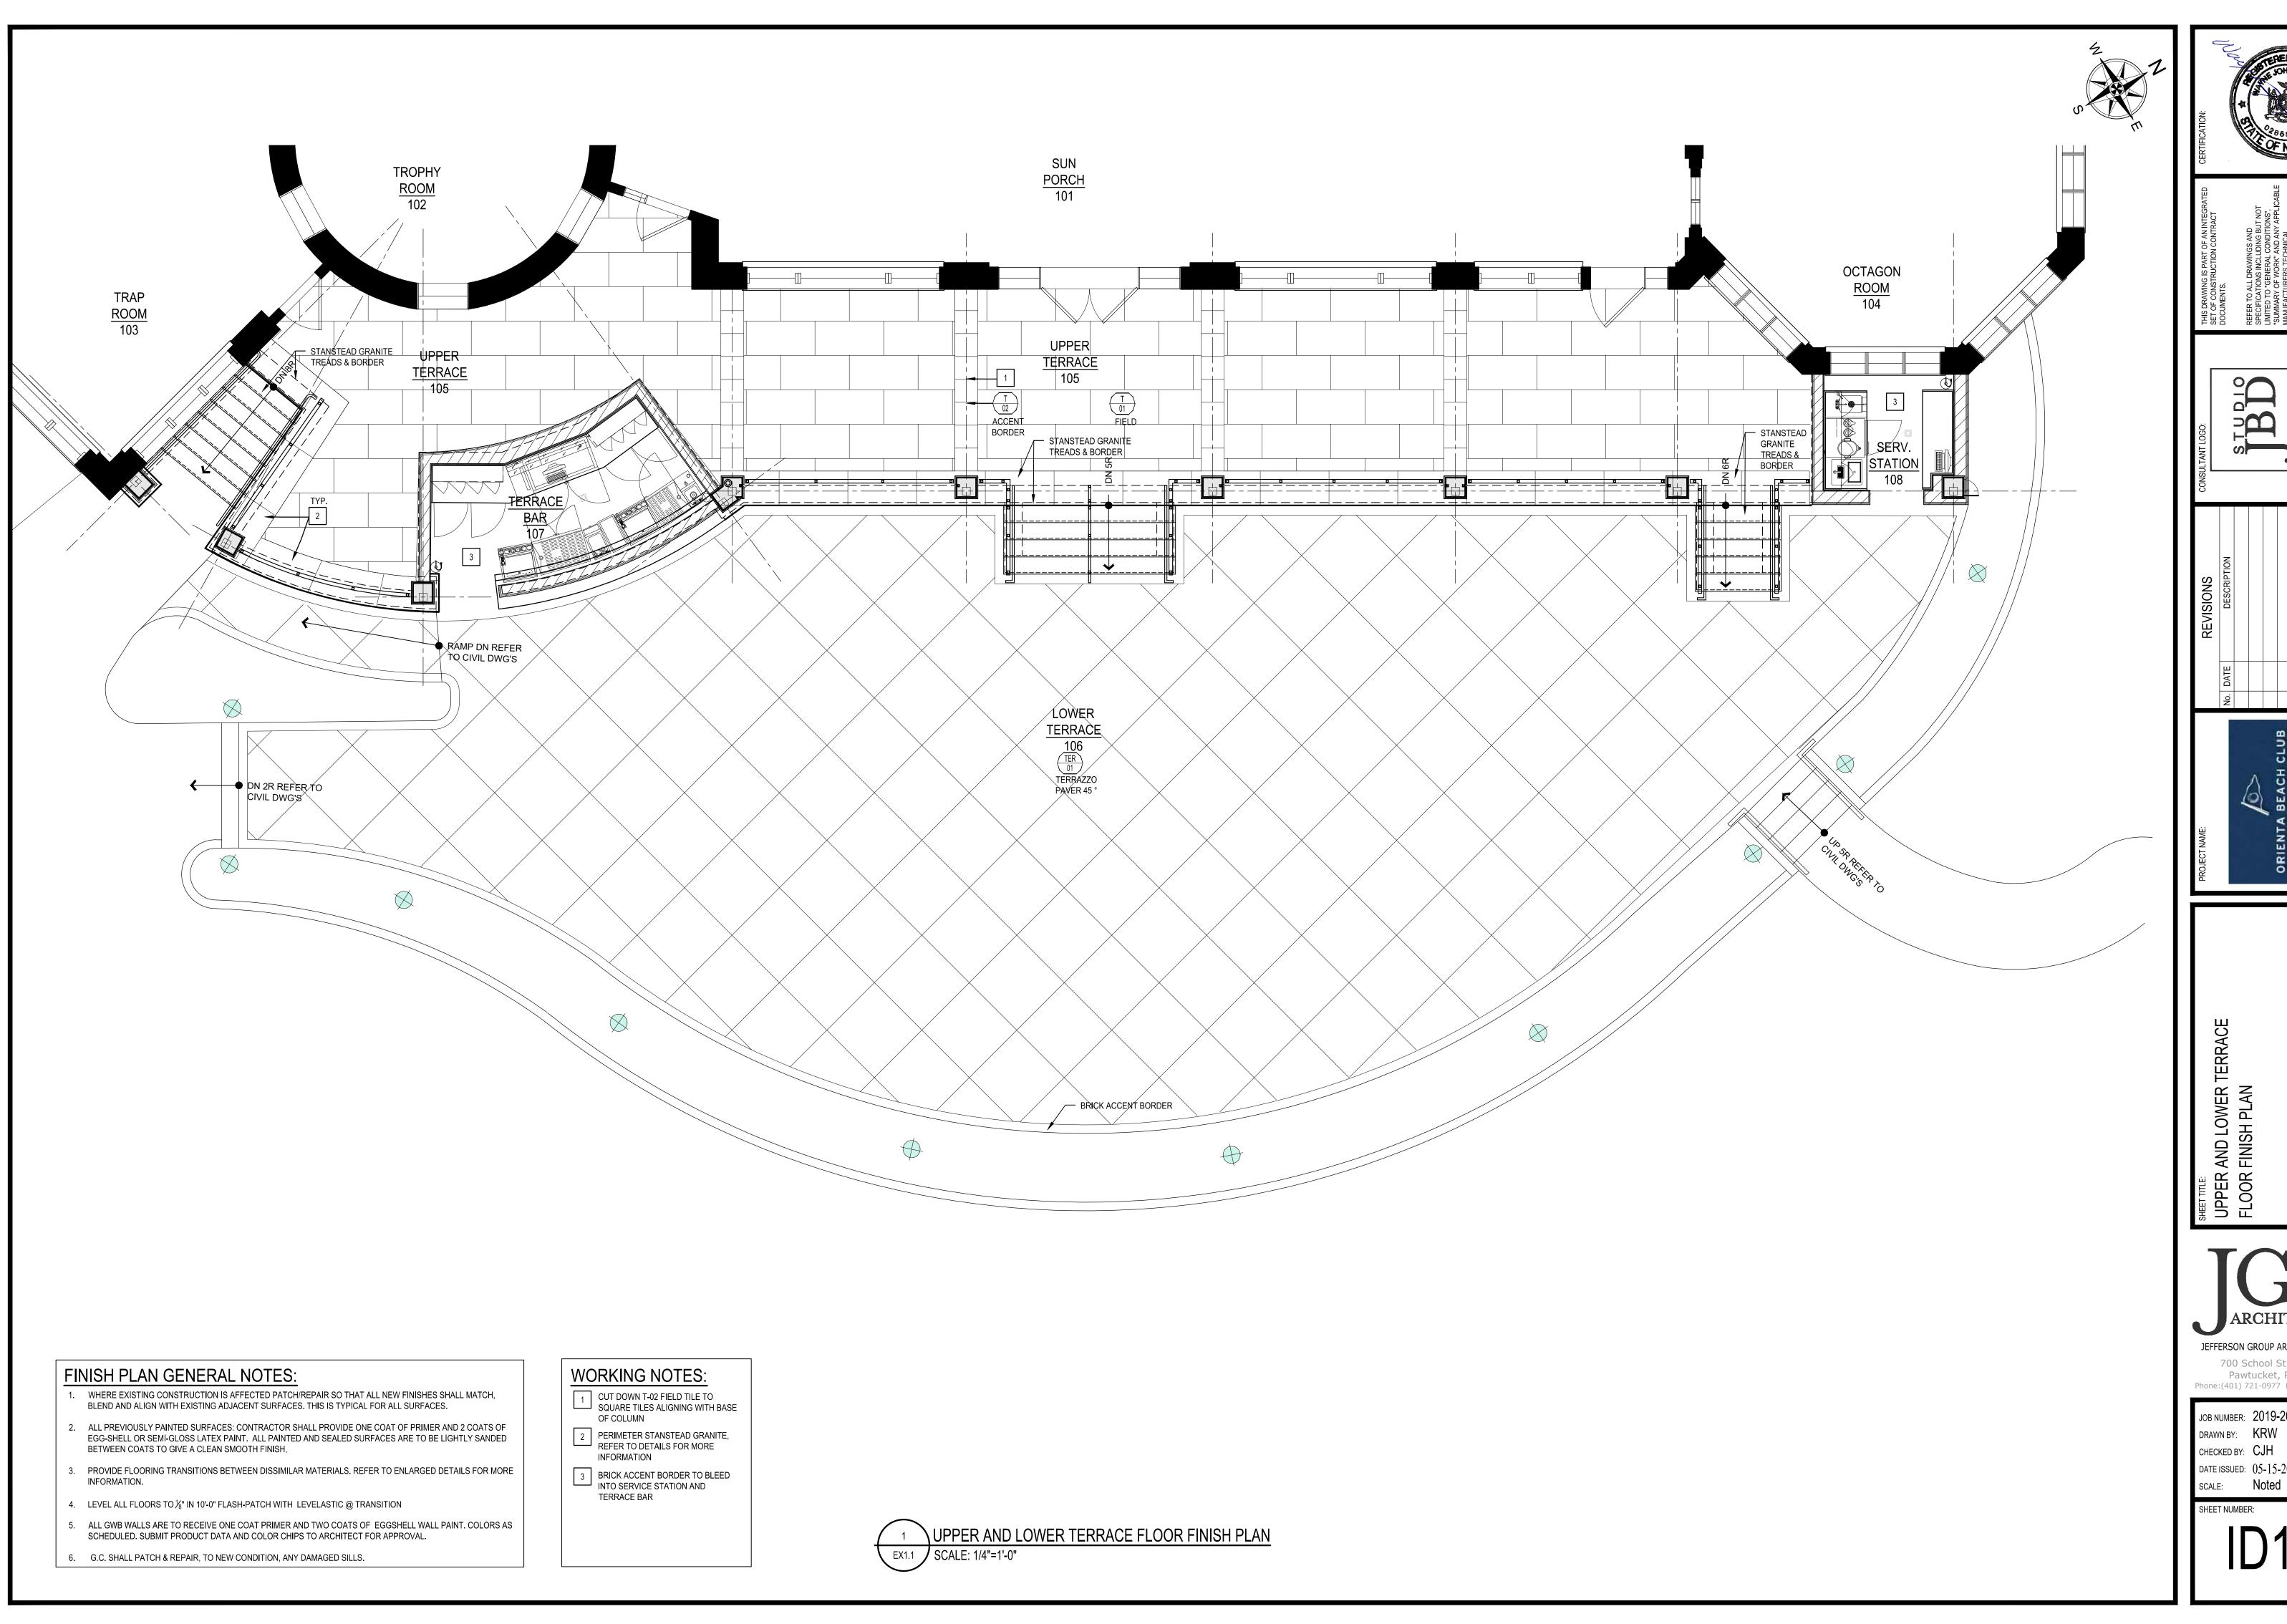UPPER AND LOWER TERRACE FLOOR FINISH PLAN

JEFFERSON GROUP ARCHITECTURE, INC.

700 School Street Unit 2
Pawtucket, RI 02860
Phone:(401) 721-0977 Fax:(401) 721-2238 700 School Street Unit 2

JOB NUMBER: 2019-26 DRAWN BY: KRW CHECKED BY: CJH DATE ISSUED: 05-15-2020







UPEER AND LOWWR TERRACE FURNITURE PLAN


700 School Street Unit 2
Pawtucket, RI 02860
Phone:(401) 721-0977 Fax:(401) 721-2238


JOB NUMBER: 2019-26 DRAWN BY: KRW

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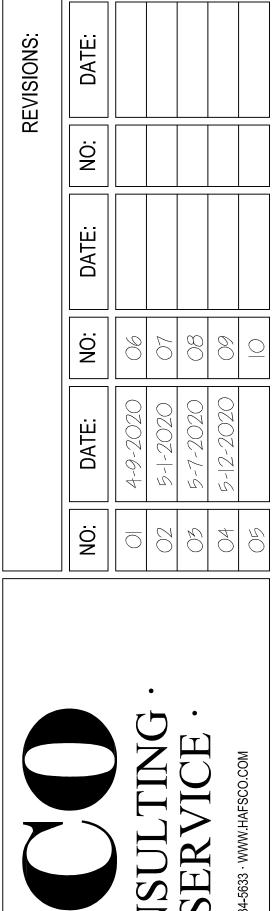


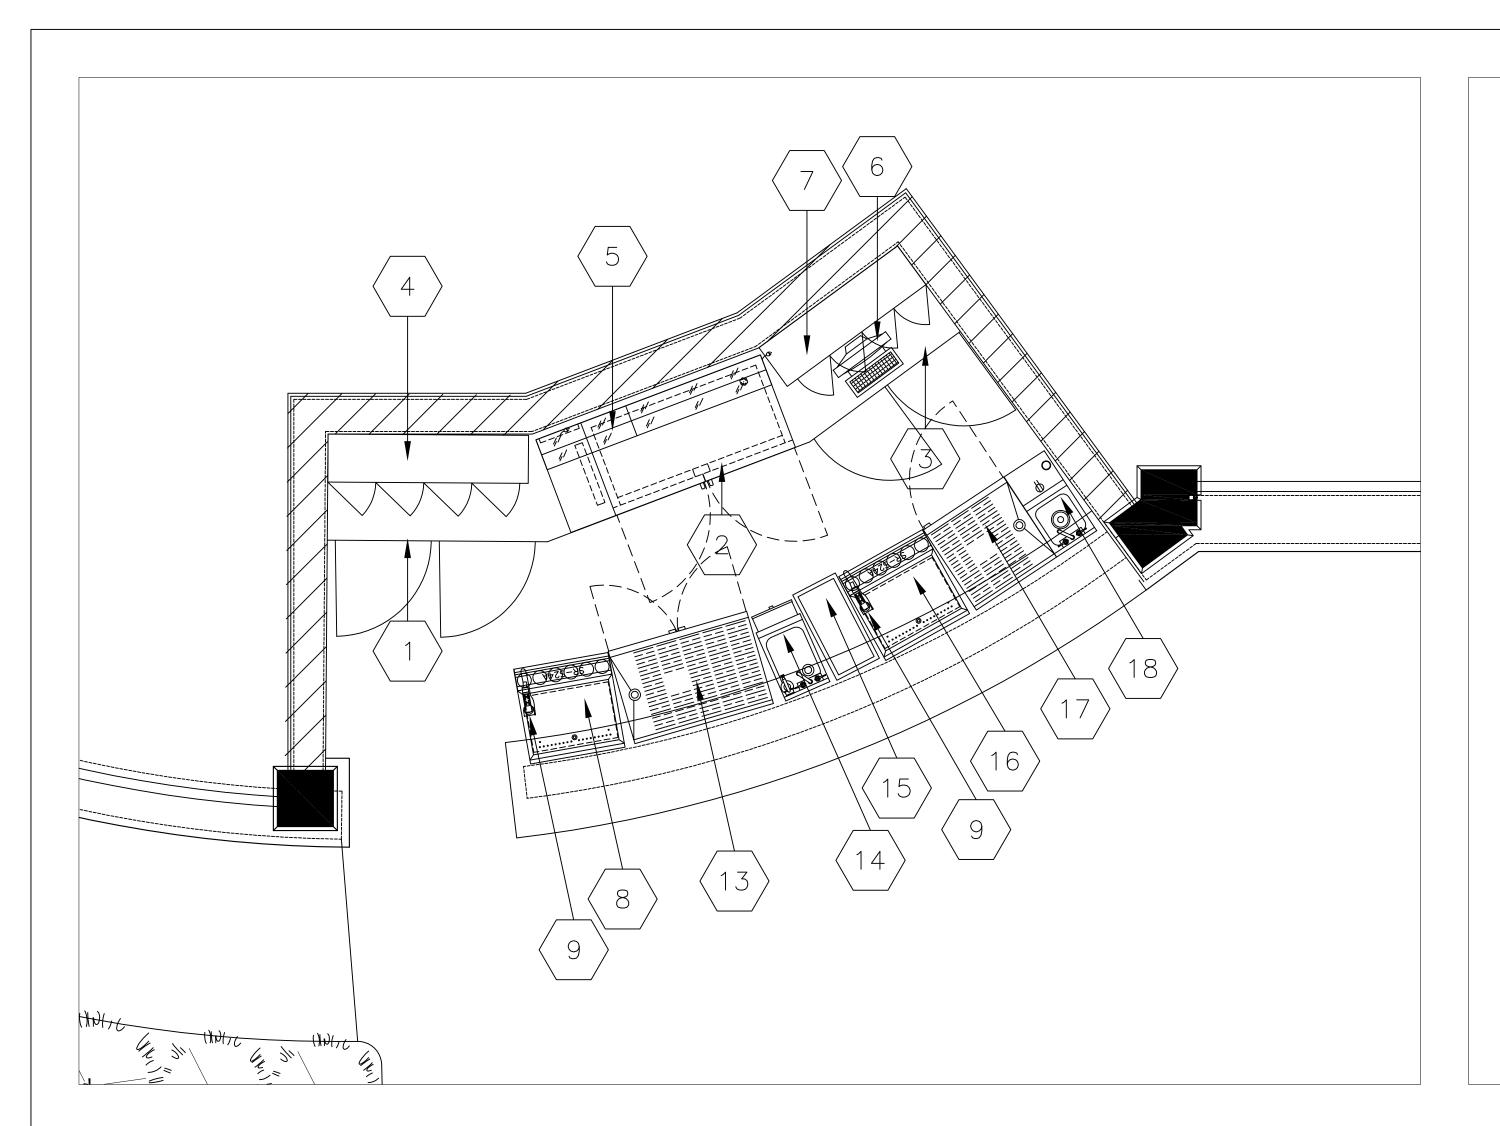

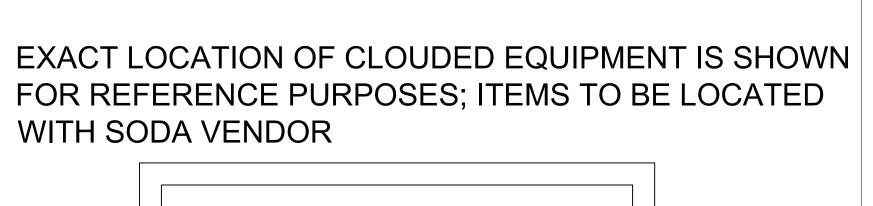

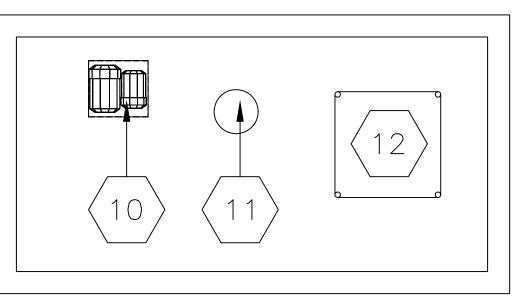
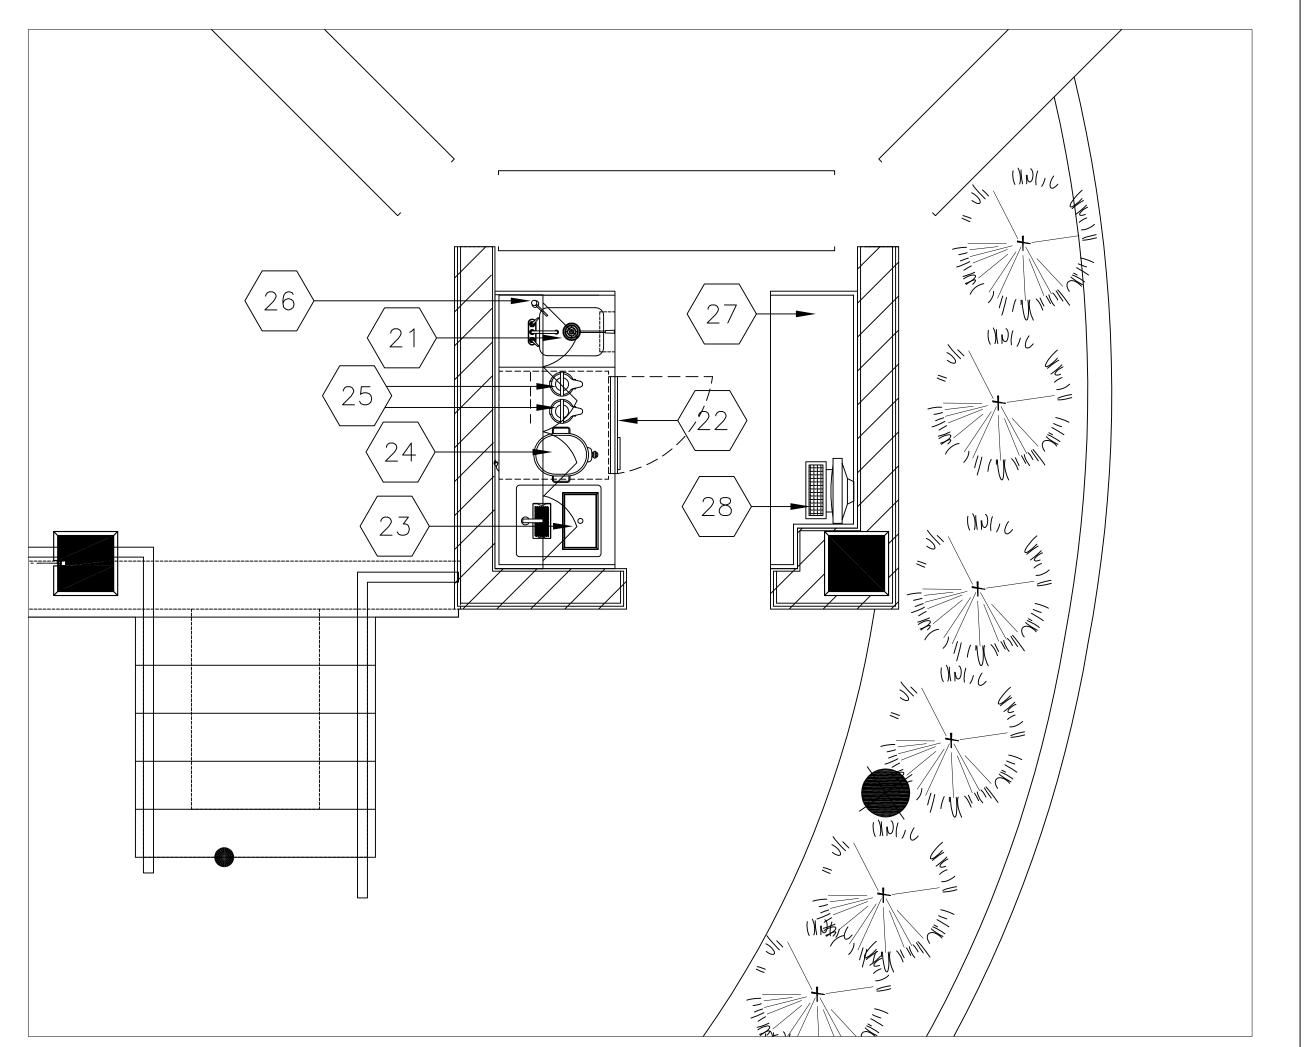
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tem No Qty Equipment Category	Manufacturer	Amps	Volts	Phase	Direct	Cold Water Size (in)	Hot Water Size (in) Direct Drain Size (in)	Indir Drain Size (in)		Item No
1 S/S Semi Enclosed Cabinet w/ Locking Doors	Custom S/S Fabricator								W/ Provisions For Granite Countertop By Others; To Sit On Curb	1
1 60" 2 Door Back Bar Cooler	Perlick	2.5	120	1	X				W/ Provisions For Granite Countertop By Others; To Sit On Curb	2
1 S/S Semi Enclosed Cabinet w/ Locking Doors	Custom S/S Fabricator								W/ Provisions For Granite Countertop By Others; To Sit On Curb	3
1 S/S Wall Mount Upper Cabinet w/ Locking Doors	Custom S/S Fabricator								General Contractor To Provide Wall Blocking	4
1 2 Tier 60" Countertop Lighted Bottle Display	Perlick	1.2	100-240	1	X				To Be Brought Indoors When Not In Use	5
1 POS Terminal	By Others	*	*	*	*				Verify Mechanical Information w/ Vendor	6
1 S/S Wall Mount Upper Cabinet w/ Locking Doors	Custom S/S Fabricator								General Contractor To Provide Wall Blocking	7
1 Underbar Ice Chest w/ Cold Plate & Speed Rail	Perlick							0.5		8
2 Soda Gun	By Soda Co.	*	*	*		*			Vendor To Supply Mechanical Info & Location	9
1 Carbonator For Item # 9	By Soda Co.	*	*	*		*			Vendor To Supply Mechanical Info & Location	10
1 CO2 Tank For Item # 9	By Soda Co.								Vendor To Supply Mechanical Info & Location	11
2 1 Bag N Box Rack For Item # 9	By Soda Co.	*	*	*		*			Vendor To Supply Mechanical Info & Location	12
1 Underbar Storage Cabinet w/ Middle Shelf	Perlick							0.75	W/ Lockable Doors	13
1 Underbar Hand Sink w/ Soap & Towel	Perlick					0.5	0.5 1.5		W/ Splash Guards	14
1 23 Gallon Slim Trash Pail	Winco									15
1 Underbar Ice Chest w/ Cold Plate & Speed Rail	Perlick							0.5		16
7 1 Underbar Storage Cabinet w/ Middle Shelf	Perlick							0.75	W/ Lockable Door	17
3 1 Underbar Blender Station / Dump Sink	Perlick	15.0	120	1	X	0.5	0.5	1.5	W/ Left Splash Guard	18
) 1 ### SPARE ###										19
1										20
1 S/S Semi Enclosed Cabinet w/ Middle Shelf & Han	nd Sink Custom S/S Fabricator					0.5	0.5 1.5		W/ Provisions For Item #'s 22 & 23 & For Granite Countertop By Others; To Sit On Curb	21
1 1 Door Undercounter Refrigerator	Beverage-Air	4.0	120	1	X				W/ Casters	22
1 Drop—In Water & Ice Station	Advance Tabco					0.5		2;1.5		23
1 Portable Iced Tea Dispenser	By Others									24
1 Portable Air Pot Coffee Dispenser	By Others									25
1 S/S Wall Mount Upper Cabinet w/ Locking Doors	Custom S/S Fabricator								General Contractor To Provide Wall Blocking	26
7 1 S/S Semi Enclosed Cabinet w/ Locking Doors	Custom S/S Fabricator									27
8 1 POS Terminal	By Others	*	*	*	*				Verify Mechanical Information w/ Vendor	28



PRIENTA BEACH CLUB
RVICE STATION | EQUIPMENT LAYOUT & SCHEDULE